

Meeting Date: June 24, 2025

Item No.: 4

# **PLAN COMMISSION REPORT**

Proposal:	Site Plan and Architectural Review – Multi-family Residential Building				
Description:	Site, building, and related plan review for a multi-family residential building at 2398 – 2448 W. Colonial Woods Drive.				
Applicant(s):	Jeff Kleiner, Home Path Financial, Limited Partnership				
Address(es):	2348-2398 W. Colonial Woods Dr. (2 <sup>nd</sup> Aldermanic District)				
Suggested Motion:	That the Plan Commission approves the site, building, and related plans for construction of a new multi-family residential building to be located at 2348-2398 W. Colonial Woods Dr., be approved with the following conditions:				
	<ol> <li>That all relevant Code requirements remain in effect.</li> <li>That all mechanicals, transformers, and utilities. All mechanical equipment, transformers, and utility boxes (ground, building and rooftop) shall be screened from view.</li> </ol>				
Owner(s):	Home Path Financial, Limited Partnership				
Tax Key(s):	810-1025-000, 810-1026-000, 810-1027-000, 810-1028-000, 810-1029-000, 810-1030-000, 810-1031-000, 810-1032-000, 810-1033-000, 810-1034-000, 810-1035-000, 810-1036-000, 810-1037-000, 810-1038-000, 810-1039-000, 810-1040-000				
Lot Size(s):	5.4093 acres				
Current Zoning District(s):	Rm-1, Multifamily Residential				
Overlay District(s):	PUD				
Wetlands:					
Comprehensive Plan:	Multi-Family				

Background: In 2006, the Plan Commission approved a site plan for Phase I of the Colonial Woods Condominiums. This phase included three (3) 8-unit residential buildings (Buildings 2–4), four (4) 16-unit residential buildings (Buildings 5, 11–13), and five (5) duplexes (Buildings 6–10). Since then, all three 8-unit

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buildings (Buildings 2–4) and all five duplexes (Buildings 6–10) have been completed. In addition, one 16-unit building (Building 13) has also been constructed. At this time, the Applicant is seeking approval for the construction of Building 5, a 16-unit residential building. This building will include twelve (12) two-bedroom, two-bathroom units and four (4) two-bedroom, three-bathroom units with lofted dens.

As you may recall, the updated plans were reviewed at the March 25, 2025, Plan Commission meeting. At that time, the applicant proposed the development as rental units. However, due to concerns about the proposed rentals conflicting with existing Homeowners Association (HOA) restrictions, the Plan Commission postponed its decision to allow time for the applicant and the HOA to resolve the issue.

The applicant revised the proposal, changing the units from rentals to condominiums, and returned for the May 27, 2025 Plan Commission meeting to seek approval for the site, architectural, and related plans. No other changed were made to the plans since the March 25, 2025 Plan Commission meeting. The Applicant failed to attend the May 27, 2025, and thus was not available to address questions and concerns by the Plan Commission. As a result, it was motioned to hold action to the June 24, 2025 Plan Commission meeting. Again, no changes have been made to the site and architectural plans since the March 25, 2025 review.

District Specific Standards, Use Specific Standards, & Land Use: The proposal complies with the intent, standards, and requirements of the City's Zoning Ordinance, as well as the bulk and dimensional standards of the Rm-1 Multi-Family Residential District. It also conforms to the approved Colonial Woods Planned Unit Development (Ordinance 2391) from 2006. Additionally, the proposed land use is consistent with the City's Comprehensive Plan.

Design: The proposed building will feature a four-sided architectural design using traditional, durable materials. The façade will be clad in red brick, exceeding the 65% brick façade requirement set by the 2006 Planned Unit Development, and cream-colored fiber cement board separated by a cream-colored Trex trim board. Windows will be included on all sides of the building. The roof will be gabled, covered with gray asphalt shingles. Upper units will have balconies made of Trex posts, railings, and trim board. The proposed design meets the requirements of the Municipal Code for multi-family dwellings.

Screening: The proposed plan also designates the location for two dumpsters at the northeast corner of the building. These dumpsters will be screened by a concrete block enclosure with brick veneer to match the building's exterior. The gate for the enclosure will be made with steel framing and cedar wood boards. No external mechanical units or utilities are specified in the plans at this time. Any ground-mounted, building, and rooftop mechanical units, utility boxes, and transformers shall be screened in accordance with Code. This requirement is included in the recommended conditions of this approval for clarity.

Parking: The minimum parking requirement for multi-family residential buildings is one (1) enclosed space per dwelling unit. For the proposed 16-unit residential building, 16 enclosed parking spaces are required onsite. The Applicant is proposing a total of 30 enclosed parking spaces in the building's lower-level parking garage. Additionally, the Applicant plans to add nine (9) exterior parking spaces to the west of the building. All exterior parking spaces will be striped and paved with asphalt.

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Lighting: Lighting plans and fixture cut sheets have been provided. The Applicant is proposing 26 wall-mounted light fixtures around the perimeter of the front and sides of the building. Of these, 25 fixtures will be black wall lanterns, while one (1) fixture, mounted above the garage entrance, will be black, rectangular, and low-profile. In accordance with the Code, all fixtures must have a color temperature of 3,500 Kelvins or lower. Additionally, the fixtures must be full cutoff, with the light source fully shielded and directed downward. All proposed fixtures will meet these requirements, featuring a color temperature of 3,000 Kelvins and directing light downward.

Engineering and Utility: According to the City Engineering Department, the existing ponds, which were constructed as part of the original development, are designed to accommodate the additional impervious surfaces associated with the proposed Building 5. Therefore, no additional stormwater management will be required. Additionally, the proposed driveway on the public roadway (S. Orchard Way) must adhere to the City's Urban Driveway Approach Detail. The City Utility Department has no concerns. The applicant must comply with all relevant regulations and requirements.

Access: The proposed building will front W. Colonial Wood Drive, an existing private road. This private road will also provide access to the surface parking lot west of the building via an existing driveway. Access to the parking garage will be provided via an access drive off of S. Orchard Way, an existing public road. The site includes an existing concrete sidewalk, allowing for pedestrian access to the building.

**Signage:** No new or additional signage is being proposed as part of this review. Any future signs must comply with the Municipal Code, and the owner or tenant will need to apply for the necessary permits before installing any additional signs on the property.

Environmental: The site contains wetlands; however, no wetlands will be disturbed, and the proposed development will not encroach upon any wetland setbacks. Additionally, the site does not include any other environmentally sensitive areas, such as floodplains or environmental corridors. With the proposed new building, the site will be 42% green space, exceeding the 30% green space requirement.

Landscaping: The Applicant proposes landscaping for the front and exterior side yard foundation areas, including the planting of shrubs as shown in the submitted landscape plan, in accordance with Municipal Code requirements. Additionally, the Applicant plans to plant five (5) shade trees between the sidewalk and W. Colonial Woods Drive.

Since the adjacent uses are multi-family residential, no transitional landscaping is required. Furthermore, as no parking lots are proposed along any adjacent public or private right-of-way, perimeter landscaping for the parking lot is not required. The Applicant's proposed landscape plan meets the City of Oak Creek's landscaping requirements. The Plan Commission may, at its discretion, request additional landscaping on

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the site. As the development site currently contains no trees, a Tree Preservation and Removal Plan is not required.

Fire Department: The Fire Department indicated no concerns. The Applicant must comply with all regulations and requirements of the City of Oak Creek Fire Department.

Review/Options/Alternatives: The Plan Commission has the discretion to either approve the plans as presented, approve them with specified conditions, or disapprove the proposal. In reviewing the request, the Commission will evaluate it in light of the City's Zoning Ordinance and any other relevant information.

The Plan Commission may only approve or approve with conditions if it is satisfied that the proposed project complies with all applicable provisions of the City's Zoning Ordinance, as well as with all adopted plans and policy documents. Any approval with conditions must specify the necessary actions to bring the application into compliance with the City's Zoning Ordinance and its adopted plans and policy documents.

The Plan Commission has the authority to modify any of the site plan review criteria outlined in Sec. 17.0804(g)(3)(a-j) of the City's Zoning Ordinance. However, such modifications require a 3/4 majority vote of the Commissioners present at the meeting and must include supplemental design elements or improvements to compensate for any modifications to the specific standards.

If the request is not approved, the Plan Commissioners are required to provide the relevant Code Sections upon which the denial is based. This will allow the applicant to revise and resubmit the proposal accordingly.

Respectfully submitted & approved by:

Prepared by:

Kristi Laine

Community Development Director

Kristin Saine

Todd Roehl Senior Planner

### Attachments:

Location Map
Narrative (2 pages)
Building, Landscape & Site Plans (14 pages)
Renderings (2 page)
Lighting Plan (4 pages)

# **Location Map** 2350-2390 W. Colonial Woods Dr.



This map is not a survey of the actual boundary of the property this map depicts



0.07 Miles 0.04

Zoning FloodFringe2024 - - Official Street Map 
Floodway2024 2350-2390 W. Colonial Woods Dr. □ Parcels

Community Development





4/29/2025

Attention: Todd Roehl – Senior Planner Transmitting To: City Of Oak Creek

Transmitting Via email: troehl@oakcreekwi.gov

RE: Project Name: Colonial Woods

Subject: Building #5 Colonial Woods

16 Unit Apartment Building

### Todd,

I am writing to formally submit a brief narrative and description of our proposed project for consideration at the upcoming Plan Commission meeting.

The proposed project aims to build one (1) of the three (3) planned 16-unit multifamily residential buildings in the Planned Unit Development known as "Colonial Woods Planned Unit Development". The new developer Home Path Financial, LP intends to sell the individual units within these buildings as condos (16 individually owned condos per building). The site is currently vacant land adjacent to the previously developed multi-family buildings.

Our plan includes thirty (30) below grade parking spaces, sixteen (16) units of living ranging from 1,224 to 1,323 square feet. Eight (8) dwelling units will be located on the first floor and eight (8) dwelling units will be located on the second floor, with third floor mezzanines accessible only from the individual second floor units.

1st floor: (8) 2-bed / 2 bath units 2nd floor: (4) 2-bed / 2 bath units

2nd floor lofts: (4) 2-bed / 3 bath units with lofted den (294 square feet)

Total Units: 16

The project is designed to align with the city's previously approved planned unit development. We believe it will contribute positively to the community by benefits such as economic growth, job creation, housing opportunities and completing the original planned development.

The previously submitted landscape, architectural and engineering drawings were prepared to address any questions or concerns from the commission. Our team is committed to ensuring that this project meets all necessary requirements and enhances the surrounding area.

Please let us know if any additional documentation or details are needed before the meeting. We appreciate your time and consideration and look forward to discussing our proposal further.

Sincerely,
Mike Duffek / President
mduffek@duffekconstruction.com
Duffek Construction







Cc: Jeff Kleiner, CEO, Home Path Financial, jeff@myhomepath.com

Tracie Kleiner, CFO, Home Path Financial, <a href="mailto:tracie@myhomepath.com">tracie@myhomepath.com</a>

Mike Duffek
Duffek Construction, duffekconstruction.com

Andrew Roensch
Duffek Construction, aroensch@duffekconstruction.com



# BUILDING 5 COLONIAL WOODS 16 UNIT APARTMENT BUILDING

S 27TH STREET AND WEST COLONIAL WOODS DRIVE OAK CREEK, WISCONSIN 53154

PLAN COMMISSION SET

DATE: FEBRUARY 7, 2025

CONTACT INFORMATION:

### **ARCHITECTURAL**

QUORUM ARCHITECTS, INC. 3112 West Highland Boulevard Milwaukee, WI 53208 Phone: (414) 265-9265 Fax: (414) 265-9465 Email: chris@quorumarchitects.com

### STRUCTURAL

PIERCE ENGINEERS, INC. 181 N. Broadway Milwaukee, WI 53202 Phone: (414) 278-6060 Fax: (414) 278-6061 Contact: Tom Cowan Email: tcowan@pierceengineers.com

### DRAWING INDEX:

CS COVER SHEET
CS.2 ABBREVIATION, SYMBOLS, BUILDING INFORMATION AND GENERAL NOTES

PROJECT NUMBER: 20116.01.02

**ELECTRICAL** 

GARAGE LEVEL ELECTRICAL PLAN

FIRST FLOOR ELECTRICAL PLAN - LEFT FIRST FLOOR ELECTRICAL PLAN - RIGHT

THIRD FLOOR LOFT ELECTRICAL PLAN

SECOND FLOOR ELECTRICAL PLAN - LEFT SECOND FLOOR ELECTRICAL PLAN - RIGHT

### **ARCHITECTURAL**

OVERALL SITE PLAN LANDSCAPE PLAN

GARAGE LEVEL FLOOR PLAN - OVERALL

FIRST FLOOR PLAN — OVERALL SECOND FLOOR PLAN — OVERALL

FIRST FLOOR ENLARGED PLAN — LEFT FIRST FLOOR ENLARGED PLAN — RIGHT

SECOND FLOOR ENLARGED PLAN — LEFT SECOND FLOOR ENLARGED PLAN — RIGHT

EXTERIOR BUILDING ELEVATIONS FRONT AND BACK EXTERIOR BUILDING ELEVATIONS LEFT AND RIGHT

BUILDING SECTIONS

WALL SECTIONS

WALL SECTIONS AND CONSTRUCTION TYPES

EXTERIOR DETAILS EXTERIOR DETAILS

EXTERIOR DETAILS

SCHEDULES AND DOOR DETAILS

GENERAL NOTES & DESIGN CRITERIA

DESIGN CRITERIA & MINIMUM FASTENER SCHEDULE STRUCTURAL SCHEDULES & ROOF SNOW LOAD PLAN

FIRST FLOOR FRAMING PLAN

SECOND FLOOR FRAMING PLAN

LOFT FRAMING PLAN
ROOF FRAMING PLAN

STRUCTURAL DETAILS STRUCTURAL DETAILS

STRUCTURAL DETAILS

STRUCTURAL DETAILS

STRUCTURAL DETAILS

STRUCTURAL DETAILS

**PRELIMINARY** NOT FOR CONSTRUCTION


Quorum Architects, Inc 3112 West Highland Boulevard Milwaukee, Wisconsin 53208 Phone: 414.265.9265

Fax: 414.265.9465 www.quorumarchitects.com

**BLDG 5 - COLONIAL WOODS** 16 UNIT APARTMENT BUILDING

PLAN COMMISSION SET

roject No.: 20116.01.02 Date: 02/07/25

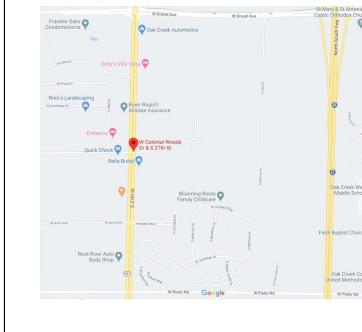

LOCATION MAP:

GOVERNING CODES:
2015 INTERNATIONAL EXISTING BUILDING CODE (IEBC) WITH WISCONSIN AMENDMENTS SPS 366
2015 INTERNATIONAL BUILDING CODE (IBC) WITH WISCONSIN AMENDMENTS SPS 362
2009 ICC/ANSI A117.1 ACCESSIBLE AND USABLE BUILDINGS AND FACILITIES

2015 INTERNATIONAL ENERGY CONSERVATION CODE (IECC) WITH WISCONSIN AMENDMENTS SPS 363

2015 INTERVENIONAL EXECUTION CONSERVATION COURT (INC.) WITH WISCONSIN AMENDMENTS SPS 365 2014 WISCONSIN PLUMBING CORD. SPS 381-381 WISCONSIN AMENDMENTS SPS 365 2011 NPPA NATIONAL ELECTRICAL CODE SPS 381-381 WISCONSIN AMENDMENTS SPS 316

PROJECT DESCRIPTION:

(3) NEW 16-UNIT MULTI-FAMILY DWELLING UNIT OF SAME OR MIRRORED DESIGN WITH
BELOW-GRADE PARKING, PRECAST CONSTRUCTION DECK ABOVE PARKING SEPARATING THE DWELLING
UNITS AND WOOD-FRAME CONSTRUCTION ABOVE GRADE. UNITS ARE SIMILAR IN DESIGN TO EXISTING BUILDING #13 ON SAME STIE. PARKING BELOW—GRADE FOR 30 VEHICLES; B DWELLING UNITS AT FIRST FLOOR AND 8 DWELLING UNITS AT SECOND FLOOR WITH THIRD FLOOR MEZZANINES ACCESSIBLE ONLY FROM THE INDIVIDUAL SECOND FLOOR UNITS.

USE AND OCCUPANCY CLASSIFICATION PER IBC CHAPTER 3
PRIMARY: RESIDENTIAL GROUP R2: APARTMENT HOUSE / CONDOMINIUMS STORAGE GROUP S2: LOW-HAZARD STORAGE / ENCLOSED PARKING GARAGE

FIRE PROTECTION SYSTEMS PER IBC CHAPTER 9
FULL AUTOMATIC SPRINKLER SYSTEM PER NFPA 13R.

FIRE ALARM AND DETECTION SYSTEM PER IBC 907.2.11.2 INTERCONNECTED / HARDWIRED SMOKE ALARMS REQUIRED WITHIN DWELLING UNITS.

LLOWABLE BUILDING HEIGHT IN FEET ABOVE GRADE PER IBC TABLE 504.3 IAXIMUM ALLOWABLE: 60 FEET

ALLOWABLE NUMBER OF STORIES ABOVE GRADE PER IBC TABLE 504.4

MAXIMUM ALLOWABLE: 4 STORIES (GROUP R-2/S13R) ACTUAL NUMBER OF STORIES: 3 STORIES

ALLOWABLE AREA PER FLOOR PER IBC TABLE 506.2

DETERMINED BY SEPARATED USES: S-2 PARKING AND R-2 DWELLING UNITS SEPARATED BY

BATT INSULATION

RIGID INSULATION

GYPSUM BOARD

FINISHED WOOD

CENTER LINE

CONTRACTOR COORDINATE CORRIDOR CARPET

COAT RACK

COURSE CERAMIC TILE

COUNTERSINK

COLD WATER

DEPARTMEN

DIAGONAL DIMENSION DISPENSER DIVISION DEAD LOAD DOWN

DOOR OPENING DAMP PROOFING

DRY STANDPIPE DRAIN TILE

DETAIL (ED)

EXISTING

DRINKING FOUNTA

COPPER CONDENSING UNIT

CUBIC FOOT (FEET)
CUBIC YARD
CABINET UNIT HEATER
CYLINDER

PENNY (NAIL SIZE)

EG EIFS

FXP JOINT

FNGINFFR(

EQUIPMENT

EASEMENT

FLECTRIC FLECTRICAL

EMERGENCY ENCLOSE, ENCLOSURE

ELECTRICAL PANEL

EXPOSED STRUCTURE

EXISTING RELOCATED

ELECTRIC WATER COOLER

EXPAND(ED), EXPANSION EXTERIOR

FABRICATE(D) FIRE ALARM CONTROL

FURNISHED BY OWNER FLOOR CLEAN OUT

CABINET FINISH FLOOR FINISHED FLOOR ELEVATION FINISH GRADE

FIRE ALARM

EJ ELEV ELEC ELT EMER ENCL ENGR EP

FAB FACP

T.O. FLOOR NEW DATUM MARKER

ROUGH CUT WOOD

> <

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10,528 GROSS SF (GROUP S-2) 11,320 GROSS SF (GROUP R-2; INCLUDES COVERED PATIOS AND FIRST FLOOR:

BALCONIES) 11,187 GROSS SF (GROUP R-2) 1,400 GROSS SF (GROUP R-2); ACCESSED ONLY FROM 2ND FLR SECOND FLOOR OF UNITS 202, 203, 206 & 207 34,435 GROSS SF

TOTAL

FIRE-RESISTANCE RATING REQUIREMENTS FOR BUILDING ELEMENTS PER IBC TABLE 601 PRIMARY STRUCTURAL FRAME: 1 HOUR

BEARING WALLS EXTERIOR (TABLE 602): 1 HOUR BEARING WALLS INTERIOR NONBEARING WALLS EXTERIOR:

X ≥ 30 FEET) NONBEARING WALLS INTERIOR 0 HOUR FLOOR AND SECONDARY MEMBERS ROOF AND SECONDARY MEMBERS

OCCUPANT LOAD PER IBC TABLE 1004.1.2

LOWER LVL GROUP S-2 (PARKING) 8,930 SF x 200 SF (GROSS) SF/PERSON = 45 OCCUPANTS LOWER LVL GROUP S-2 (STORAGE) 600 SF x 300 SF (GROSS) SF/PERSON = 2 OCCUPANTS

LOWER LEVEL TOTAL OCCUPANT LOAD = 47 OCCUPANTS

FIRST FLOOR UNITS: (2) UNITS SHARE COMMON ENTRY: 2,400 SF x 200 SF (GROSS) SF/PERSON = 12 OCCUPANTS
SECOND FLOOR UNITS: (2) UNITS SHARE COMMON EXIT STAIR: 2,718 SF x 200 SF (GROSS) (OCCUPANT LOAD AT 2ND FLOOR INCLUDES PORTION OF 3RD FLOOR ACCESS FROM WITHIN UNIT)

EXITING AND EXIT WIDTH LOWER LEVEL

47 OCCUPANTS x 0.2 INCHES/OCCUPANT FOR OTHER EGRESS = 45 INCHES REQUIRED. 68 INCHES PROVIDED

FIRST FLOOR UNITS 12 OCCUPANTS x 0.2 INCHES/OCCUPANT FOR OTHER EGRESS = 2.4 INCHES REQUIRED.

(#)

#

**(#**)

34 INCHES PROVIDED

SECOND FLOOR UNITS
14 OCCUPANTS x 0.3 INCHES/OCCUPANT FOR STAIRS = 4.2 INCHES REQUIRED 36 INCHES MINIMUM PROVIDED

MEANS OF EGRESS: (2) EXITS PROVIDED AT LOWER LEVEL (1) EXIT PROVIDED AT EACH PAIR OF 1ST FLOOR AND 2ND FLOOR DWELLING UNITS PER IBC TABLE 1006.3.2(1).

ALL SLEEPING ROOMS (BEDROOMS) TO HAVE EMERGENCY ESCAPE AND RESCUE OPENINGS PER IBC SECTION 1030 (MIN. 20 INCH WIDE x 24 INCH HIGH NET CLEAR OPENING).

COMMON PATH OF TRAVEL: ≤125 FT FOR GROUP R-2; OCCUPANT LOAD >30; WITH SPRINKLER ≤100 FT FOR GROUP S; OCCUPANT LOAD >30; WITH SPRINKLER

120 LINEAR FEET LONGEST PATH OF TRAVEL FROM FARTHEST CORNER OF 3RD FLOOR LOFT TO EXTERIOR EXIT ACCESS AT GROUND FLOOR INCLUDING STAIRS.

EXIT ACCESS TRAVEL DISTANCE: ≤250 FT FOR GROUP R-2; WITH SPRINKLER SYSTEM ≤400 FT FOR GROUP S-2; WITH SPRINKLER SYSTEM

MINIMUM CORRIDOR WIDTH: 3'-8'', 3'-0'' where occupant load less than 50 & within dwelling unit's interior stars in group R-2 occupancies are not required to provide areas of refuge in buildings equipped with automatic sprinklers per ibc 1009.3, exception 5 & 8

INTERIOR FINISH REQUIREMENTS PER IBC TABLE 803.11
GROUPS R-2 & S: SPRINKLERED
TYPE C AT INTERIOR EATT STARWAYS, RAMPS AND PASSAGEWAYS
TYPE C AT CORRIDORS AND EXIT ACCESS STARWAYS AND RAMPS
TYPE C AT ROOMS AND ENCLOSED SPACES

NOT APPLICABLE

NATURAL NOT IN CONTRACT NOISE REDUCTION COEFFICIENT NUMBER NOMINAL

NOT TO SCALE

OVER OVERALL OBSCURE ON CENTER OUTSIDE

OUISIDE
DIAMETER/DIMENSION
OWNER FURNISHED
CONTRACTOR INSTALLED
OWNER FURNISHED
OWNER INSTALLED
OVERFLOW DRAIN

OVERFLOW SCUPPER

OPPOSITE HAND

OPPOSITE OVERFLOW ROOF DRAIN

OVERHEAD

**OPENING** 

PERIMETER PAGE PANEL JOINT PARKING

PROPERTY LINE

OBS OC OD

OFCI

OFOL

OFD OFF OFS OH OHG OPH OPNG OPP ORD

PLBG PLAM PLAS PLAST PLYWD

16 TOTAL DWELLING UNITS: (1) TYPE A ACCESSIBLE UNIT W, ROLL—IN SHOWER PROVIDED. ALL OTHER UNITS ARE TYPE B PER IBC 1107.6.2.22, AND 1107.7.1.

30 TOTAL PARKING SPACES IN LOWER LEVEL: (2) ACCESSIBLE SPACES PROVIDED. ACCESSIBLE SPACE PER BUILDING PROVIDED. ACCESSIBLE UNIT ON GROUND FLOOR HAVE ACCESSIBLE PATH FROM PARKING, ACCESSIBLE ENTRY AND ACCESSIBLE UNIT ON GROUND FLOOR HAVE ACCESSIBLE PATH FROM PARKING, ACCESSIBLE ENTRY AND ACCESS WITHIN THE UNIT. NO ELEVANT SERVICE PROVIDED TO UNITS AT SECOND FLOOR. THIRD FLOOR ACCESSED ONLY FROM WITHIN UNITS. SANITARY FIXTURES - MINIMUM REQUIREMENTS PER IBC TABLE 2902 BASED ON R-2 RESIDENTIAL APARTMENT HOUSE USE.

WATER CLOSETS
1 PER DWELLING UNIT REQUIRED; 1 PROVIDED

LAVATORIES
1 PER DWELLING UNIT REQUIRED; 1 PROVIDED

BATHTUBS/SHOWERS

1 PER DWELLING UNIT REQUIRED; 1 PROVIDED

DRINKING FOUNTAINS NOT REQUIRED

OTHER FIXTURES

1 KITCHEN SINK PER DWELLING UNIT REQUIRED; 1 PROVIDED

1 AUTOMATIC CLOTHES WASHER CONNECTION PER 20 UNITS REQUIRED; 1 PER UNIT
PROVIDED

Quorum Architects, Inc. 3112 West Highland Boulevard Milwaukee, Wisconsin 53208

**PRELIMINARY** 

BUILDIN

**ARTMENT** 

AP,

9

St & .

WOOI

NOT FOR CONSTRUCTION QUORUM ARCHITECTS, INC.

# **GENERAL SYMBOLS** EXISTING WALLS TO REMAIN

NEW FULL HEIGHT METAL STUD AND GYP.



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**ABBREVIATIONS** 



BOTTOM BRICK RELIEF ANGLE BRIDGING BEARING

BUILT-LIP ROOF(ING)

CENTER TO CENTER CABINET

CONTRACTOR FURNISHED

CONTRACTOR INSTALLED CONTRACTOR FURNISHED

CABLE TELEVISION

CAST IRON
CAST IN PLACE
CIRCLE
CIRCUMFERENCE
CONTROL JOINT
CHALKBOARD
CIRCUIT
CENTER LINE

CONCRETE MASONRY UNIT

CASED OPENING

BOTH SIDES

BEVEL BOTH WAYS

BETWEEN

CONDUIT

CB CEM CER CFCI

CFOI

CI
CIP
CIRC
CIRC
CIRC
CICH
CULG
CLC
CLC
CLC
COND
COND
COND
COND
COND
COND
COND







ABOVE
AIR CONDITIONING
ACOUSTIC
ACOUSTICAL CEILING TILE
ACOUSTICAL CEILING PANEI
AIR CONDITIONING UNIT

ABOVE FINISHED FLOOR

ABOVE FINISHED GRADE AGGREGATE

AIR HANDLING UNIT

ARFA DRAIN

ADDENDUM

ALTERNATE

ANODIZED

ASBESTOS ASPHALT ASSEMBLY

ATTENUATION

BOARD BUMPER GUARD

BITUMINOUS BUTT JOINT

BLOCKING

BOTTOM OF

ACCESS PANEL

ARCHITECT(URAL

APPROXIMATE

DWG INTERIOR ELEVATION MARKER (SINGLE) SHEET INTERIOR ELEVATION MARKER (MULTIPLE) DWG DWG DETAIL MARKER WOOD BLOCKING OR SHIM DWG FNLARGED PLAN OR DETAIL MARKER T.O. FLOOR EXISTING DATUM MARKER HT AFF
TYPE CEILING TYPE MARKER TOP ELEV EXISTING SPOT ELEVATION

BOT ELEV NEW SPOT ELEVATION

EXTERIOR ELEVATION MARKER

**#** PARTITION TYPE <u>/#\</u> REVISION NOTE (#) SIGN OR SIGNAGE TYPE EXISTING COLUMN LINE HEAD NEW COLUMN LINE HEAD 100.00'

FIRE HYDRANT FIRE HOSE CABINET FINISH

FLOOR LINE

FLASHING FLEXIBLE

FLUORESCENT

FACE OF \_\_(ITEM)\_ FACE OF CONCRETE

FACE OF MASONRY FACE OF STUD

PROTECTION FIRE RATED

FULL SIZE FOOT OR FEET

FUTURE FIELD VERIFY

GFRG

FOOTING FURNITURE, FURNISH FURRING

GAUGE
GALLON
GALVANIZED
GRAB BAR
GENERAL CONTRACTOR
GENERAL
GLASS FIBER REINFORCED

CONCRETE
GLASS FIBER REINFORCED
GYPSUM

GLASS GLAZING GLAZE(D)

GALVANIZED IRON

GYPSUM BOARD

HOSE BIB HOLLOW CORE

GRADE GYPSUM WALLBOARD

GROUND

FIREPROOF(ING) FIRE

**DOOR SYMBOLS** CONSTRUCTION NOTE WINDOW OR GLAZING TYPE

HOT/COLD HANDICAP HEADER HARDWOOD HARDWARE HOLLOW METAL HORIZONTAL HORSE POWER HOUR

HEATING

HEATING, VENTILATING AND

INSTALLED BY CONTRACTOR

DIAMETER/DIMENSION

INSULATE(D), INSULATION

INVERT ELEVATION

INCANDESCENT

Janitor Junction Box Joist Joint

KNOX BOX KNOCKED DOWN KITCHEN

KNOCK OUT KNEE SPACE

LAMINATE(D)

H/C HDC HDWD HDWR HM HOR HF HTG HTR HVAC

HW

INCL INFO INSUL INT INV

LAM LAW LAV

ROOM NAME AND NUMBER TAG (ROOM SF AS NEEDED) EXISTING SPOT ELEVATION NEW SPOT ELEVATION

WITHOU' FRAME EXISTING DOOF EXISTING DOOR TO BE REMOVED NEW DOUBLE BI-FOLD DOOR (SINGLE SIMILAR) NEW SLIDING DOOR NEW TRIPLE SLIDING DOOR NEW SINGLE POCKET DOOR NEW DOUBLE POCKET DOOR NEW REVOLVING DOOF

POUND(S)
LABEL
LEADER
LINEAR FOOT
LEFT HAND
LINEAR, LINEAL
LOCKER
LIVE LOAD
LONG LEG VERTICAL
LICHT

LIGHTWEIGHT CONCRETE

MASUNET MATERIAL MAXIMUM MECHANICAL CONTRACTOR MASONRY CONTROL JOINT MOP BASIN MEMBER MEDICINE CABINET MECHANICAL

MEMBRANE MEZZANINE

MISCELLANEOUS

MOP HOLDER

LIGHTWEIGHT

**CEILING SYMBOLS** EXISTING CEILING GRID TO BE REMOVED NEW CEILING GRID GYPSUM BOARD CEILING EXISTING 2x4 LIGHT FIXTURE TO BE REMOVED NEW 2x4 FLUORESCENT LIGHT FIXTURE NEW 2x4 24 HOUR FLUORESCENT LIGHT FIXTURE NEW 2x2 FLUORESCENT LIGHT FIXTURE

NEW SURFACE MOUNTED 2x4 FLUORESCENT LIGHT 0 RECESSED DOWN LIGHT RECESSED DIRECTIONAL DOWN LIGHT PENDANT LIGHT FIXTURE

ROUND ROUGH OPENING RIGHT OF WAY RESILIENT TILE

SUPPORT BRACKET

SCREW

SOLID CORE SEAT COVER DISPENSER

SELECT
SQUARE FOOT (FEET)
SUPPLY GRILLE
SHELF
SHOWER
SHEET
SHOWER
SOUARE INCH
SIMILAR
SULDING
SMOOTH
SUEFT METAL

SHEET METAL SANITARY NAPKIN

DISPENSER

RECEPTACLE

STD

SPECIFICATION

SQUARE
SERVICE SINK
STAINLESS STEEL
STAINLESS STEEL SHELF
SHELF & POLE
STREET
STATION

EXIT LIGHT

XX

PANEL PAINT POINT OF CONNECTION PAIR

POWER ROOF VENTILATOR POUNDS PER SQUARE

POUNDS PER SQUARE INCH

PAPER TOWEL DISPENSER PAPER TOWEL DISPENSER

PAPER TOWEL RECEPTACLE

WITH RECEPTACLE

POLYVINYL CHLORIDE

PAVING PAVEMENT

RESILIENT

RIGHT HAND

QUARRY TOWEL QUANTITY

PRECAST
PREFABRICATE(D)
PREFINISH(ED)
PRELIMINARY
PREDADE

POC PR PRCST PREFAB PREFIN PRELIM PREP PRV PSF

PTD PTDR

PTN PTR PVC PVG PVMT

RA
RAD
RBR
RCP
RD
RDWD
REC
REF
REFRIG
REG
REGUNF
REQU
RESIL
RET

WALL MOUNTED FIXTURE  $\boxtimes$ NEW SUPPLY AIR GRILLE NEW RETURN AIR GRILLE 44 EXISTING EMERGENCY LIGHT 된 EXISTING EMERGENCY LIGHT TO BE REMOVED 44 NEW EMERGENCY LIGHT NEW SPRINKLER HEAD SINGLE POLE SWITCH 3 = 3-WAY D = DIMMER LIGHTING ABBREVIATIONS

N = NEW FIXTURE R = RFUSF SALVAGED FIXTURE

SEATING
STEEL
STORAGE
STRUCTURE, STRUCTURAL
SUSPENDED
SWITCH BOARD

SIDEWALK

SYMMETRICAL

SYNTHETIC SYSTEM

TREAD
TOP AND BOTTOM
TOWEL BAR
TELEPHONE
TELEPHONE
TEMPORARY
TERRAZZO
TERMINATE
TONGUE & GROOVE
TRANSFER GRILLE
THICK
THERSHOLD
THERMAL
TACK BOARD

TOP OF \_\_(ITEM)\_\_ TOP OF BEAM TOP OF CONCRETE OR

TOP OF MASONRY
TOP OF PAVEMENT
TOP OF STEEL
TOP OF WALL
TOILET PAPER DISPENSER

UNDER COUNT REFRIG. UNDERWRITERS LABORATORY UNFINISHED

UNFINISHED UNLESS NOTED OTHERWISE URINAL

CURB TOP OF FOOTING

STG STL STOR STRUCT SUSP SW SWLK SY SYM SYN SYS

TOF TOM TOP TOS TOW TPD TS

WALL SCONCE

E = EXISTING TO REMAIN
D = REMOVE AND SALVAGE FOR

YRD

XFMR

VFNT

URINAL SCREEN

WITH WATER CLOSET

WOOD
WINDOW
WIDE FLANGE
WATER HEATER
WROUGHT IRON
WITHOUT

WATER RESISTANT WORK STATION

VARIABLE AIR VOLUME VITREOUS CLAY PIPE

SUILDING SOLONIA 6 UNIT A  $\mathbf{G}$ 

2

VINYL COMPOSITION 1 VESTIBULE VINYL TILE
VENT THROUGH ROOF
VINYL WALL COVERING

ABBREVIATIONS, SYMBOLS BUILDING INFORMATION AND

02/07/2025 Drawn By: CLR/CGH

Sheet No.

GENERAL NOTES

Project No.: 20116.01.02


CS.2

A/C
AC
ACT
ACP
ACU
AD
ADDL
ADDM
ADJ
AFF
AFG
AGGR
AHU
ALT
ANO
APPROX

ARCH ASB ASPH ASSY ATTEN AUTO AUX AV AVG AWP

BACK OF CURB BOTTOM OF FOOTING



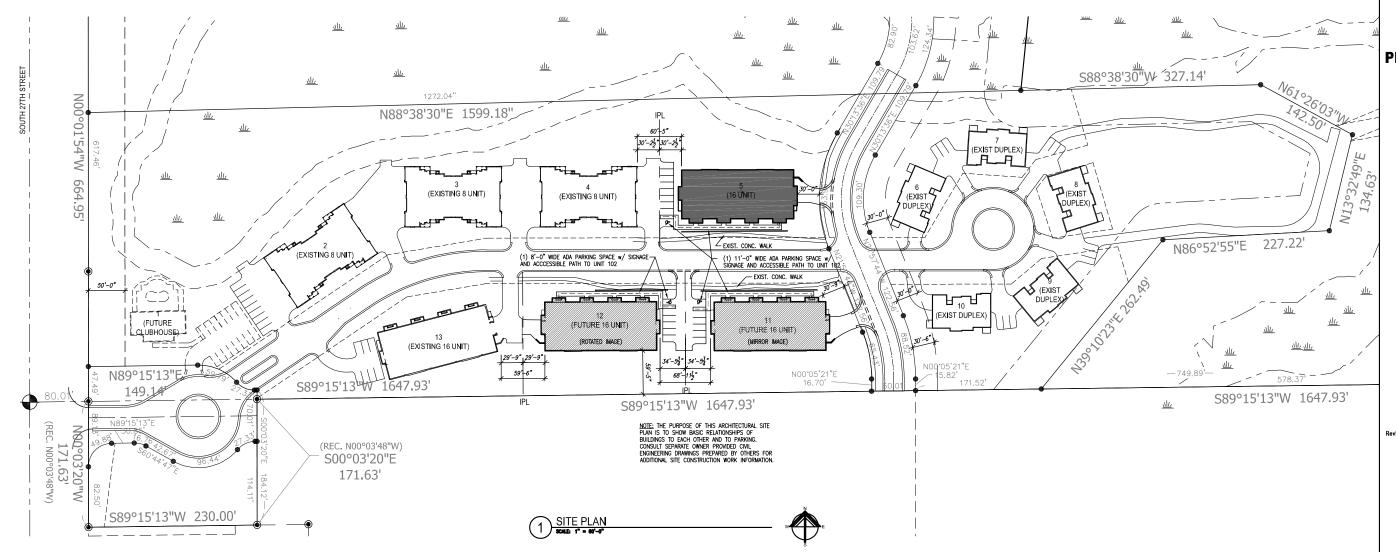

**PRELIMINARY** 

NOT FOR CONSTRUCTION QUORUM ARCHITECTS, INC.

BUILDING 5 COLONIAL WOODS 16 UNIT APARTMENT BUILDING S 27th St & West Colonial Woods Dr. Oak Creek, Wisconsin 53154

Revisions:

Sheet Name: OVERALL SITE PLAN

02/07/2025 Drawn By: CLR/CGH

Sheet No.

C1.0

PLAN	PLANT SCHEDULE - BUILDING 5							
SYMBOL	CODE	QTY	COMMON NAME	BOTANICAL NAME	ROOT	REMARKS		
TREES								
	GD2	5	STREET KEEPER® HONEY LOCUST	GLEDITSIA TRIACANTHOS INERMIS 'DRAVES'	8' B&B OR 25 GAL CONT.			
SYMBOL	CODE	QTY	COMMON NAME	BOTANICAL NAME	ROOT / CONT	REMARKS		
SHRUBS								
	CF2	14	ARCTIC FIRE® RED TWIG DOGWOOD	CORNUS STOLONIFERA 'FARROW'	5 GAL.			
0	CR2	24	RUBY SPICE SUMMERSWEET	CLETHRA ALNIFOLIA 'RUBY SPICE'	5 GAL.			
0	НА	15	ANNABELLE HYDRANGEA	HYDRANGEA ARBORESCENS 'ANNABELLE'	5 GAL.			
E	LR	24	KODIAK® ORANGE DIERVILLA	DIERVILLA X 'G2X88544'	5 GAL.			

### GENERAL LANDSCAPE NOTES

- 1. CHAIT ASSENCE

  APPOINT GUILT, SSE, CHAIS, SPDES, MO WESTY OF PLANS RECURIT, COMPUTED WITH PURDUEL REQUIREMENTS IN MIS ZOLO. IN MEASUREMENT AND RECURSE ACCORDING TO ACE ZOLO. IN OUT PRINCE TO GRAIN RECURSED SIZES.

  DELETERS, STORIES, AND IMPOLING THE SHOP AND ACCORDING TO MEASUREMENT AND RECURSE AND IMPOLING STORIES IN MESSAGE AND IMPOLING STORIES IN MESSAGE, MISS OF OTHER STORIES, MIS

- BY FED MESSIFEMENTS EROPE PROCESSING WITH A WARMS WORK.

  R-PUNTAIN RESTRICTIONS PLAND FILING OF OF THE FOLIOMINE PROCESS CONTINUE PLANDING FERRORS WITH MANNIFACT PROCESS OF THE PROCESSING WARDSHAVE FOR DUBBE OF SUSSESSING COMPLETE.

  1. ECCOLOUS TREES AND SHURBS: APRIL 1 TO SEPTEMBER 30

  2. FEDERMALS: MY 15 TO SEPTEMBER 30

  C. DO NOT INSTALL HAVE MANEFALLY BEM MEMORIT SUPPORTURES MY ORD RESUN 30 ESCHESS 7 OR NISE AROVE SO DESPEES 7 OR MEN WER ELECTRICS EXECUTED 30 APRIL 100 ESCHESS 7 OR MEN WER ELECTRICS EXECUTED 30 APRIL 100 ESCHESS 7 OR MEN WER ELECTRICS EXECUTED 30 APRIL 100 ESCHESS 7 OR MEN WER ELECTRICS EXECUTED 30 APRIL 100 ESCHESS 7 OR MEN WER ELECTRICS EXECUTED 30 APRIL 100 ESCHESS 7 OR MEN WER ELECTRICS EXECUTED 30 APRIL 100 ESCHESS 7 OR MEN WER ELECTRICS EXECUTED 30 APRIL 100 ESCHESS 7 OR MEN WER ELECTRICS EXECUTED 30 APRIL 100 ESCHESS 7 OR MEN WER ELECTRICS EXECUTED 30 APRIL 100 ESCHESS 7 OR MEN WER ELECTRICS EXECUTED 30 APRIL 100 ESCHESS 7 OR MEN WER ELECTRICS EXECUTED 30 APRIL 100 ESCHESS 7 OR MEN WER ELECTRICS EXECUTED 30 APRIL 100 ESCHESS 7 OR MEN WER ELECTRICS EXECUTED 30 APRIL 100 ESCHESS 7 OR MEN WER ELECTRICS EXECUTED 30 APRIL 100 ESCHESS 7 OR MEN WER ELECTRICS EXECUTED 30 APRIL 100 ESCHESS 7 OR MEN WER ELECTRICS EXECUTED 30 APRIL 100 ESCHESS 7 OR MEN WER ELECTRICS EXECUTED 30 APRIL 100 ESCHESS 7 OR MEN WER ELECTRICS EXECUTED 30 APRIL 100 ESCHESS 7 OR MEN WERE ADDRESS AND 100 ESCHESS 7 OR MEN WERE THE 100 ESCHESS 7 OR ME
- Coordination with Turf Areas (Lawns): Plant Trees, Shrubs an other Plants After Finish Grades are established and before Planting Turf Areas United Thermose Indicated.

### PLANTING NOTES

- 1. AVAILABLE RESET INTO TESTILLERS DIRECTLY TO SERVICE BEFORE
  OF STREED DEPOSIT, APRIL SEE, AND SEED OF STREET, AND SEED OF STREET, APRIL SEE, AND SEED OF STREET, AND SEED OF STREET, AND SEED OF SEE
- WILL ST ON UNDSTAIRED MAKE SOIL TO PREVENT SETTLING.

  S. JABSOIL AND TOPSOIL REMOVED FROM EXCAMPIONS MAY NOT BE
  USED AS PLAYING SOIL.

  5. THEE AND SHRUE PLAYING

  A REFORE PLAYING, VEREY THAT ROOT FLARE IS VISIBLE AT TOP OF
  ROOT BALL ACCORDING TO ANSI 280.1.
- B. REMOVE STEM GROLING ROOTS AND KINKED ROOTS. REMOVE INJURED ROOTS BY CUTTING CLEANLY; DO NOT BREAK. C. SET BALLED AND BURLAPPED STOCK PLUMB AND IN CENTER OF PLANTING PIT OR TRENCH WITH ROOT FLARE 2 INCHES ABOVE ADMICHT FINSH GRADES AND USE PLANTING SOIL FOR BACKFUL.

- D. PUNIT ALL TREES SUGHTLY HIGHER THAN FINSHED GRADE AT ROOT FLARE. BACK FILL HOLE WITH 2/3 EXISTING SOIL, 1/3 PEAT MOSS. AVOID ANY AIR POCKETS. DISCARD ANY GRAVEL, CLAY, OR STONES.
  - E. ALL SHRUBS TO BE POCKED PLANTED WITH A 50/50 MIX OF PLANT STARTER AND EXISTING SOIL.
  - STAFTER AND EXISTING SOIL.

    F. SET CONTAINER-GROWN STOCK PLUMB AND IN CENTER OF PLANTING PIT OR TRENCH WITH ROOT FLAKE 1 INCH ABOVE ADJACENT FINSH GRADES AND USE PLANTING SOIL FOR BACKFILL.

  - GROUGS AND USE FLANTING DUT, FOR BUCKFILL.

    FROME SE'-FORMETS MUCH INSECTION SHOWS ALL UNIN TREES

    IN ALL SHOUL BEEN RECEAR A 2-3" LINTER OF SHEEDED HANDLOOD

    BANK MUCH OF BORNE HANDROOM, DOE ALL BELLENS WITH
    A "FEED SHOWL SHAPED DOE.

    FEED HANDLOOD SHOW HEED GROUND COMES, AND ANNUAL FLANTINGS

    A SET OUT AND SHOLE BROADD COMES AND FAMILS OTHER THAN
    THEES, SHOWS, AND WEST HEY LANTING TAM.
  - INCES, STRUMEN, MAIN MEET PER TURNING FUND.

    B. ALL ARREST FOR SECRET & BLEND OF ORGANG SOL. AMENOMENTS
    PRORT TO PLANTING. ROTOTILL THE FOLLOWING MATERIALS INTO
    EVISITING TOPSOL. TO A DEPTH OF APPROX. 8<sup>21</sup>. (MOTE
    PROFORMING AND QUANTITIES MAY REQUIRE ADJUSTMENT DEPENDING
    ON COMMITTION OF DISTINGS OF
  - Condition of Existing Soil.)

    PER EVERY 100 SOUARE FEET AID:
    ONE 2 CU. FT. BALE OF PEAT MOSS
    2 LBS. OF 5-10-5 GARDEN FERTILIZER
    ONE CU. YARD OF COMPOSTED MANURE
    OTHER COMPOSTED,ORGANIC MATERIAL.

  - QUALITY SEED MIX WHICH WILL GENOMINE QUICKLY.

    PLANTING AREA MULCHING

    A. INSTALL WEED-CONTROL BARRERS BEFORE MULCHING ACCORDING TO MANUFACTURER'S WRITTEN INSTRUCTIONS. COMPLETELY COVER AREA TO BE MALCHEN, OVERLAPPING EDIESS A MINIMUM OF 6 INCHES AND SECURE SEAMS WITH CALLANZED DIESS.
  - SOURCE SHOPPILED SHIPMARS OF PLANTING AREA AND OTHER AREAS BROCKED IN SECTION 2.5 KEEPING 4 BICKES FORM TRAINS OF STENS.

    9. ALL PLANTING TO BE WATERED AT TIME OF PLANTING, THROUGHOUT CONSTRUCTION AND UPON COMPLETION OF PROJECT AS REQUIRED.



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BUILDING 5 COLONIAL WOODS 16 UNIT APARTMENT BUILDING S 27th St & West Colonial Woc Oak Creek, Wisconsin 53154


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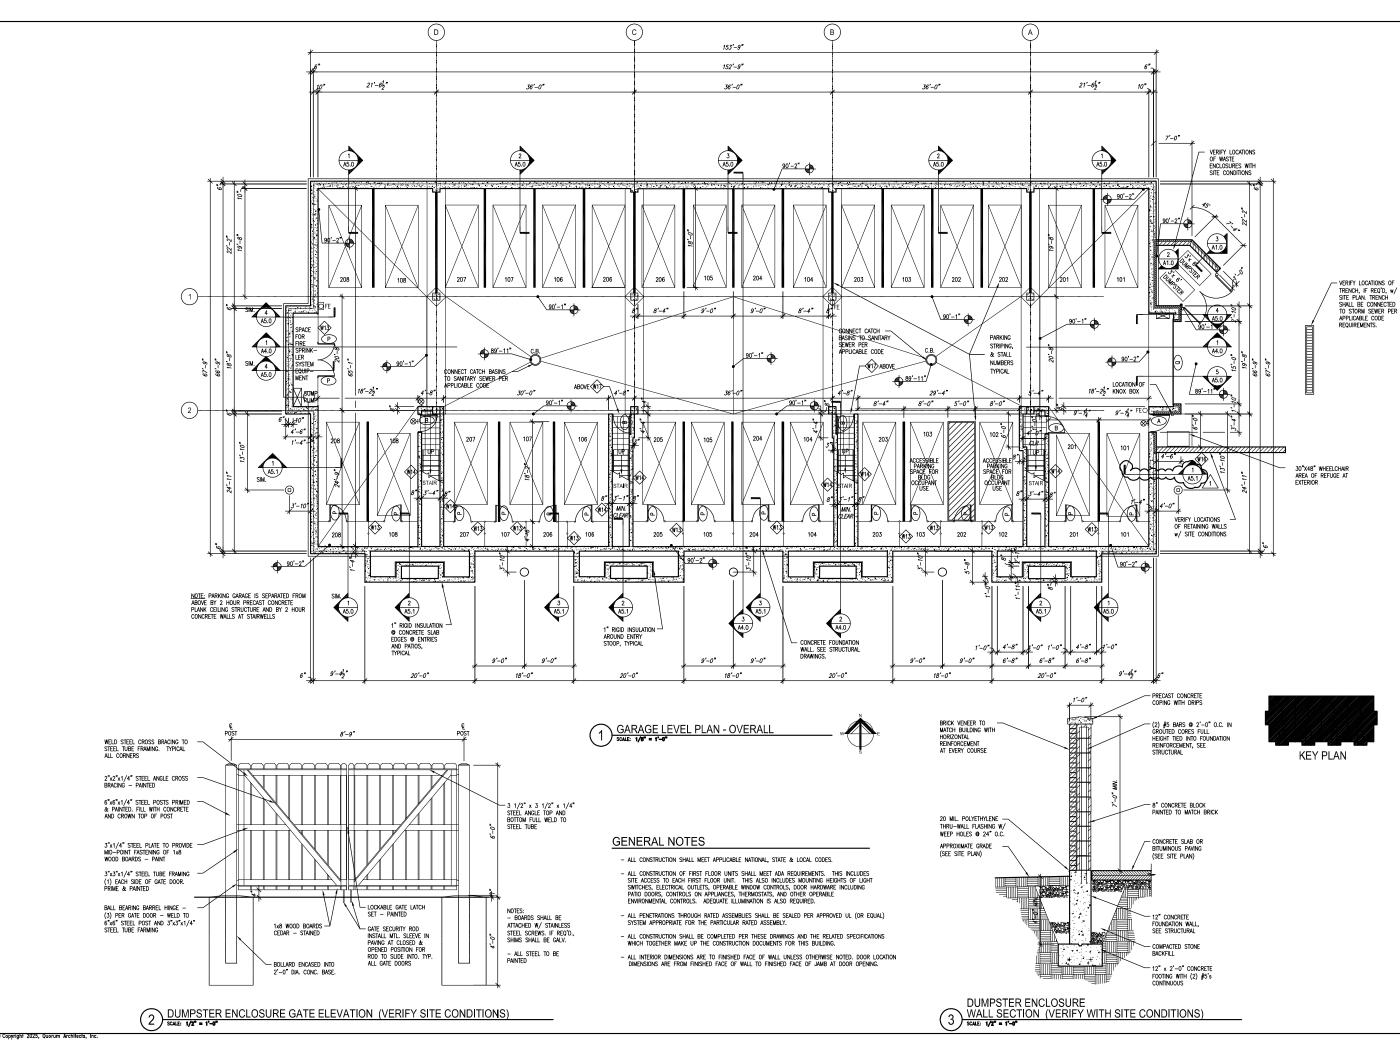
Sheet Name: LANDSCAPE PLAN

02/07/2025 Drawn By: CLR/CGH

Project No.: 20116.01.02 Sheet No.

L1.0



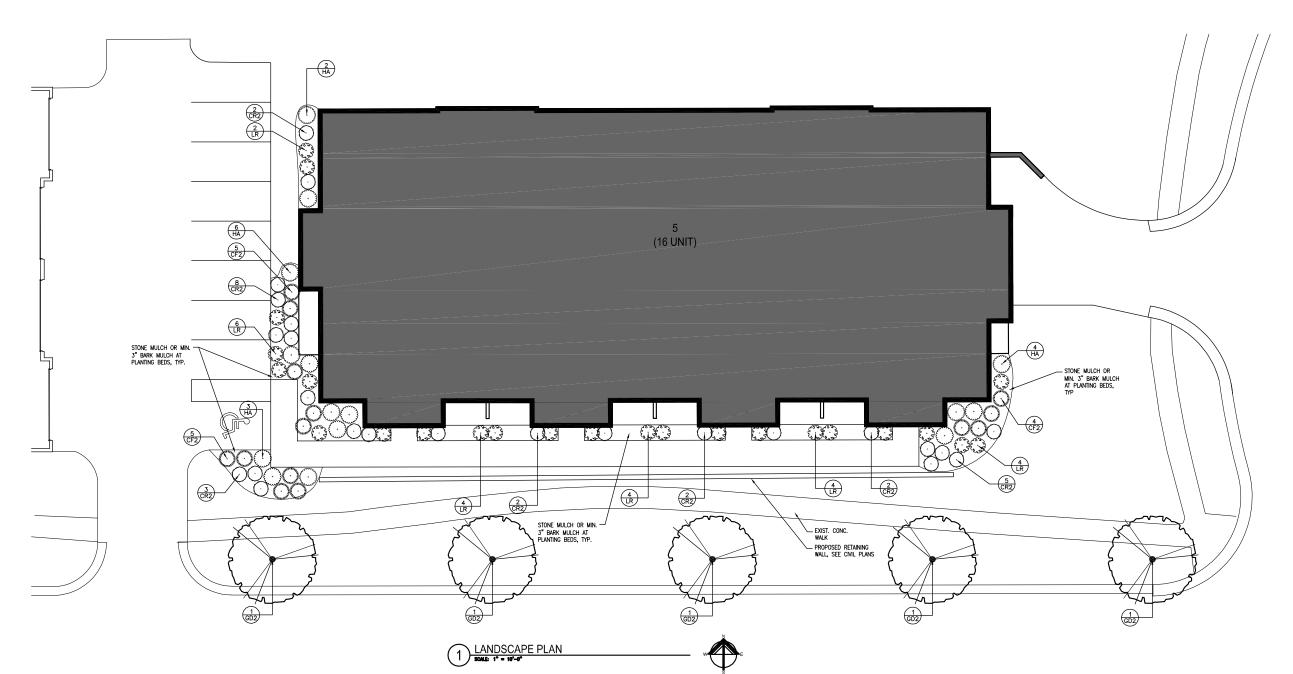



# **PRELIMINARY**

NOT FOR CONSTRUCTION QUORUM ARCHITECTS, INC.

# BUILDING 5 COLONIAL WOODS 16 UNIT APARTMENT BUILDING S 27th St & V Oak Creek, 1

Revisions: ADDENDUM #1 03/07/2025

GARAGE LEVEL FLOOR

02/07/2025

PLAN - OVERALL

CLR/CGH Project No.: 20116.01.02

Sheet No.

A1.0

- ALL CONSTRUCTION SHALL MEET APPLICABLE NATIONAL, STATE & LOCAL CODES.
- ALL CONSTRUCTION OF FIRST FLOOR UNITS SHALL MEET ADA REQUIREMENTS. THIS INCLUDES SITE ACCESS TO EACH FIRST FLOOR UNIT. THIS ALSO INCLUDES MOUNTING HEIGHTS OF LIGHT SWITCHES, ELECTRICAL OUTLETS, OPERABLE WINDOW CONTROLS, DOOR HARDWARE INCLUDING PATIO DOORS, CONTROLS ON APPLIANCES, HERMOSTATS, AND OTHER OPERABLE ENVIRONMENTAL CONTROLS. ADEQUATE ILLUMINATION IS ALSO REQUIRED.
- ALL PENETRATIONS THROUGH RATED ASSEMBLIES SHALL BE SEALED PER APPROVED UL (OR EQUAL) SYSTEM APPROPRIATE FOR THE PARTICULAR RATED ASSEMBLY.
- ALL INTERIOR DIMENSIONS ARE TO FINISHED FACE OF WALL UNLESS OTHERWISE NOTED. DOOR LOCATION DIMENSIONS ARE FROM FINISHED FACE OF WALL TO FINISHED FACE OF JAMB AT DOOR OPENING.

# WINDOW TYPES

- 1 3'-0" x 5'-6" SINGLE HUNG WINDOW
- $\langle 2 \rangle$ (2) 3'-0" x 5'-6" SINGLE HUNG WINDOWS
- 3 3'-6" x 5'-0" SINGLE HUNG WINDOW
- (3A) 3'-6" x 5'-0" SINGLE HUNG WINDOW WITH 3'-6" x 1'-2" ARCH TOP
- 4 3'-6" x 6'-2" ARCH TOP FIXED WINDOW

NOTE: ALL OPERABLE WINDOWS MUST MEET EMERGENCY ESCAPE & RESCUE CODE REQUIREMENTS OF 5.7 SQUARE FEET MINIMUM OPENING AREA WITH MINIMUM 2'-0" HEIGHT AND 1'8" MININUM MIDTH DIMENSIONS.

NOTE: PROVIDE 15" WIDE LOUVERED SHUTTERS WITH ARCH TOP, SOLID ARCH TOP, OR FLAT TOP WHERE INDICATED ON ELEVATIONS — SEE SHEETS A3.0 & A3.1.



**PRELIMINARY** NOT FOR CONSTRUCTION QUORUM ARCHITECTS, INC.

BUILDING 5 COLONIAL WOODS 16 UNIT APARTMENT BUILDING S 27th St & V Oak Creek, 1

Revisions: ADDENDUM #1 03/07/2025

**KEY PLAN** 

Sheet Name: FIRST FLOOR PLAN - OVERALL

02/07/2025 Drawn By: CLR/CGH Project No.: 20116.01.02

Sheet No.

A1.1

SECOND FLOOR PLAN - OVERALL

SCALE: 1/8" = 1"-6"

- ALL CONSTRUCTION SHALL MEET APPLICABLE NATIONAL, STATE & LOCAL CODES.
- ALL CONSTRUCTION OF FIRST FLOOR UNITS SHALL MEET ADA REQUIREMENTS. THIS INCLUDES SITE ACCESS TO EACH FIRST FLOOR UNIT. THIS ALSO INCLUDES MOUNTING HEIGHTS OF LIGHT SWITCHES, ELECTRICAL OUTLETS, OPERABLE WINDOW CONTROLS, DOOR HARDWARE INCLUDING PATIO DOORS, CONTROLS ON APPLIANCES, HERMOSTATS, AND OTHER OPERABLE ENVIRONMENTAL CONTROLS. ADEQUATE ILLUMINATION IS ALSO REQUIRED.

**GENERAL NOTES** 


- ALL PENETRATIONS THROUGH RATED ASSEMBLIES SHALL BE SEALED PER APPROVED UL (OR EQUAL) SYSTEM APPROPRIATE FOR THE PARTICULAR RATED ASSEMBLY.
- ALL CONSTRUCTION SHALL BE COMPLETED PER THESE DRAWINGS AND THE RELATED SPECIFICATIONS WHICH TOGETHER MAKE UP THE CONSTRUCTION DOCUMENTS FOR THIS BUILDING.
- ALL INTERIOR DIMENSIONS ARE TO FINISHED FACE OF WALL UNLESS OTHERWISE NOTED. DOOR LOCATION DIMENSIONS ARE FROM FINISHED FACE OF WALL TO FINISHED FACE OF JAMB AT DOOR OPENING.

### WINDOW TYPES

- 3'-0" x 5'-6" SINGLE HUNG WINDOW
- (2) 3'-0" x 5'-6" SINGLE HUNG WINDOWS
- 3'-6" x 5'-0" SINGLE HUNG WINDOW
- $\boxed{3A}$  3'-6" x 5'-0" SINGLE HUNG WINDOW WITH 3'-6" x 1'-2" ARCH TOP
- 4 3'-6" x 6'-2" ARCH TOP FIXED WINDOW

NOTE: ALL OPERABLE WINDOWS MUST MEET EMERGENCY ESCAPE & RESCUE CODE REQUIREMENTS OF 5.7 SQUARE FEET MINIMUM OPENING AREA WITH MINIMUM 2'-0" HEIGHT AND 1'8" MININUM WIDTH DIMENSIONS.

 $\underline{\text{NOTE:}}$  Provide 15" wide Louvered Shutters with Arch top, solid Arch top, or flat top where indicated on elevations — see sheets A3.0 & A3.1.

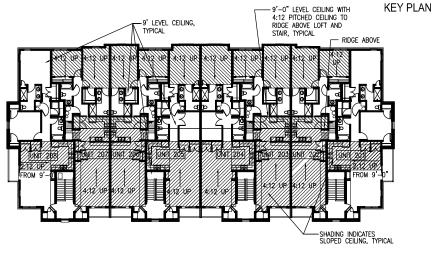

2 CATHEDRAL CEILINGS PLAN SCALE: N.T.S.



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NG 5 IIAL WOODS T APARTMENT BUILDING

S 27th St & West Colonial Woods Dr. Oak Creek, Wisconsin 53154

BUILDING E COLONIAL 16 UNIT AP


ADDENDUM #1 03/07/2025

Sheet Name: SECOND FLOOR PLAN - OVERALL

Date: 02/07/2025
Drawn By: CLR/CGH
Project No.: 20116.01.02

Sheet No.

A1.2

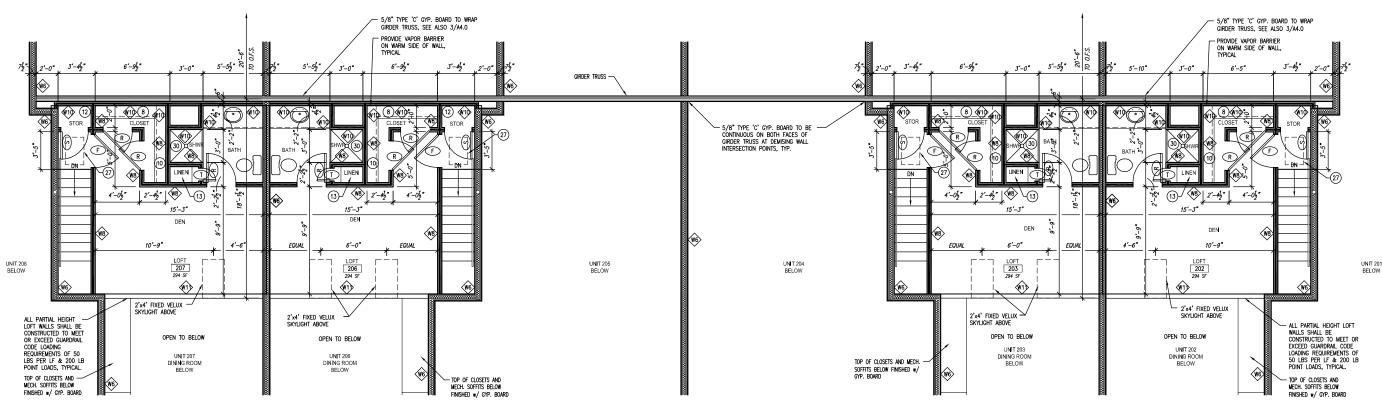

THIRD FLOOR LOFT PLAN - OVERALL

NOT FOR CONSTRUCTION QUORUM ARCHITECTS, INC.

# AL WOODS APARTMENT BUILDING ഗ S WOODS WT-VIE

BUILDING ( COLONIAL 16 UNIT AP

Revisions:

St & \ reek,

**PRELIMINARY** 

Quorum Architects, Inc 3112 West Highland Boulevan Milwaukee, Wisconsin 53208

(5) BLOCKING FOR (FUTURE) GRAB BARS (IN FIRST FLOOR UNITS)

ONE POLE @ 48" AFF & TWO 12" DEEP SHELVES ABOVE

FIVE 18" DEEP SHELVES ON ADJUSTABLE BRACKETS

HVAC SUPPLY DUCT RUN ABOVE CEILING ENTIRE LENGTH OF UNIT, TYP. THIS FLOOR

1'-6" x 2'-8" RETURN GRILLE IN SIDE WALL - VERIFY SIZE WITH MECH. 18

ONE POLE @ 36" AFF & ONE @ 72" AFF w/ 14" DEEP SHELF ABOVE EACH

23) FRIGIDAIRE ELECTRIC STACKABLE WASHER & DRYER WITH LOUVERED EXHAUST & RIGID

Install a maximum 3/4" high threshold (from the exterior side) of the patio door to comply with ada requirements for any current or future unit

FAN ABOVE, SEE 2/A4.0 AND ELECTRICAL PLANS.

20"x30" (1) HR RATED ATTIC ACCESS PANEL ABOVE

CAULK AT BRICK AROUND PERIMETER OF FRAMING PENETRATION

3'-0" x 5'-0" SHOWER UNIT

30 3'-0" x 3'-0" SHOWER UNIT

(31) INSTALL GYP. BOARD BEFORE SETTING TUB/SHOWER UNIT, TYPICAL

**GENERAL NOTES** 

- ALL CONSTRUCTION SHALL MEET APPLICABLE NATIONAL, STATE & LOCAL CODES.

- ALL CONSTRUCTION OF FIRST FLOOR UNITS SHALL MEET ADA REQUIREMENTS. THIS INCLUDES SITE ACCESS TO EACH FIRST FLOOR UNIT. THIS ALSO INCLUDES MOUNTING HEIGHTS OF LIGHT SWITCHES, ELECTRICAL DUTLETS, OPERABLE WINDOW CONTROLS, DOOR HARDWARE INCLUDING PATIO DOORS, CONTROLS ON APPLIANCES, HIERMOSTATS, AND OTHER OPERABLE ENVIRONMENTAL CONTROLS. ADEQUATE ILLUMINATION IS ALSO REQUIRED.

ALL PENETRATIONS THROUGH RATED ASSEMBLIES SHALL BE SEALED PER APPROVED UL (OR EQUAL) SYSTEM APPROPRIATE FOR THE PARTICULAR RATED ASSEMBLY.

- ALL CONSTRUCTION SHALL BE COMPLETED PER THESE DRAWINGS AND THE RELATED SPECIFICATIONS WHICH TOGETHER MAKE UP THE CONSTRUCTION DOCUMENTS FOR THIS BUILDING.

ALL INTERIOR DIMENSIONS ARE TO FINISHED FACE OF WALL UNLESS OTHERWISE NOTED. DOOR LOCATION DIMENSIONS ARE FROM FINISHED FACE OF WALL TO FINISHED FACE OF JAMB AT DOOR OPENING.

INTERIOR WALL TYPES (ALL FLOOR LEVELS)

(NG) UL DESIGN NO. U340 − 1 HOUR RATED SYSTEM: - 2x6 BASE & SILL PLATES - 2x4 WOOD STUDS © 24" O.C. EACH SIDE STAGGERED OPPOSITE © 12" O.C. - 7/8" RESULENT FURRING CHANNELS ONE SIDE

- 3 1/2" SOUND ATTENUATION BATT INSULATION STAPLED TO STUDS

- 5/8" TYPE 'C' CYPSUM BOARD EACH SIDE NOTE: USE MOISTURE RESISTANT GWB ON ALL KITCHEN & BATHROOM WALLS.

ACQUISTORL RESIDENT WID ON ALL RIGHTEN & DATINGON WALLS

- ACQUISTORL SEALANT AROUND PARITION PERIMETER, SEE DETAIL 4/A4.0.

- WALL THICKNESS= 7 1/2" NOMINAL

- MINIMUM STC RATING OF 52

WD UL DESIGN NO. U305 - 1 HOUR RATED SYSTEM:
- 2x6 WOOD STUDS @ 16" O.C.
- 7/8" RESULENT FURRING CHANNELS ONE SIDE
- FRICTION FIT 6 1/4"x15 1/4" R-19 UNFACED FIBERGLASS BATT INSULATION - 5/8" TYPE 'C' GYPSUM BOARD EACH SIDE

- 3/6 TIPE C GIPSOM BOARD EACH SIDE
- ACOUSTICAL SEALANT AROUND PARTITION PERIMETER, SEE DETAIL 4/A4.0.
- WALL THICKNESS= 7 1/2" NOMINAL
- STC RATING OF 56

₩8 - 2x4 WOOD STUDS @ 16" O.C. MAX.

- 1/2" GYPSUM BOARD EACH SIDE - WALL THICKNESS= 4 1/2" NOMINAL

W9 - 2x6 WOOD STUDS 
16" O.C. MAX.
1/2" GYPSUM BOARD EACH SIDE
WALL THICKNESS= 6 1/2" NOMINAL

Output

Description

16" O.C. MAX.
17" OVER 15" OUTput

16" O.C. MAX.
17" OVER 15" OUTput

18" OUT

- 2x4 WOOD STUDS @ 16" O.C. MAX.
- 1/2" GYPSUM BOARD ON ONE SIDE
- WALL THICKNESS= 4" NOMINAL

- SAME AS W8 BUT ONLY 3'-6" | WITH WOOD CAP & COVE TRIM (SEE 5/A6.1 SIM.)

SAME AS W8 BUT TO HEIGHT OP PLASTIC LAMINATE COUNTERTOP W13 - CHAINLINK FENCE W/ 2" DIA.

PIPE AND GATE. (SEE 3/A5.1) √19 - 2 HOUR RATED 8" CONCRETE

₩10 - 12" CONCRETE BLOCK RETAINING WALL

√1) - 2 HOUR RATED 8" CONCRETE BLOCK

CONSTRUCTION NOTES (ALL FLOOR LEVELS)

1) PROVIDE RAISED FLR FOR HEATING & COOLING UNIT-SEE HVAC DESIGN SPACE FOR GAS METERS FOR 8 UNITS

3) SPACE FOR ELEC. LOWBOY WATER HEATER w/ FLR DRAIN - SEE PLUMBING

(4) SPACE FOR OWNER'S WATER SOFTENING SYSTEM

SELF SUPPORTING STONE COUNTERTOP WITH REMOVABLE BASE CABINETS ON FULLY FINISHED FLOOR BENEATH.

(7) ONE POLE @ 66" AFF WITH ONE 12" DEEP SHELF ABOVE

ONE POLE @ 54" AFF & TWO 14" DEEP SHELVES ABOVE

ONE POLE @ 36" AFF & ONE @ 72" AFF w/ 12" DEEP SHELF ABOVE EACH

FIVE 12" DEEP SHELVES ON ADJUSTABLE BRACKETS

FIVE 24" DEEP SHELVES ON ADJUSTABLE BRACKETS

FIVE 16" DEEP DECORATIVE SHELVES ON ADJUSTABLE BRACKETS

(15)

(16) DRYER VENT ABOVE, TYP.

(17) 2'-6" x 10" RETURN GRILLE ABOVE DOOR - VERIFY SIZE WITH MECH.

(19) 3'-0"x 5'-0" CLEAR INTERIOR, FULLY ACCESSIBLE ADA SHOWER W/ SEAT (FIRST FLOOR)

20 ONE POLE @ 54" AFF & TWO 24" DEEP SHELVES ABOVE

21

22) 2'-6"x 5'-0" TUB/ SHOWER UNIT

METAL DUCT ALLOWING 40' DUCT RUN

(25) IN WALL BLOCKING AND GRAB BARS TO BE INSTALLED PER ADA REQUIREMENTS.

(26)

(27)

28) 29


LOFT PLAN 02/07/2025 Date: Drawn By: CLR/CGH

Sheet Name: THIRD FLOOR

Project No.: 20116.01.02 Sheet No.

A1.3

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**ROOF NOTES** 

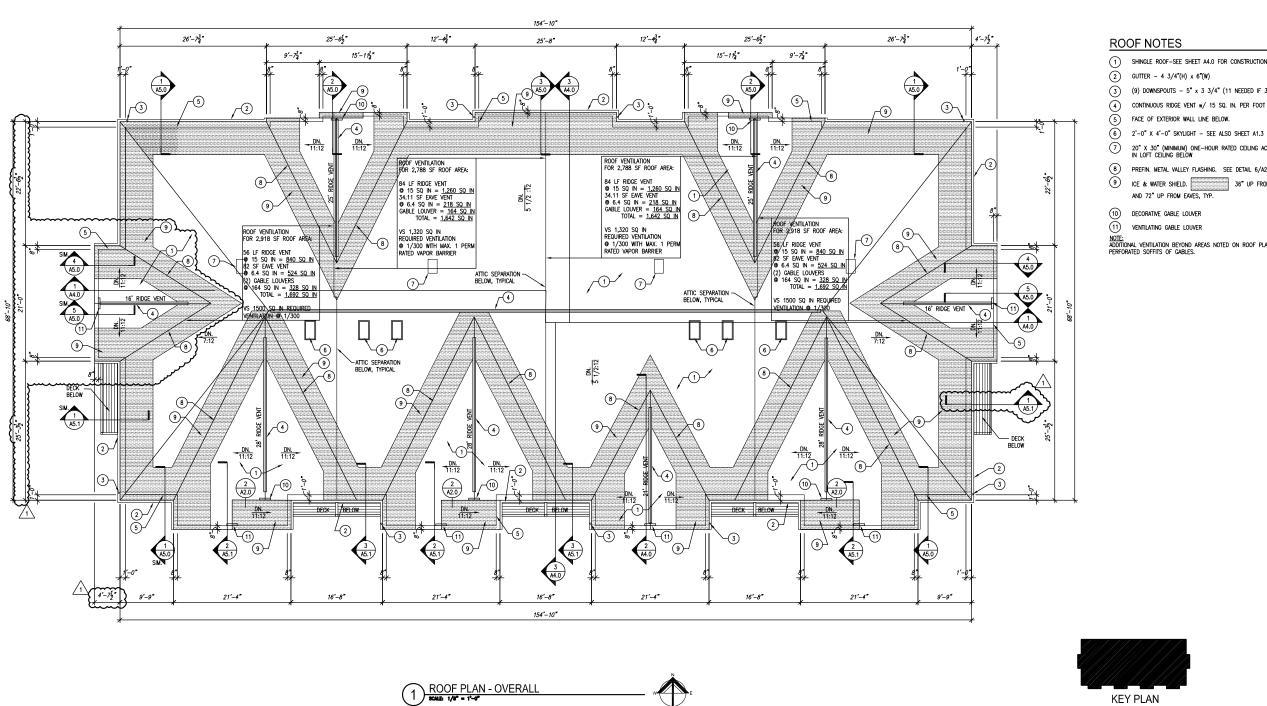SHINGLE ROOF-SEE SHEET A4.0 FOR CONSTRUCTION TYPE.

GUTTER - 4 3/4"(H) x 6"(W)

(9) DOWNSPOUTS - 5" x 3 3/4" (11 NEEDED IF 3" X 4" USED)

CONTINUOUS RIDGE VENT  $\mathbf{w}/$  15 Sq. in. Per foot ventilation

FACE OF EXTERIOR WALL LINE BELOW.

20" X 30" (MINIMUM) ONE-HOUR RATED CEILING ACCESS PANEL IN LOFT CEILING BELOW

PREFIN. METAL VALLEY FLASHING. SEE DETAIL 6/A2.0.

9 ICE & WATER SHIELD. 36" UP FROM VALLEYS AND 72" UP FROM EAVES, TYP.

10 DECORATIVE GABLE LOUVER

(11) VENTILATING GABLE LOUVER

 $\frac{\text{NOTE:}}{\text{ADDITIONAL}}$  ventilation beyond areas noted on roof plan provided by perforated soffits of gables.

**PRELIMINARY** 

NOT FOR CONSTRUCTION QUORUM ARCHITECTS, INC.

BUILDING 5 COLONIAL WOODS 16 UNIT APARTMENT BUILDING

S 27th St & V Oak Creek, 1

Revisions: ADDENDUM #1 03/07/2025

Sheet Name: ROOF PLAN AND ROOF DETAILS

02/07/2025 Drawn By: CLR/CGH Project No.: 20116.01.02

Sheet No.

A2.0



WALL SHEATHING

VINYL SIDING -

VINYL FLASHING -

TRIM BOARD -

SIDE WALL FLASHING DETAIL

SOME 1 1/2" = 1"-0"

SHINGLES

15# FELT -


ICE & WATER

ROOF SHEATHING

ROOF TRUSSES/ FRAMING -

ICE & WATER SHIELD METAL FLASHING (STEP SHINGLES)

PLUMBING VENT - STAINLESS STEEL CLAMPING RING - ROOF SHEATHING - TOP CHORD OF WOOD TRUSSES

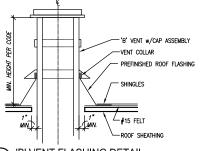


HOOK EDGE WITH -∟MIN. 26 GA. GALV. - ICE & WATER SHIELD


METAL VALLEY FLASHING DETAIL

SOME 1 1/2" = 1"-0"

(4) 'B' VENT FLASHING DETAIL



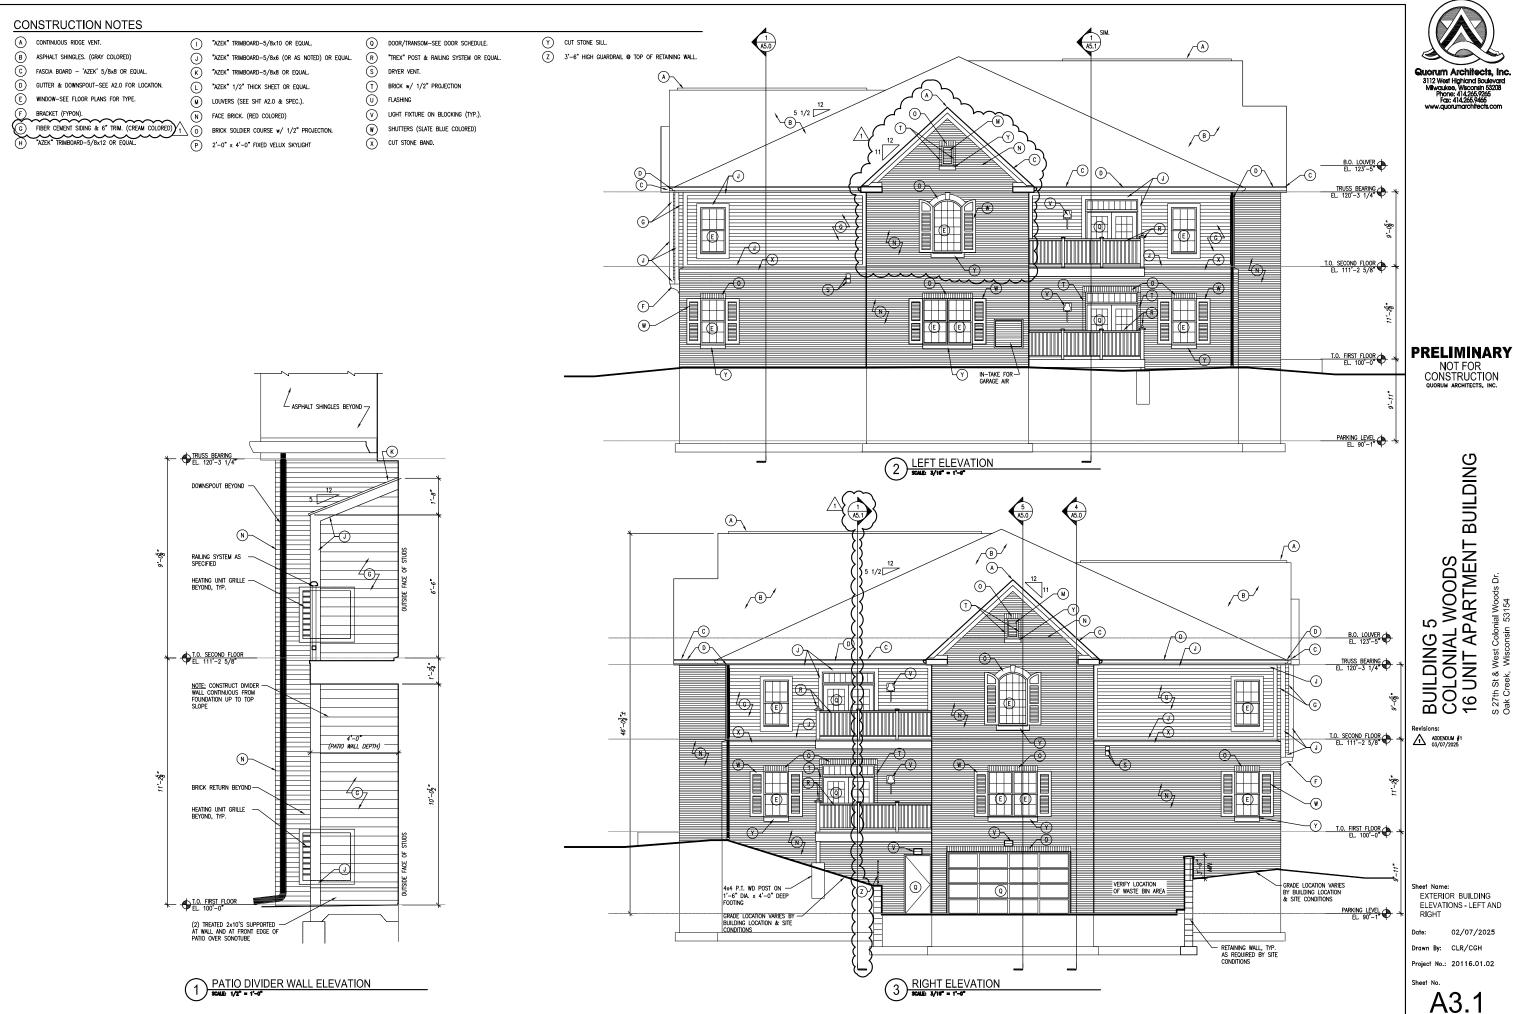

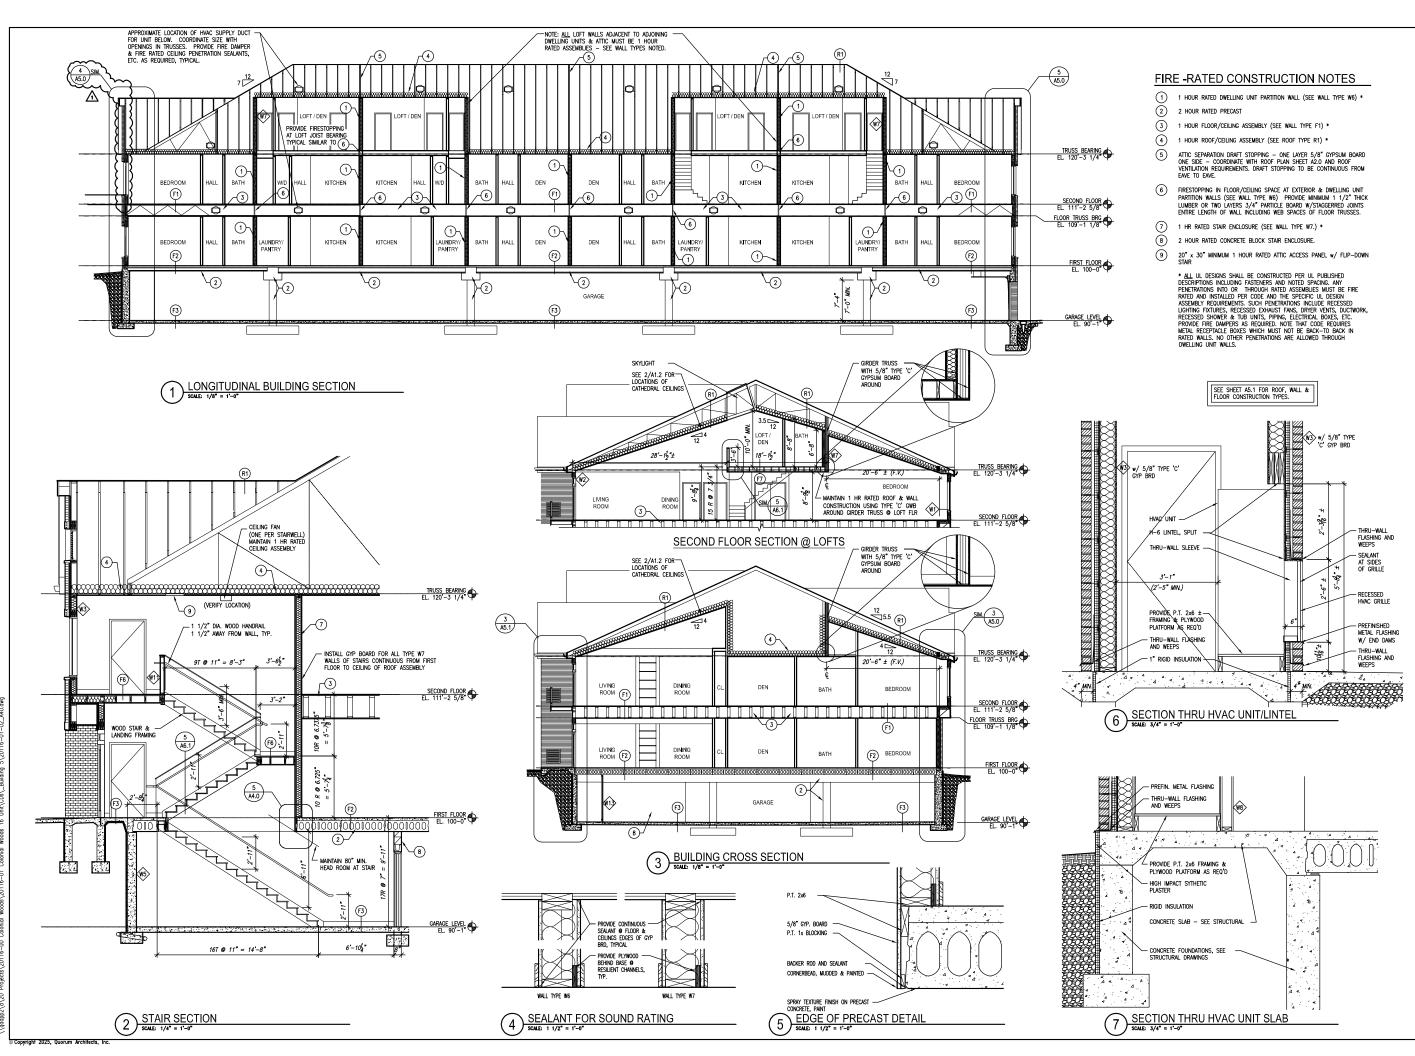



# PRELIMINARY

NOT FOR CONSTRUCTION QUORUM ARCHITECTS, INC.

# BUILDING 5 COLONIAL WOODS 16 UNIT APARTMENT BUILDING S 27th St & West Colonial Woods Dr. Oak Creek, Wisconsin 53154

Revisions:

ADDENDUM #1
03/07/2025

Sheet Name: BUILDING SECTIONS

> e: 02/07/2025 wn By: CLR/CGH

Project No.: 20116.01.02 Sheet No.

A4.0



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CONSTRUCTION

QUORUM ARCHITECTS, INC.

BUILDING 5
COLONIAL WOODS
16 UNIT APARTMENT BUILDING
S 27th St & West Colonial Woods Dr.
Oak Creek, Wisconsin 53154

Revisions:

heet Name: WALL SECTIONS

 Date:
 02/07/2025


 Drawn By:
 CLR/CGH

 Project No.:
 20116.01.02

heet No.

A5.0

Feb 11, 2025 - 9:3am Q:\20 Projects\20116-00 Colonial Woods\20116-01 Colonial Woods 16 Unit\CDs\\_Building 5\20116-

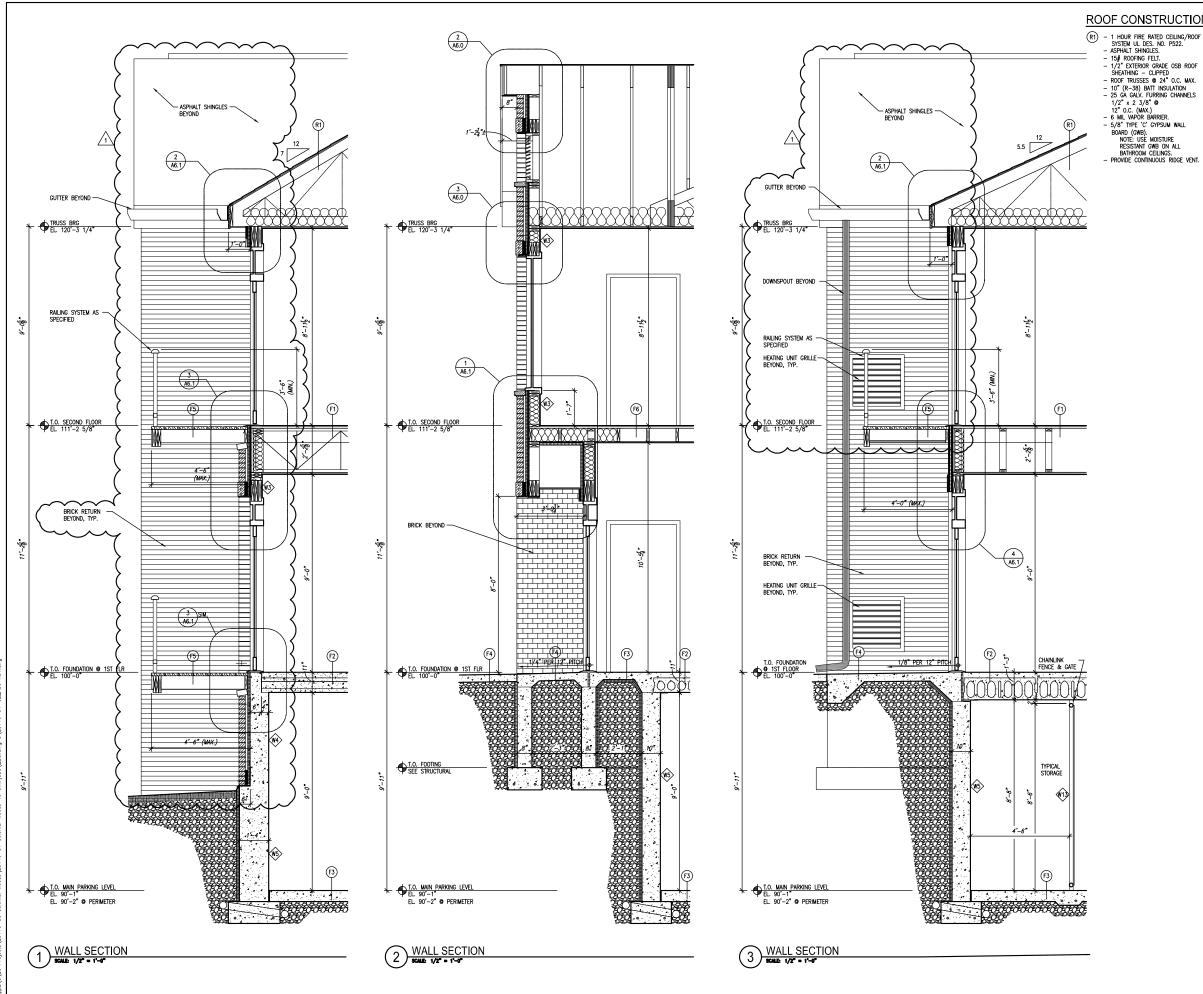

### ROOF CONSTRUCTION **EXTERIOR WALL TYPES**

- 1 HOUR FIRE RATED CEILING/ROOF SYSTEM UL DES. NO. P522.

- W1> RATED WALL ASSEMBLY PER U.L. DESIGN NO. U356
   FIBER CEMENT SIDING WITH FLAME SPREAD VALUE OF 2
- FIGER CEMENT SIGNING MITH FLOWE SPROAD VALUE OF 20 OR LESS.

   "TYPEK" BUILDING PAPER.

   1 1/2" CONTINUOUS RIGID INSULATION (R-7.5 MIN.)

   1/2" EXTERIOR STRUCTURAL STEDI-R BOARD SHEATHING
- (R=1.5) 2x6 WOOD STUDS @ 16" O.C. (MAX.)
- 25 1/2" (R-19) FIBERGLASS INSULATION, W/ U.L. CLASSIFICATION

  4 MIL. VAPOR BARRIER.

- 4 mil. Vye'o'n wall board (gwb), type 'c' or 'x'
  NOTE: USE MOISTURE RESISTANT GWB ON ALL
  BATHROOM WALLS.
   WALL THICKNESS= 9" NOMINAL.
- | ARTEN WALL ASSMBLY PER U.L. DESIGN NO. U356
  | 1/2" THICK "AZEK" SHEET (SEE SPEC.) w/ U.L. CLASSIFICATION.
  | "TVYEK" BUILDING PAPER.
  | 1/2" EXTERIOR STRUCTURAL STEDI-R BOARD SHEATHING

- 4 mil. VAPOR BARKIER.

   5/8" GYPSUM WALL BOARD (GWB), TYPE 'C' OR 'X'
  NOTE: USE MOISTURE RESISTANT GWB ON ALL
  BATHROOM WALLS.

   WALL THICKNESS= 7 1/2" NOMINAL
- FACE BRICK PER SPECIFICATION.

  GALV. BRICK TIES ® 16" HORIZONTALLY AND 16" VERTICALLY.

  1" All SPACE MIN.

  "TYPEK" BUILDING PAPER

  """ COMMINIOUS RIGHT INSULATION (R-7.5 MI

- TYVEX" BUILDING PAPER

  1 1/2" CONTINUOUS RIGID INSULATION (R-7.5 MIN.)

  1 1/2" CONTINUOUS RIGID INSULATION (R-7.5 MIN.)

  1/2" EXTERIOR STRUCTURAL STEDI-R BOARD SHEATHING (R=1.5)

  2.56 WOOD STUDS 16" O.C. (MAX.)

  5 1/2" (R-19) FIBERGLASS INSULATION, W/ U.L. CLASSIFICATION.

  4 MIL VAPOR BARRER.

  5/8" GYPSUM WALL BOARD (GWB), TYPE 'C' OR 'X'

  PROVIDE THRU-WALL FLASHING & WEEP HOLES 24" O.C. NOTE: USE MOSTUME RESISTANT GWB ON ALL BATHROOM WALLS.

  WALL THICKNESS= 13" NOM., 12 3/4" ACT.
- W4> FACE BRICK PER SPECIFICATION. - GALV. BRICK TIES @ 16" HORIZONTALLY AND 16"
  VERTICALLY.
  - 1" AIR SPACE MIN.

- 1" AIR SPACE MIN.
  "TYPEK" BULUDING PAPER
   1 1/2" CONTINUOUS RIGID INSULATION (R-7.5 MIN.)
   10" REINFORCED CONCRETE WALL (SEE STRUCT. DWGS.)
   PROVIDE THRU-WALL FLASHING & WEEP HOLES @ 24" O.C.
   WALL THICKNESS= 16"
- REINFORCED CONCRETE FOUNDATION WALL (SEE STRUCT. REINFORCE COMPRETE FOUNDATION WALL (SEE SINGLE).

  DWGS FOR EXACT SIZE AND LOCATIONS,

  WAITERPROOF ENTIRE FOUNDATION WALL

  ALTERNATE NO. 1: WAITCHOOG BY TREMOO "+ ENERGY"

  1 1/2" MIN. RIGID INSUL. FULL WALL HEIGHT THROUGHOUT
- (MIN. R=7.5) 2'-0" MIN. GRANULAR FILL OVER 4" DIA. DRAIN TILE. - 2 - 0 min. Grandlar fill over 4 dia. Drain file. (Backfill only after first floor plank has been set.) - Wall Thickness= 10" TO 16"
- √15 2 x 6 WOOD STUDS @ 24" O.C. MAX. - 1/2" EXTERIOR STEDI-R BOARD SHEATHING BOTH SIDES
  TRIM BOARDS AT FRONT, SIDES, & TOP
  - NOMINAL WALL THICKNESS= 7"

NOTE: SEE SHEET A1.3 FOR INTERIOR WALL TYPES

### FLOOR CONSTRUCTION

- F1) 1 HOUR FIRE RATED FLOOR UL DES. NO. L528 SYSTEM NO. 4

- SYSTEM NO. 4

   3/4" (VP-CRETE TOPPING.

   3/4" (GRADE 'C-D' PL'WOOD N/ EXT. GLUE SUBFLOORING.
  (GLUED AND NALED TO TRUSSES).

   24" DEEP PREFAB. TRUSSES © 24" O.C. MAX. SEE
  STRUCTURAL.
  NOTE: PROVIDE BRIDGING PER TRUSS MANUFACTURER

   NO. 26 MSG GALV. 1/2" RESULENT CHANNELS © 16" O.C.

   5/8" TPP C' GYPSJUM WALLBOARD (KWB).
- 5/8" TYPE 'C' GYPSUM WALLBOARD (GWB). NOTE: USE MOISTURE RESISTANT DRYWALL ON ALL CELLINGS ABOVE TUBS AND SHOWERS. MINIMUM STC OF 50.
- F2 2 HOUR FIRE-RATED FLOOR SYSTEM: - 3" (MIN.) CONCRETE TOPPING. - 12" (OR 8") THICK PRECAST CONCRETE PLANK. (SEE
- (F3) 6" POURED CONC. FLOOR w/ 6x6 #6/#6 W.W.M. 6 MIL POLY VAPOR BARRIER. 6" (MIN.) COMPACTED GRANULAR FILL.
- F4 4" MIN. POURED CONC. SLAB w/ 6x6 10/10 W.W.M 6" (MIN.) COMPACTED GRANULAR FILL.
- (F5) 2x8 P. T. WOOD BOARD WITH 1/2" SPACING BETWEEN 2x8 (OR 2x10) P. T. WOOD JOISTS @ 16" O.C. (SEE STRUCT. DWGŚ.)
- (F6) 3/4" GYP-CRETE TOPPING.
   3/4" GRADE "C-D" PLYWOOD w/ EXT. GLUE SUBFLOORING.
  (GLUED AND NAILED TO JOISTS).
   2x8 WOOD JOIST 9 16" O.C. (SEE STRUCT.)
   5/8" TYPE "C" GYPSUM WALLBOARD (GWB).
- F7 FLOOR/CEILING
- FLOOR/CEILING

  3/4" GRADE 'C-D' PLYWOOD w/ EXT. GLUE SUBFLOORING.
  (GLUED AND NALED TO JOISTS).

  2x10 & LVL FRAMING SEE STRUCTURAL

  NO. 26 NSC GALV. 1/2" RESULENT CHANNELS @ 16" O.C.

  5/8" GYPSUM WALLBOARD (GWB).
- FB 3/4" GYP-CRETE TOPPING. - 3/4 "RADE C"-D" PLYWOOD W/ EXT. GLUE SUBFLOORING.
  (GLUED AND NAILED TO JOSTS).
  - 2x10 WOOD JOIST © 16" O.C. (SEE STRUCT.)
  - 5/8" TYPE 'C' GYPSUM WALLBOARD (CWB).

PRELIMINARY NOT FOR CONSTRUCTION QUORUM ARCHITECTS, INC.

Quorum Architects, Inc. 3112 West Highland Boulevard Milwaukee, Wisconsin 53208

BUILDING **ARTMENT** , 5 , WOOD! , WOOD! AP) BUILDING ( COLONIAL 16 UNIT AP

Revisions: ADDENDUM #1 03/07/2025 St & \ reek,

Sheet Name:

WALL SECTIONS AND CONSTRUCTION TYPES

02/07/2025 Date: Drawn By: CLR/CGH

Sheet No.

Project No.: 20116.01.02

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BUILDING 5 COLONIAL WOODS 16 UNIT APARTMENT BUILDING

S 27th St & West Colonial Woods Dr. Oak Creek, Wisconsin 53154

1 FRONT ELEVATION
SCALE: 3/10" = 1'-0"



Revisions:

Sheef Name: EXTERIOR BUILDING ELEVATIONS - FRONT AND BACK

02/07/2025

Drawn By: CLR/CGH Project No.: 20116.01.02

Sheet No.

A3.0

REAR ELEVATION
SCALE: 3/16" = 1'-0"







RIGHT ELEVATION
SOME: 3/16" = 1'-9"



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QUORUM ARCHITECTS, INC.

# BUILDING 5 COLONIAL WOODS 16 UNIT APARTMENT BUILDING S 27th St & West Colonial Woods Dr. Oak Creek, Wisconsin 53154


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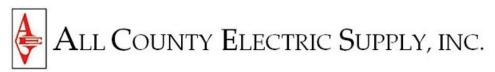
Sheet Name: EXTERIOR BUILDING ELEVATIONS - LEFT AND RIGHT

Date: 02/07/2025

Drawn By: CLR/CGH Project No.: 20116.01.02

A3.1



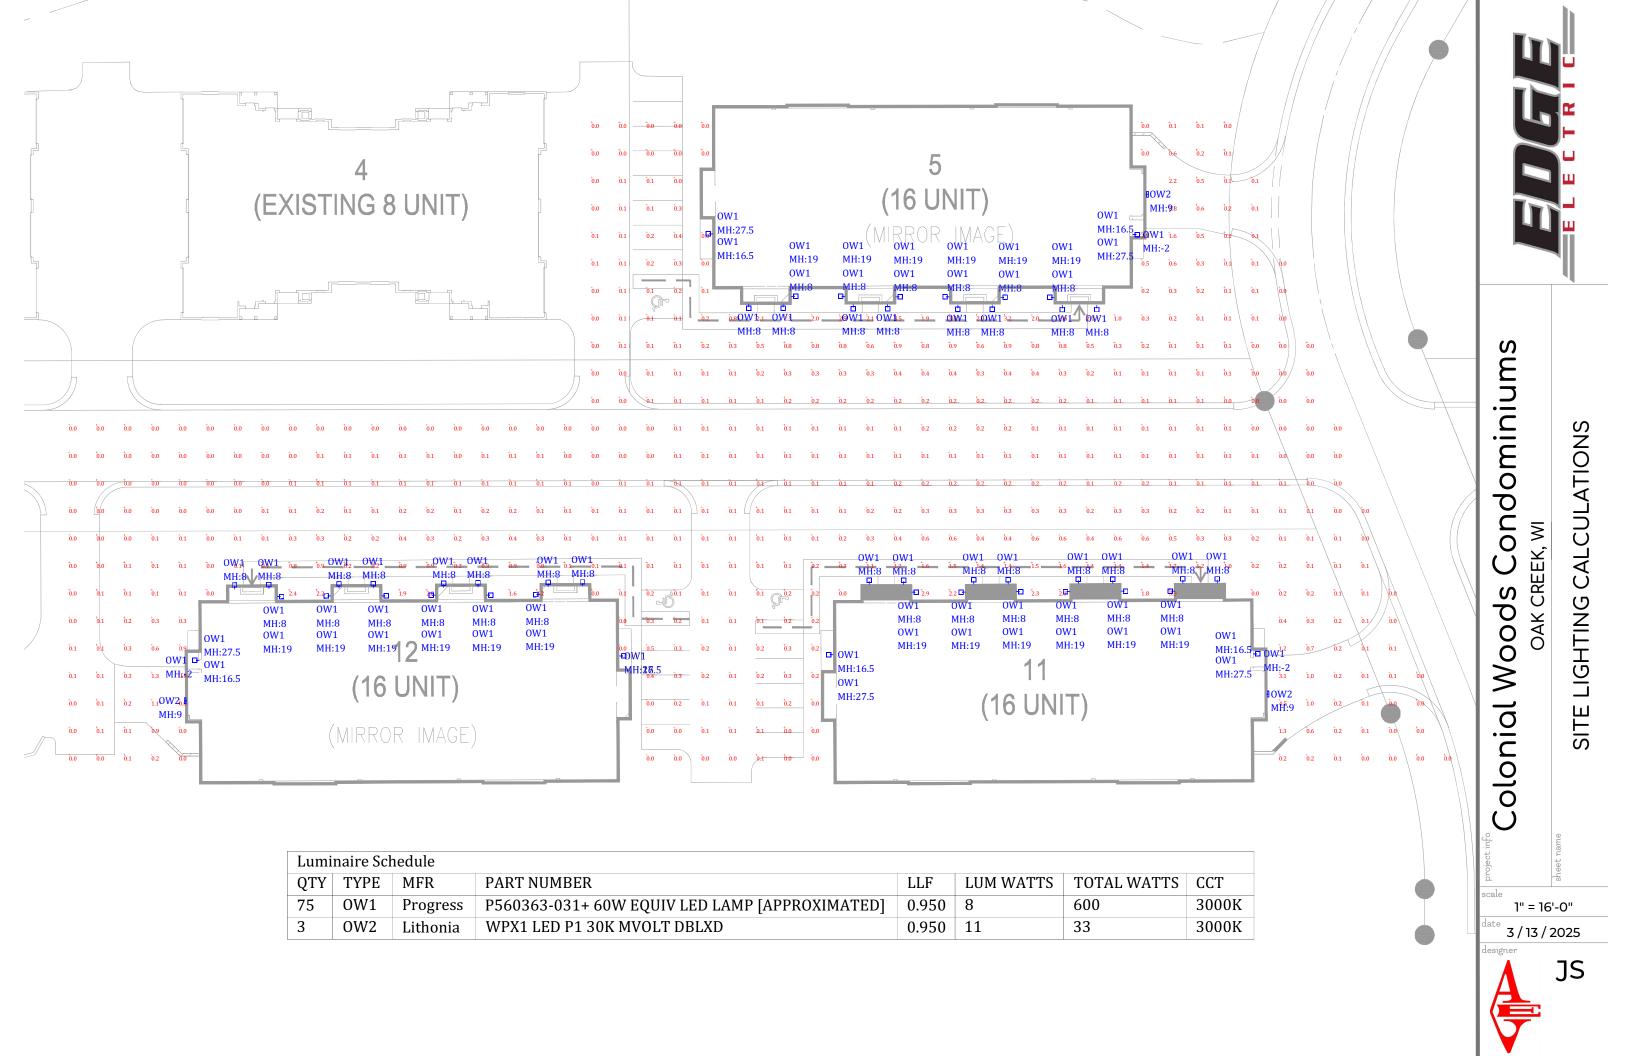

2755 S 163rd St New Berlin, WI 53151 Contact: Joshua Canham

# **COLONIAL WOODS CONDOMINIUMS**

SITE
Submittal Date
3.13.25

Туре	Mfg	Catalog Number/Description
OW1	PROGRESS	P560363-031
OW2	LITHONIA	WPX1 LED P1 30K MVOLT DBLXD



P560363-031 COLONIAL WOODS CONDOMINIUMS TYPE OW1

# P560363-031 Bayside Non-Metallic

Bayside Collection One-Light Non-Metallic Black Outdoor Wall Lantern

Category: Outdoor Finish: Black (No Finish)

Construction: Polycarbonate Housing



Width: 8 in Extends: 9-3/8 in Height: 10 in H/CTR: 5-1/2 in

		, , ,	
MOUNTING	ELECTRICAL	LAMPING	ADDITIONAL INFORMATION
Wall mounted	6 inches of wire supplied	(1) Medium Base (E26) Socket	cULus Wet Location Listed
Swivel mounting strap for outlet box included	120 VAC	Lamp Type Incandescent: 40-watt MAX per socket LED: 10-watt MAX per socket	1-year Limited Warranty  Dark Sky compliant
Canopy covers a standard 4" recessed outlet box: 5" W., 1.25" ht., 5" depth		Dimmable to 10% brightness (See Dimming Notes)	
			Mad in USA
















### **Specifications**

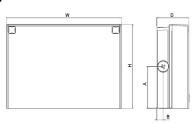

### Front View

Side View

Luminaire	Height (H)	Width (W)	Depth (D)	Side Condu	it Location	Weight
Luillillaire	neight (n)	witti (w)	νεμιι (ν)	A	В	Weight
WPX1	8.1" (20.6 cm)	11.1" (28.3 cm)	3.2" (8.1 cm)	4.0" (10.3 cm)	0.6" (1.6 cm)	6.1 lbs (2.8kg)
WPX2	9.1" (23.1 cm)	12.3" (31.1 cm)	4.1" (10.5 cm)	4.5" (11.5 cm)	0.7" (1.7 cm)	8.2 lbs (3.7kg)
WPX3	9.5" (24.1 cm)	13.0" (33.0 cm)	5.5" (13.7 cm)	4.7" (12.0 cm)	0.7" (1.7 cm)	11.0 lbs (5.0kg)

### WPX1 LED P1 30K MVOLT DBLXD COLONIAL WOODS CONDOMINIUMS TYPE OW2

### Introduction

The WPX LED wall packs are energy-efficient, costeffective, and aesthetically appealing solutions for both HID wall pack replacement and new construction opportunities. Available in three sizes, the WPX family delivers 1,550 to 9,200 lumens with a wide, uniform distribution.

The WPX full cut-off solutions fully cover the footprint of the HID glass wall packs that they replace, providing a neat installation and an upgraded appearance. Reliable IP66 construction and excellent LED lumen maintenance ensure a long service life. Photocell and emergency egress battery options make WPX ideal for every wall mounted lighting application.

**EXAMPLE: WPX2 LED 40K MVOLT DDBXD** 

### **Ordering Information**

### 30K WPX1 LED P1 **MVOLT DBLXD Color Temperature** Voltage **Options** Finish Series WPX1 LED P1 1,550 Lumens, 11W1 3000K MVOLT 120V - 277V (blank) DDBXD Dark bronze 30K 2,900 Lumens, 24W WPX1 LED P2 347V E4WH Emergency battery backup, CEC compliant **DWHXD** White 4000K (4W, 0°C min) 2 WPX2 LFD 6,000 Lumens, 47W DRI XD Black 50K 5000K E14WC Emergency battery backup, CEC compliant WPX3 LED 9,200 Lumens, 69W Note: For other options, consult factory. (14W, -20°C min) Photocell<sup>3</sup> PE

Note: The lumen output and input power shown in the ordering tree are average representations of all configuration options. Specific values are available on request.

- All WPX wall packs come with 6kV surge protection standard, except WPX1 LED P1 package which comes with 2.5kV surge protection standard. Add SPD6KV option to get WPX1 LED P1 with 6kV surge protection.
  Sample nomenclature: WPX1 LED P1 40K MVOLT SPD6KV DDBXD
- 2. Battery pack options only available on WPX1 and WPX2.
- 3. Battery pack options not available with 347V or PE options.

### **FEATURES & SPECIFICATIONS**

### INTENDED LISE

The WPX LED wall packs are designed to provide a cost-effective, energy-efficient solution for the one-for-one replacement of existing HID wall packs. The WPX1, WPX2 and WPX3 are ideal for replacing up to 150W, 250W, and 400W HID luminaires respectively. WPX luminaires deliver a uniform, wide distribution. WPX is rated for -40°C to 40°C.

WPX feature a die-cast aluminum main body with optimal thermal management that both enhances LED efficacy and extends component life. The luminaires are IP66 rated, and sealed against moisture or environmental contaminants.

Light engine(s) configurations consist of high-efficacy LEDs and LED lumen maintenance of L90/100,000 hours. Color temperature (CCT) options of 3000K, 4000K and 5000K with minimum CRI of 70. Electronic drivers ensure system power factor >90% and THD <20%. All luminaires have 6kV surge protection (Note: WPX1 LED P1 package comes with a standard surge protection rating of 2.5kV. It can be ordered with an optional 6kV surge protection). All photocell (PE) operate on MVOLT (120V - 277V) input.

Note: The standard WPX LED wall pack luminaires come with field-adjustable drive current feature. This feature allows tuning the output current of the LED drivers to adjust the lumen output (to dim the luminaire).

### INSTALLATION

WPX can be mounted directly over a standard electrical junction box. Three 1/2 inch conduit ports on three sides allow for surface conduit wiring. A port on the back surface allows poke-through conduit wiring on surfaces that don't have an electrical junction box. Wiring can be made in the integral wiring compartment in all cases. WPX is only recommended for installations with LEDs facing downwards.

### LISTINGS

CSA Certified to meet U.S. and Canadian standards. Suitable for wet locations. IP66 Rated. DesignLights Consortium® (DLC) qualified product. Not all versions of this product may be DLC qualified. Please check the DLC Qualified Products List at www which versions are qualified. International Dark Sky Association (IDA) Fixture Seal of Approval (FSA) is available for all products on this page utilizing 3000K color temperature only.

5-year limited warranty. This is the only warranty provided and no other statements in this specification sheet create any warranty of any kind. All other express and implied warranties are disclaimed. Complete warranty terms located at:

Note: Actual performance may differ as a result of end-user environment and application. All values are design or typical values, measured under laboratory conditions at 25°C. Specifications subject to change without notice.



### **Performance Data**

### **Electrical Load**

Luminaire	Input Power (W)	120V	208V	240V	277V	347V
WPX1 LED P1	11W	0.09	0.05	0.05	0.04	0.03
WPX1 LED P2	24W	0.20	0.12	0.10	0.09	0.07
WPX2	47W	0.39	0.23	0.20	0.17	0.14
WPX3	69W	0.58	0.33	0.29	0.25	0.20

### **Projected LED Lumen Maintenance**

Data references the extrapolated performance projections in a  $25^{\circ}$ C ambient, based on 6,000 hours of LED testing (tested per IESNA LM-80-08 and projected per IESNA TM-21-11).

To calculate LLF, use the lumen maintenance factor that corresponds to the desired number of operating hours below. For other lumen maintenance values, contact factory.

Operating Hours	50,000	75,000	100,000
Lumen Maintenance Factor	>0.94	>0.92	>0.90

### **HID Replacement Guide**

Luminaire	Equivalent HID Lamp	WPX Input Power
WPX1 LED P1	100W	11W
WPX1 LED P2	150W	24W
WPX2	250W	47W
WPX3	400W	69W

### **Lumen Output**

Luminaire	Color Temperature	Lumen Output
	3000K	1,537
WPX1 LED P1	4000K	1,568
	5000K	1,602
	3000K	2,748
WPX1 LED P2	4000K	2,912
	5000K	2,954
	3000K	5,719
WPX2	4000K	5,896
	5000K	6,201
	3000K	8,984
WPX3	4000K	9,269
	5000K	9,393

# Lumen Ambient Temperature (LAT) Multipliers

Use these factors to determine relative lumen output for average ambient temperatures from 0-40°C (32-104°F).

Ambient	Ambient	Lumen Multiplier	
0°C	32°F	1.05	
5℃	41°F	1.04	
10°C	50°F	1.03	
15℃	59°F	1.02	
20°C	68°F	1.01	
25°C	77°F	1.00	
30°C	86°F	0.99	
35℃	95°F	0.98	
40°C 104°F		0.97	

### **Emergency Egress Battery Packs**

The emergency battery backup is integral to the luminaire — no external housing or back box is required. The emergency battery will power the luminaire for a minimum duration of 90 minutes and deliver minimum initial output of 550 lumens. Both battery pack options are CEC compliant.


Battery Type	Minimum Temperature Rating	Power (Watts)	Controls Option	Ordering Example
Standard	0°C	4W	E4WH	WPX2 LED 40K MVOLT <b>E4WH</b> DDBXD
Cold Weather	-20°C	14W	E14WC	WPX2 LED 40K MVOLT <b>E14WC</b> DDBXD


## **Photometric Diagrams**


To see complete photometric reports or download .ies files for this product, visit the Lithonia Lighting WPX LED homepage. Tested in accordance with IESNA LM-79 and LM-80 standards





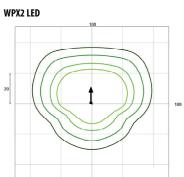

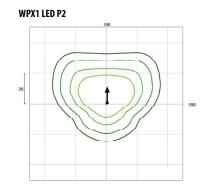

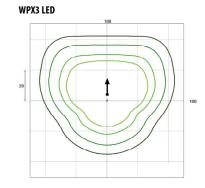

Mounting Height = 12 Feet.

