


RACINE UNIFIED SCHOOL DISTRICT

GIFFORD SCHOOL ADDITION AND RENOVATION

8332 Northwestern Ave, Racine, Wisconsin

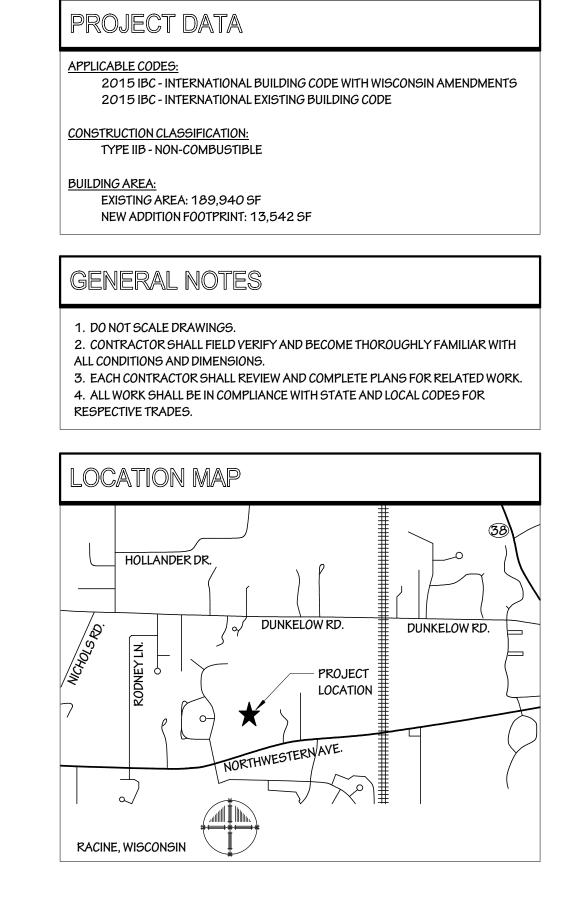

ALTERNATES
ALTERNATE BID NO. A1 - LOCKER ROOM RENOVATION PROVIDE A LUMP SUM VALUE TO BE ADDED TO THE BASE BID FOR ALL THE MATERIAL, LABOR, AND EQUIPMENT REQUIRED TO COMPLETE THE WORK ASSOICATED WITH RENOVATING THE EXISTING LOCKER ROOMS AND CREATING A FITNESS CENTER. SEE SHEETS A2.6, A3.6, A7.10, A7.11, M2.5, M3.6, P1.5, P2.6, P3.5, P4.6, E2.5, E3.5, E4.6, E5.6, AND E6.6.
ALTERNATE BID NO. A2 - REMOVE COMMON AREAS PAINTING SCOPE PROVIDE A LUMP SUM VALUE TO BE DEDUCTED FROM THE BASE BID FOR MATERIAL, LABOR, AND EQUIPMENT REQUIRED TO PAINT THE EXISTING GYPSUM BOARD WALLS IN THE CORRIDORS LOCATED IN AREA A, B, C, AND D. INCLUDING THE CAFETERIA IN AREA C.
ALTERNATE BID NO. R1 - ROOF REPLACEMENT PROVIDE A LUMP SUM VALUE TO BE ADDED TO THE BASE BID FOR THE MATERIAL, LABOR, AND EQUIPMENT REQUIRED TO REMOVE AND REPLACE THE ROOFING IN AREAS 5, 6, 11, AND 12.
ALTERNATE BID NO. R2 - ROOF REPLACEMENT PROVIDE A LUMP SUM VALUE TO BE ADDED TO THE BASE BID FOR THE MATERIAL, LABOR, AND EQUIPMENT REQUIRED TO REMOVE AND REPLACE THE ROOFING IN AREAS 13, 15, AND 16.
ALTERNATE BID NO. R3 - ROOF REPLACEMENT PROVIDE A LUMP SUM VALUE TO BE ADDED TO THE BASE BID FOR THE MATERIAL, LABOR, AND EQUIPMENT REQUIRED TO REMOVE AND REPLACE THE ROOFING IN AREAS 17, 18, 19 AND 27.
IMPORTANT DATES
01/10/2025 - 0UT TO BID 01/20/2025 - 10:00 AM - PRE BID WALK-THRU FOR BIDDERS 01/31/2025 - BIDS DUE 02/10/2025 - SCOPING REVIEW COMPLETE 04/21/2025 - PROJECT COMMENCEMENT

ALT	ALTERNATE	НМ	HOLLOW METAL	
A/E	ARCHITECT/ENGINEER	HT	HEIGHT	
AFF	ABOVE FINISH FLOOR	HW	HOTWATER	
ALUM	ALUMINUM	INT	INTERIOR	
BD	BOARD	INSUL	INSULATION	
B/0	BOTTOM OF	JT	JOINT	
CPT	CARPET	LAV	LAVATORY	
01 1	CENTER LINE	MFR	MANUFACTURER	
CLG	CEILING	MIN	MINIMUM	
C.J	CONTROL JOINT	MO	MASONRY OPENING	
CMU	CONCRETE MASONRY UNIT	MTL	METAL	
CONC	CONCRETE	NIC	NOT IN CONTRACT	
CONT	CONTINUOUS	NTS	NOT TO SCALE	
CO	CLEAN OUT	OC	ON CENTER	
CW	COLD WATER	0FCI	OWNER FURNISHED,	
CT	CERAMIC TILE	OI CI	CONTRACTOR TO INSTALL	
DBL	DOUBLE	OPP	OPPOSITE	
DF	DRINKING FOUNTAIN	PLYWD	PLYW00D	
DIA	DIAMETER	PL	PLASTIC LAMINATE	
DIM	DIMENSION	f	PLATE	
DIM DN	DOWN	J PT	PORCELAIN TILE	
DR DR	DOOR	QT	QUARRY TILE	
DS	DOWNSPOUT	REQ'D	REQUIRED	
DTL	DETAIL	RO		
DWG	DRAWING	SHT	ROUGH OPENING SHEET	
EA	EACH	SV	SHEETVINYL	
EIFS	EXTERIOR INSULATION AND	SIM	•	
EIFO	FINISH SYSTEM	51W 55	SIMILAR SOLID SURFACE	
EL	ELEVATION	SST	STAINLESS STEEL	
EJ	EXPANSION JOINT	STD	STANDARD	
EQ	EQUAL	SAT	SUSPENDED ACOUSTIC	
EQUIP	EQUIPMENT	3A1	TILE CEILING	
EXIST	EXISTING	TBD	TO BE DETERMINED	
EXT	EXTERIOR	TEMP	TEMPORARY	
EWC	ELECTRIC WATER COOLER			
	FIRE EXTINGUISHER	T/0	TOP OF	
FEC		T&G	TONGUE AND GROOVE	
EIN	CABINET FINISH	TYP	TYPICAL	
FIN		UNO	UNLESS NOTED OTHERWISE	
FD	FLOOR DRAIN	VCT	•	
FLR	FLOOR	VCT	VINYL COMPOSITION TILE	
FRP	FIBERGLASS REINFORCED	VB	VINYL BASE	
C.4	PLASTIC	VIF	VERIFY IN FIELD	
GA	GAUGE	WD	WOOD	
GALV GYP BD	GALVANIZED	WWF	WELDED WIRE FABRIC	



SHEET INDEX_CD

TITLE SHEET

EXISTING CONDITIONS

DIMENSIONED SITE PLAN

SITE GRADING & EROSION CONTROL PLAN

PAVEMENT GRADING, MARKING & SIGNAGE PLAN

TYPICAL SECTIONS & CONSTRUCTION DETAILS

TYPICAL SECTIONS & CONSTRUCTION DETAILS

TYPICAL SECTIONS & CONSTRUCTION DETAILS

ARCHITECTURAL SITE DEMOLITION PLAN

ENLARGED DEMOLITION FLOOR PLAN AREA B

OVERALL DEMOLITION FLOOR PLAN

ARCHITECTURAL SITE PLAN W/FUTURE SOLAR PANELS


ARCHITECTURAL SITE PLAN

SITE DEMOLITION PLAN

SITE UTILITY PLAN

TITLE SHEET

ARCHITECTURAL

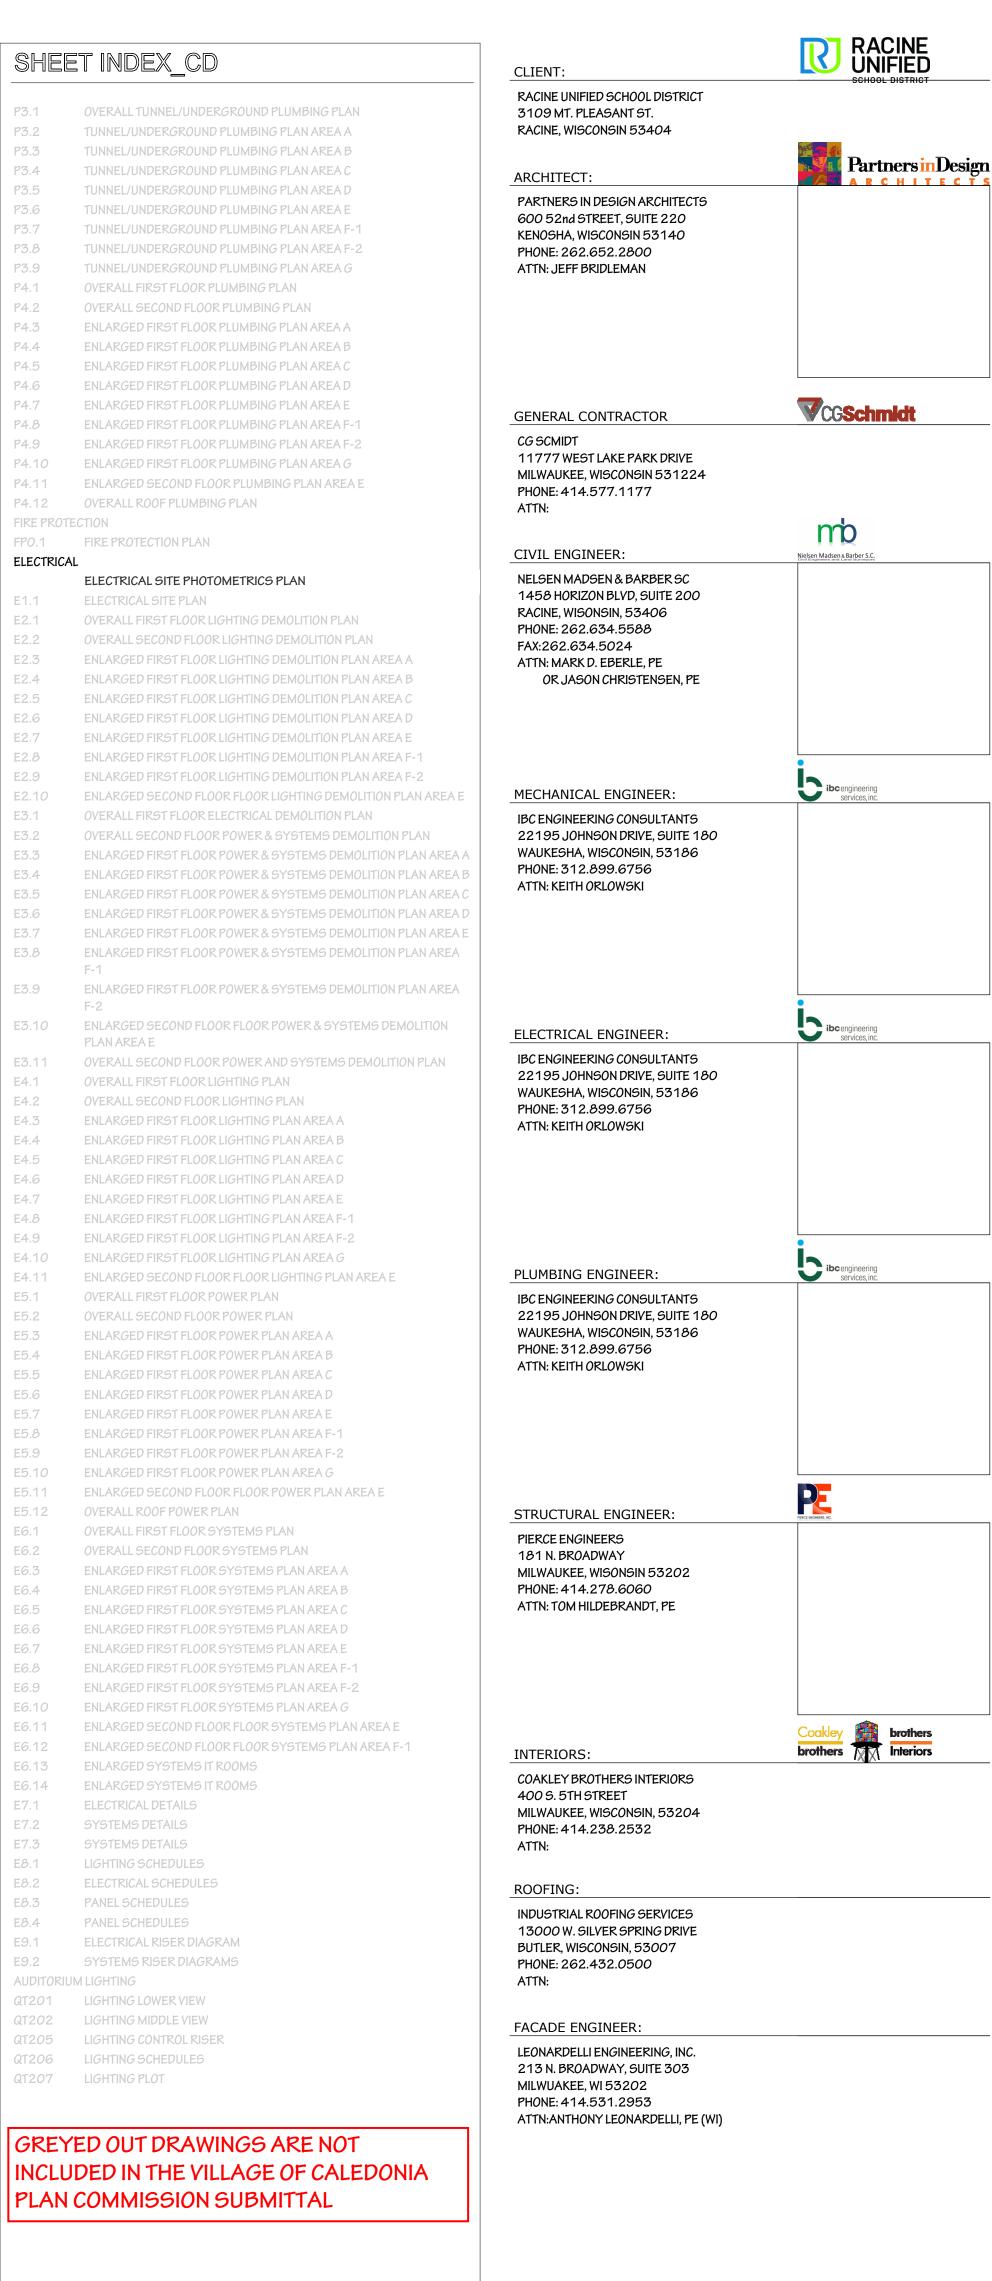




RACINE UNIFIED SCHOOL DISTRICT

GIFFORD SCHOOL ADDITION AND RENOVATION

PROJECT NUMBER: 723.24.035

BID SET ISSUE DATE: 01.09.2025

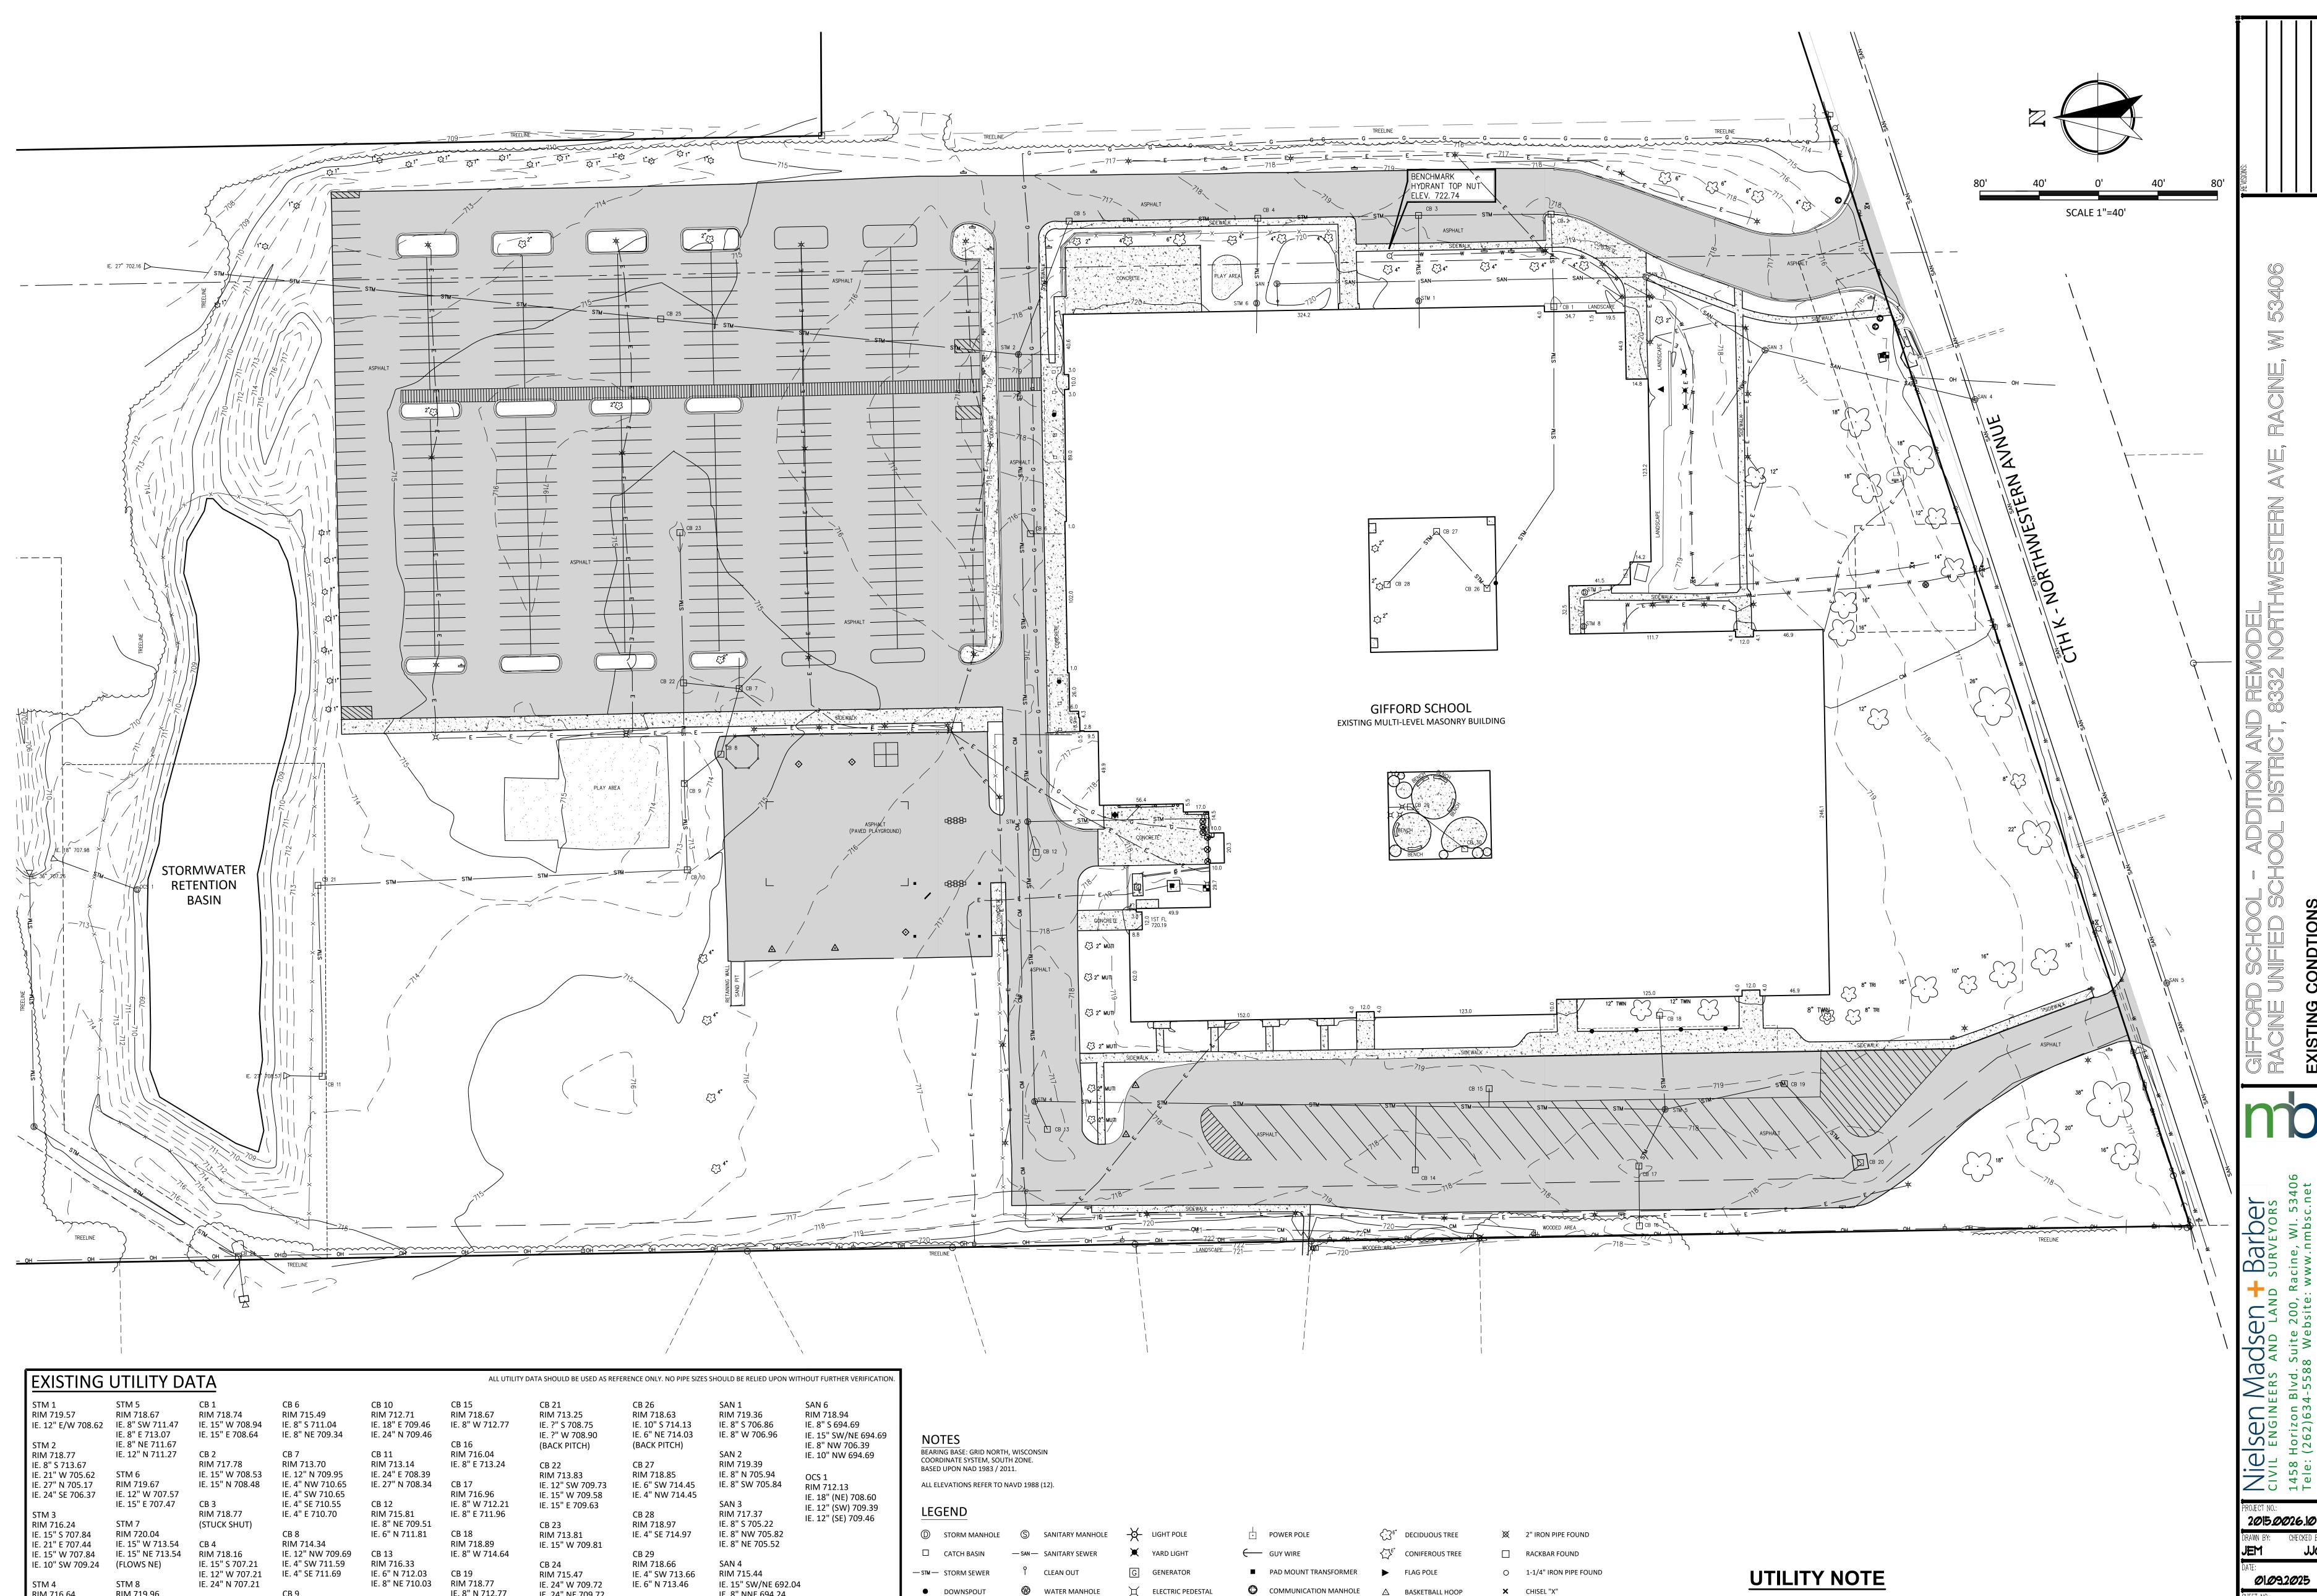

WATER MANHOLE

HYDRANT

WATER VALVE

─W─ WATER MAIN

DOWNSPOUT

—G— GAS MAIN

GAS METER

SIGN

RIM 716.64 RIM 719.96

IE. 8" SW 709.64

IE. 12" S 709.24 IE. 15" E 714.16

IE. 15" E 709.14 IE. 15" W 715.36 CB 5

IE. 8" N 712.77

(FLOWS N)

RIM 717.27

IE. 8" NE 712.37

CB 20

IE. 8" SW 712.77

RIM 713.01

IE. 24" NW 706.08 IE. 18" W 709.61

RIM 716.28 IE. 12" SE 709.61 RIM 717.40

IE. 24" S 706.18 IE. 18" E 709.41 IE. 8" E 713.35

CB 14

IE. 24" NE 709.72

IE. 27" S 704.25

IE. 27" N 704.20

CB 25

RIM 715.45

RIM 719.17

IE. 4" NE 714.02

IE. 8" NNE 694.24

IE. 8" NNE 704.24

IE. 15" SW/NE 693.33

RIM 716.63

SAN 5

ELECTRIC PEDESTAL

ELECTRIC MANHOLE

COMMUNICATION BOX

—**CM**— COMMUNICATION LINE

■ ELECTRIC METER

─E ELECTRIC LINE

★ CHISEL "X"

3/4 REBAR SET

∑
1" IRON PIPE FOUND

♦ WATER CONTROL VALVE
♠ "PK" NAIL

—x — FENCE

—oH─ OVERHEAD WIRES

EXISTING UTILITIES ARE SHOWN FOR INFORMATIONAL PURPOSES

INCLUSIVE. CONTRACTOR IS RESPONSIBLE FOR VERIFYING THE

TYPE, LOCATION, SIZE AND ELEVATION OF UNDERGROUND UTILITIES

AS THEY DEEM NECESSARY FOR PROPOSED UTILITY CONNECTIONS

AND / OR TO AVOID DAMAGE THERETO, CONTRACTOR SHALL CALL


ONLY AND ARE NOT GUARANTEED TO BE ACCURATE OR ALL

"DIGGER'S HOTLINE" PRIOR TO ANY CONSTRUCTION.

2015.0026.10

Call or (800) 242-8511

www.DiggersHotline.com

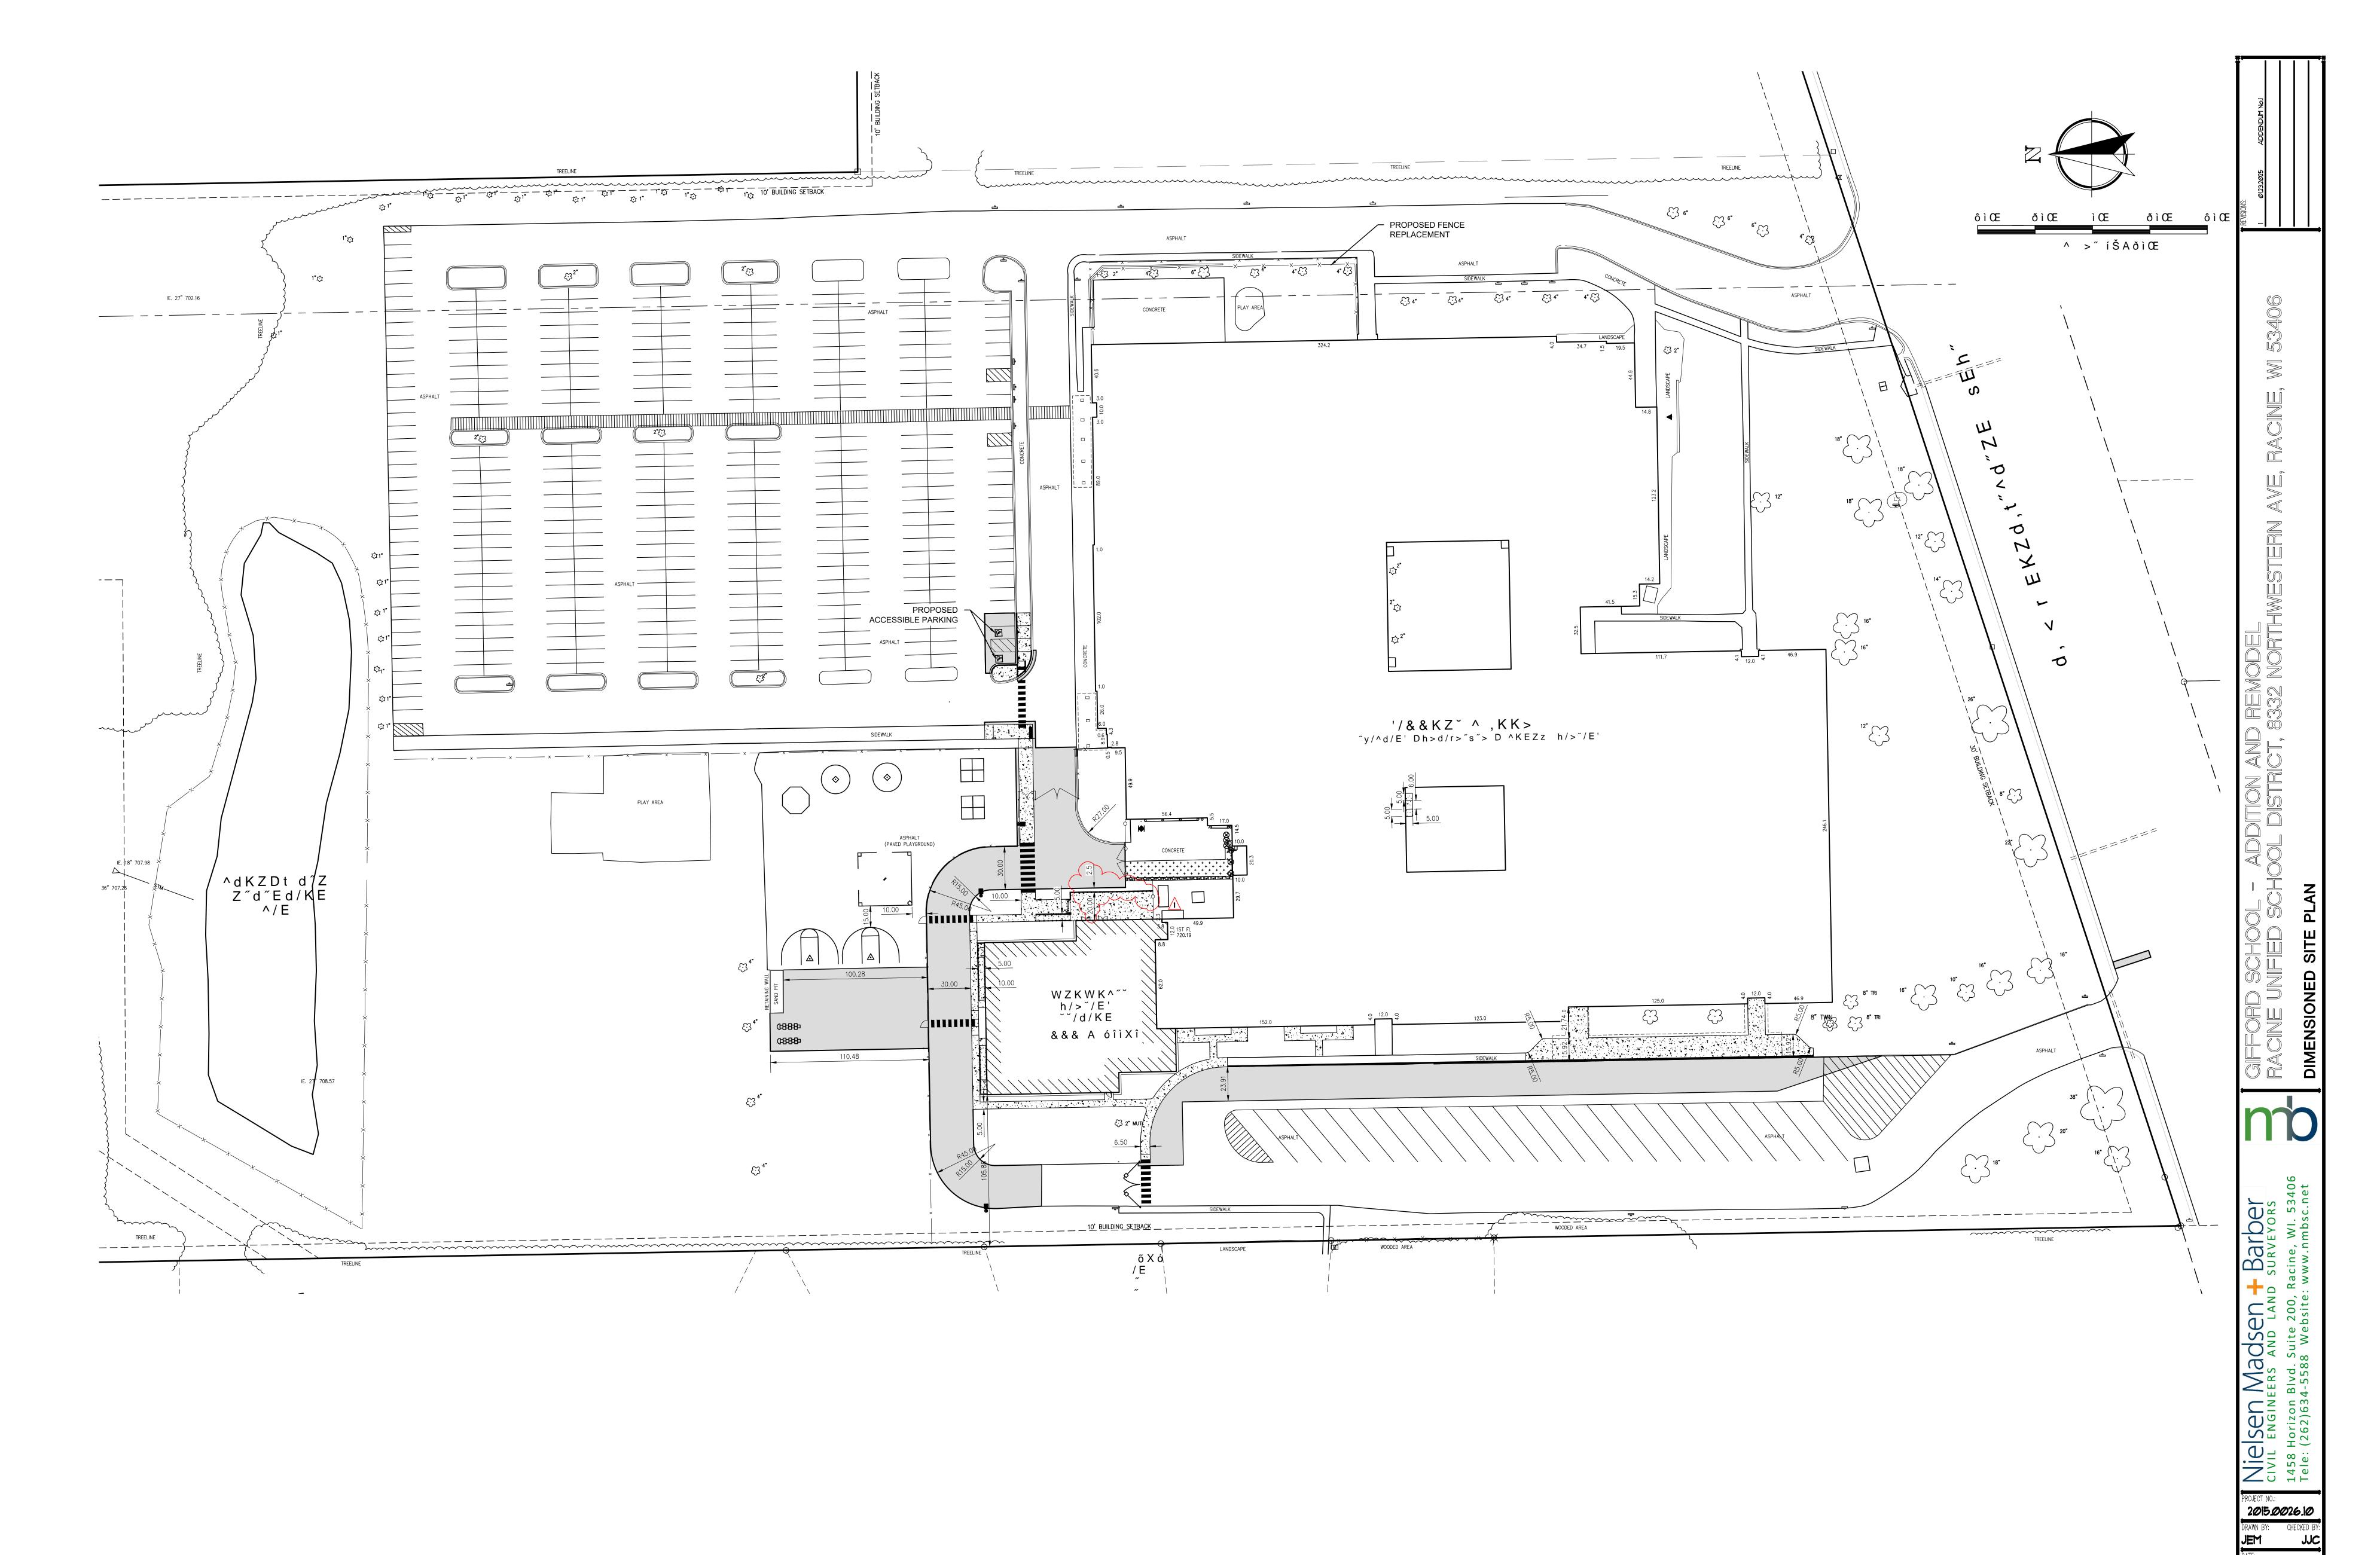


UTILITY NOTE

EXISTING UTILITIES ARE SHOWN FOR INFORMATIONAL PURPOSES ONLY AND ARE NOT GUARANTEED TO BE ACCURATE OR ALL INCLUSIVE. CONTRACTOR IS RESPONSIBLE FOR VERIFYING THE TYPE, LOCATION, SIZE AND ELEVATION OF UNDERGROUND UTILITIES AS THEY DEEM NECESSARY FOR PROPOSED UTILITY CONNECTIONS AND / OR TO AVOID DAMAGE THERETO, CONTRACTOR SHALL CALL "DIGGER'S HOTLINE" PRIOR TO ANY CONSTRUCTION.



Ø1.Ø9.2Ø25



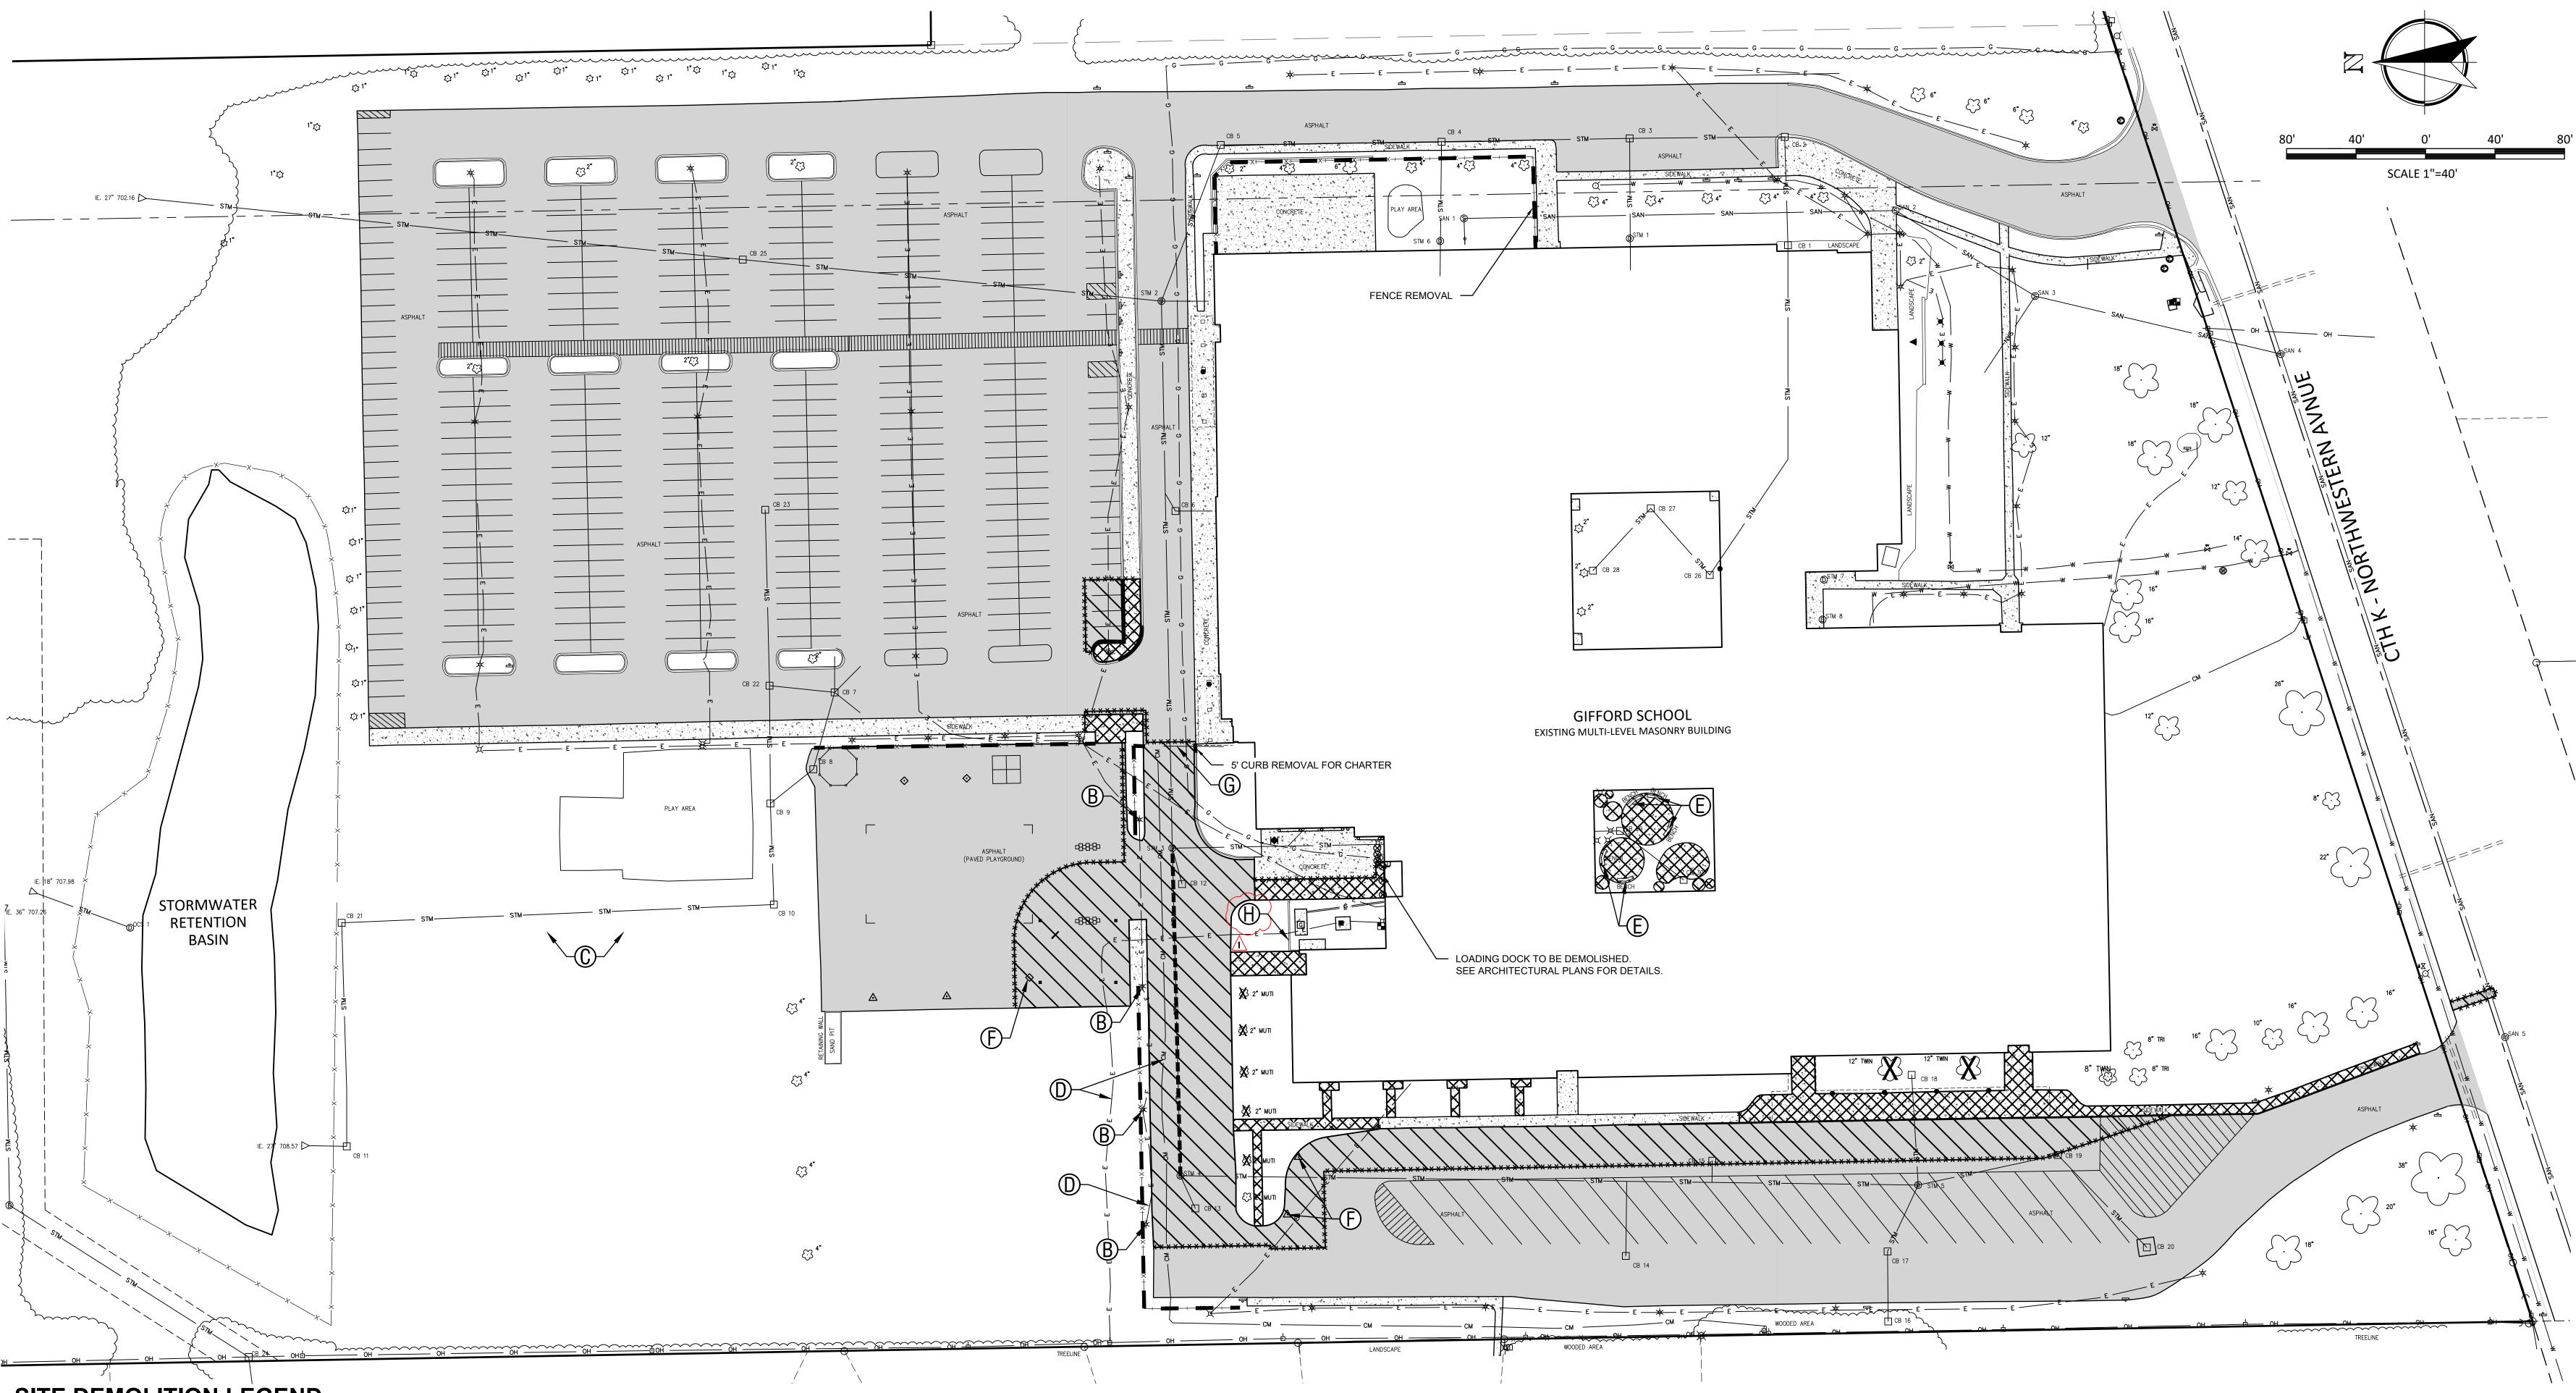

SITE DEMOLITION LEGEND

****** SAW CUT PAVEMENT (FULL DEPTH)

REMOVE CONCRETE CURB

==== REMOVE STORM SEWER

REMOVE FENCE, POSTS & FOUNDATIONS

REMOVE ASPHALT PAVEMENT & BASE

REMOVE CONCRETE PAVEMENT & BASE

CLEAR AND GRUB ISOLATED TREES

- REMOVE STORM STRUCTURE
- REMOVE LIGHT POLE
- REMOVE EXPOSED CONCRETE / RUBBLE AND RESTORE AREA TO LAWN
- EXISTING PUBLIC UTILITY TO BE RELOCATED (CONTRACTOR TO COORDINATED WITH INDIVIDUAL UTILITY)
- SALVAGE BENCH TO OWNER
- REMOVE AND SALVAGE BASKETBALL HOOP/FUNNEL BALL AND POLE TO OWNER. DISPOSE OF FOUNDATION.
- REMOVE GATE
- REMOVE RETAINING WALL AND FOUNDATIONS.

DEMOLITION NOTES

THE CONTRACTOR IS RESPONSIBLE FOR THE DEMOLITION, REMOVAL, AND DISPOSAL AT A LOCATION APPROVED (BY ALL GOVERNING AUTHORITIES) OF ALL STRUCTURES, PADS, WALLS, FLUMES, FOUNDATIONS, PAVEMENTS, DRIVES, DRAINAGE STRUCTURES, UTILITIES, ETC., SUCH THAT THE IMPROVEMENTS SHOWN ON THE REMAINING PLANS CAN BE CONSTRUCTED. ALL FACILITIES TO BE REMOVED SHALL BE UNDERCUT TO SUITABLE MATERIAL AND BROUGHT TO GRADE WITH SUITABLY COMPACTED FILL MATERIAL PER THE SPECIFICATIONS

THE CONTRACTOR IS RESPONSIBLE FOR REMOVING ALL DEBRIS FROM THE SITE AND DISPOSING THE DEBRIS IN A CLEARING, AND DISPOSAL.

THE CONTRACTOR SHALL COORDINATE WITH RESPECTIVE UTILITY COMPANIES PRIOR TO THE REMOVAL AND/OR RELOCATION OF UTILITIES. THE CONTRACTOR SHALL COORDINATE WITH THE UTILITY COMPANY CONCERNING PORTIONS OF WORK WHICH MAY BE PERFORMED BY THE UTILITY COMPANY'S FORCES AND ANY FEES WHICH ARE TO BE PAID TO THE UTILITY COMPANY FOR THEIR SERVICES. THE CONTRACTOR IS RESPONSIBLE FOR PAYING ALL FEES

THE LOCATIONS OF ALL EXISTING UTILITIES SHOWN ON THIS PLAN HAVE BEEN DETERMINED FROM THE BEST INFORMATION AVAILABLE AND ARE GIVEN FOR THE CONVENIENCE OF THE CONTRACTOR. THE LAND SURVEYOR AND ENGINEER OF RECORD ASSUME NO RESPONSIBILITY FOR THEIR ACCURACY. PRIOR TO THE START OF ANY DEMOLITION ACTIVITY, THE CONTRACTOR SHALL NOTIFY THE UTILITY COMPANIES FOR ON-SITE LOCATIONS OF EXISTING UTILITIES.

THE CONTRACTOR SHALL BE RESPONSIBLE FOR THE COORDINATION AND DISCONNECTION OF UTILITY SERVICES TO THE EXISTING BUILDING PRIOR TO DEMOLITION OF THE BUILDING.

ALL EXISTING SEWERS, PIPING, AND UTILITIES SHOWN ARE NOT TO BE INTERPRETED AS THE EXACT LOCATION OR AS THE ONLY OBSTACLES THAT MAY OCCUR ON THE SITE. VERIFY EXISTING CONDITIONS AND PROCEED WITH CAUTION AROUND ANY ANTICIPATED FEATURES. GIVE NOTICE TO ALL UTILITY COMPANIES REGARDING DESTRUCTION AND REMOVAL OF ALL SERVICE LINES AND CAP ALL LINES BEFORE PROCEEDING WITH THE WORK.

ELECTRICAL, TELEPHONE, CABLE, WATER, FIBER OPTIC CABLE, AND/OR GAS LINES NEEDING TO BE REMOVED OR RELOCATED SHALL BE COORDINATED WITH THE AFFECTED UTILITY COMPANY. ADEQUATE TIME SHALL BE PROVIDED FOR RELOCATION AND CLOSE COORDINATION WITH THE UTILITY COMPANY IS NECESSARY TO PROVIDE A SMOOTH TRANSITION IN UTILITY SERVICE.

IT SHALL BE THE RESPONSIBILITY OF THE CONTRACTOR TO CALL DIGGERS HOTLINE AT 1-800-242-8511 A MINIMUM OF 3 WORKING DAYS PRIOR TO EXCAVATION ACTIVITIES TO LOCATE AND MARK ALL UNDERGROUND UTILITIES.

IT SHALL BE THE RESPONSIBILITY OF THE CONTRACTOR TO HIRE A PRIVATE UTILITY LOCATING SERVICE TO LOCATE AND MARK ALL UNDERGROUND PRIVATE UTILITIES.

CONTRACTOR MUST PROTECT THE PUBLIC AT ALL TIMES WITH SIGNS, FENCING, BARRICADES, ENCLOSURES, ETC., (AND OTHER APPROPRIATE BEST MANAGEMENT PRACTICES) AS APPROVED BY THE CONSTRUCTION MANAGER. TEMPORARY CLOSURE OF ANY PUBLIC ROADWAY OR SIDEWALK SHALL BE APPROVED BY THE AUTHORITY HAVING

CONTINUOUS ACCESS SHALL BE MAINTAINED FOR THE SURROUNDING PROPERTIES AT ALL TIMES DURING THE COURSE OF WORK.

PRIOR TO DEMOLITION OCCURRING, ALL EROSION CONTROL DEVICES ARE TO BE INSTALLED.

EXISTING ITEMS TO REMAIN INCLUDING, BUT NOT LIMITED TO, FENCES, SIGNS, UTILITIES, BUILDINGS, TREES, PAVEMENTS, AND LIGHT POLES SHALL BE CAREFULLY PROTECTED DURING THE DEMOLITION PROCESS. ANY DAMAGE SUSTAINED TO ITEMS TO REMAIN IN PLACE SHALL BE REPAIRED OR REPLACED AT THE CONTRACTOR'S EXPENSE AT NO ADDITIONAL COST TO THE OWNER.

PROPERTY CORNERS AND BENCHMARKS SHALL BE CAREFULLY PROTECTED UNTIL THEY HAVE BEEN REFERENCED BY BE REPLACED AT THE CONTRACTOR'S EXPENSE AT NO ADDITIONAL COST TO THE OWNER.

CONTRACTOR SHALL LIMIT PAVEMENT REMOVALS TO ONLY THOSE AREAS AS SHOWN ON THESE CONSTRUCTION PLANS OR AS NECESSARY TO COMPLETE THE WORK. CONCRETE SIDEWALK AND CURB & GUTTER IS TO BE REMOVED TO NEAREST JOINT IN ORDER TO ACCOMMODATE PROPOSED IMPROVEMENTS. IF ANY DAMAGE IS INCURRED ON ANY OF THE SURROUNDING PAVEMENTS AND OR OTHER IMPROVEMENTS, THE CONTRACTOR SHALL BE RESPONSIBLE FOR REMOVAL AND REPAIR OF DAMAGED PAVEMENT AND OTHER ITEMS AT NO ADDITIONAL COST TO THE OWNER.

ABANDONMENT OF UTILITIES SHALL BE IN ACCORDANCE WITH SECTION 3.2.24 OF THE "STANDARD SPECIFICATIONS".

IF PREVIOUSLY UNIDENTIFIED HAZARDOUS, CONTAMINATED MATERIALS, OR OTHER ENVIRONMENTAL RELATED CONDITIONS ARE DISCOVERED, STOP WORK IMMEDIATELY AND NOTIFY THE PROJECT CONSTRUCTION MANAGER FOR ACTION TO BE TAKEN. DO NOT RESUME WORK UNTIL SPECIFICALLY AUTHORIZED BY THE CONSTRUCTION MANAGER.

AT THE COMPLETION OF THE PROJECT, THE CONTRACTOR SHALL REMOVE AND DISPOSE OF ALL ABANDONED, EXCESS, WASTE, STOCKPILED AND SPOIL MATERIAL IN ACCORDANCE WITH SECTION 205.3.12 OF THE "STATE SPECIFICATIONS". THIS WORK SHALL BE DONE AT THE CONTRACTOR'S EXPENSE.

UTILITY NOTE

EXISTING UTILITIES ARE SHOWN FOR INFORMATIONAL PURPOSES ONLY AND ARE NOT GUARANTEED TO BE ACCURATE OR ALL INCLUSIVE. CONTRACTOR IS RESPONSIBLE FOR VERIFYING THE TYPE, LOCATION, SIZE AND ELEVATION OF UNDERGROUND UTILITIES AS THEY DEEM NECESSARY FOR PROPOSED UTILITY CONNECTIONS AND / OR TO AVOID DAMAGE THERETO, CONTRACTOR SHALL CALL "DIGGER'S HOTLINE" PRIOR TO ANY CONSTRUCTION.








Niels CIVIL EI 1458 HOI Tele: (**)

2015.0026.10

01.09.2025

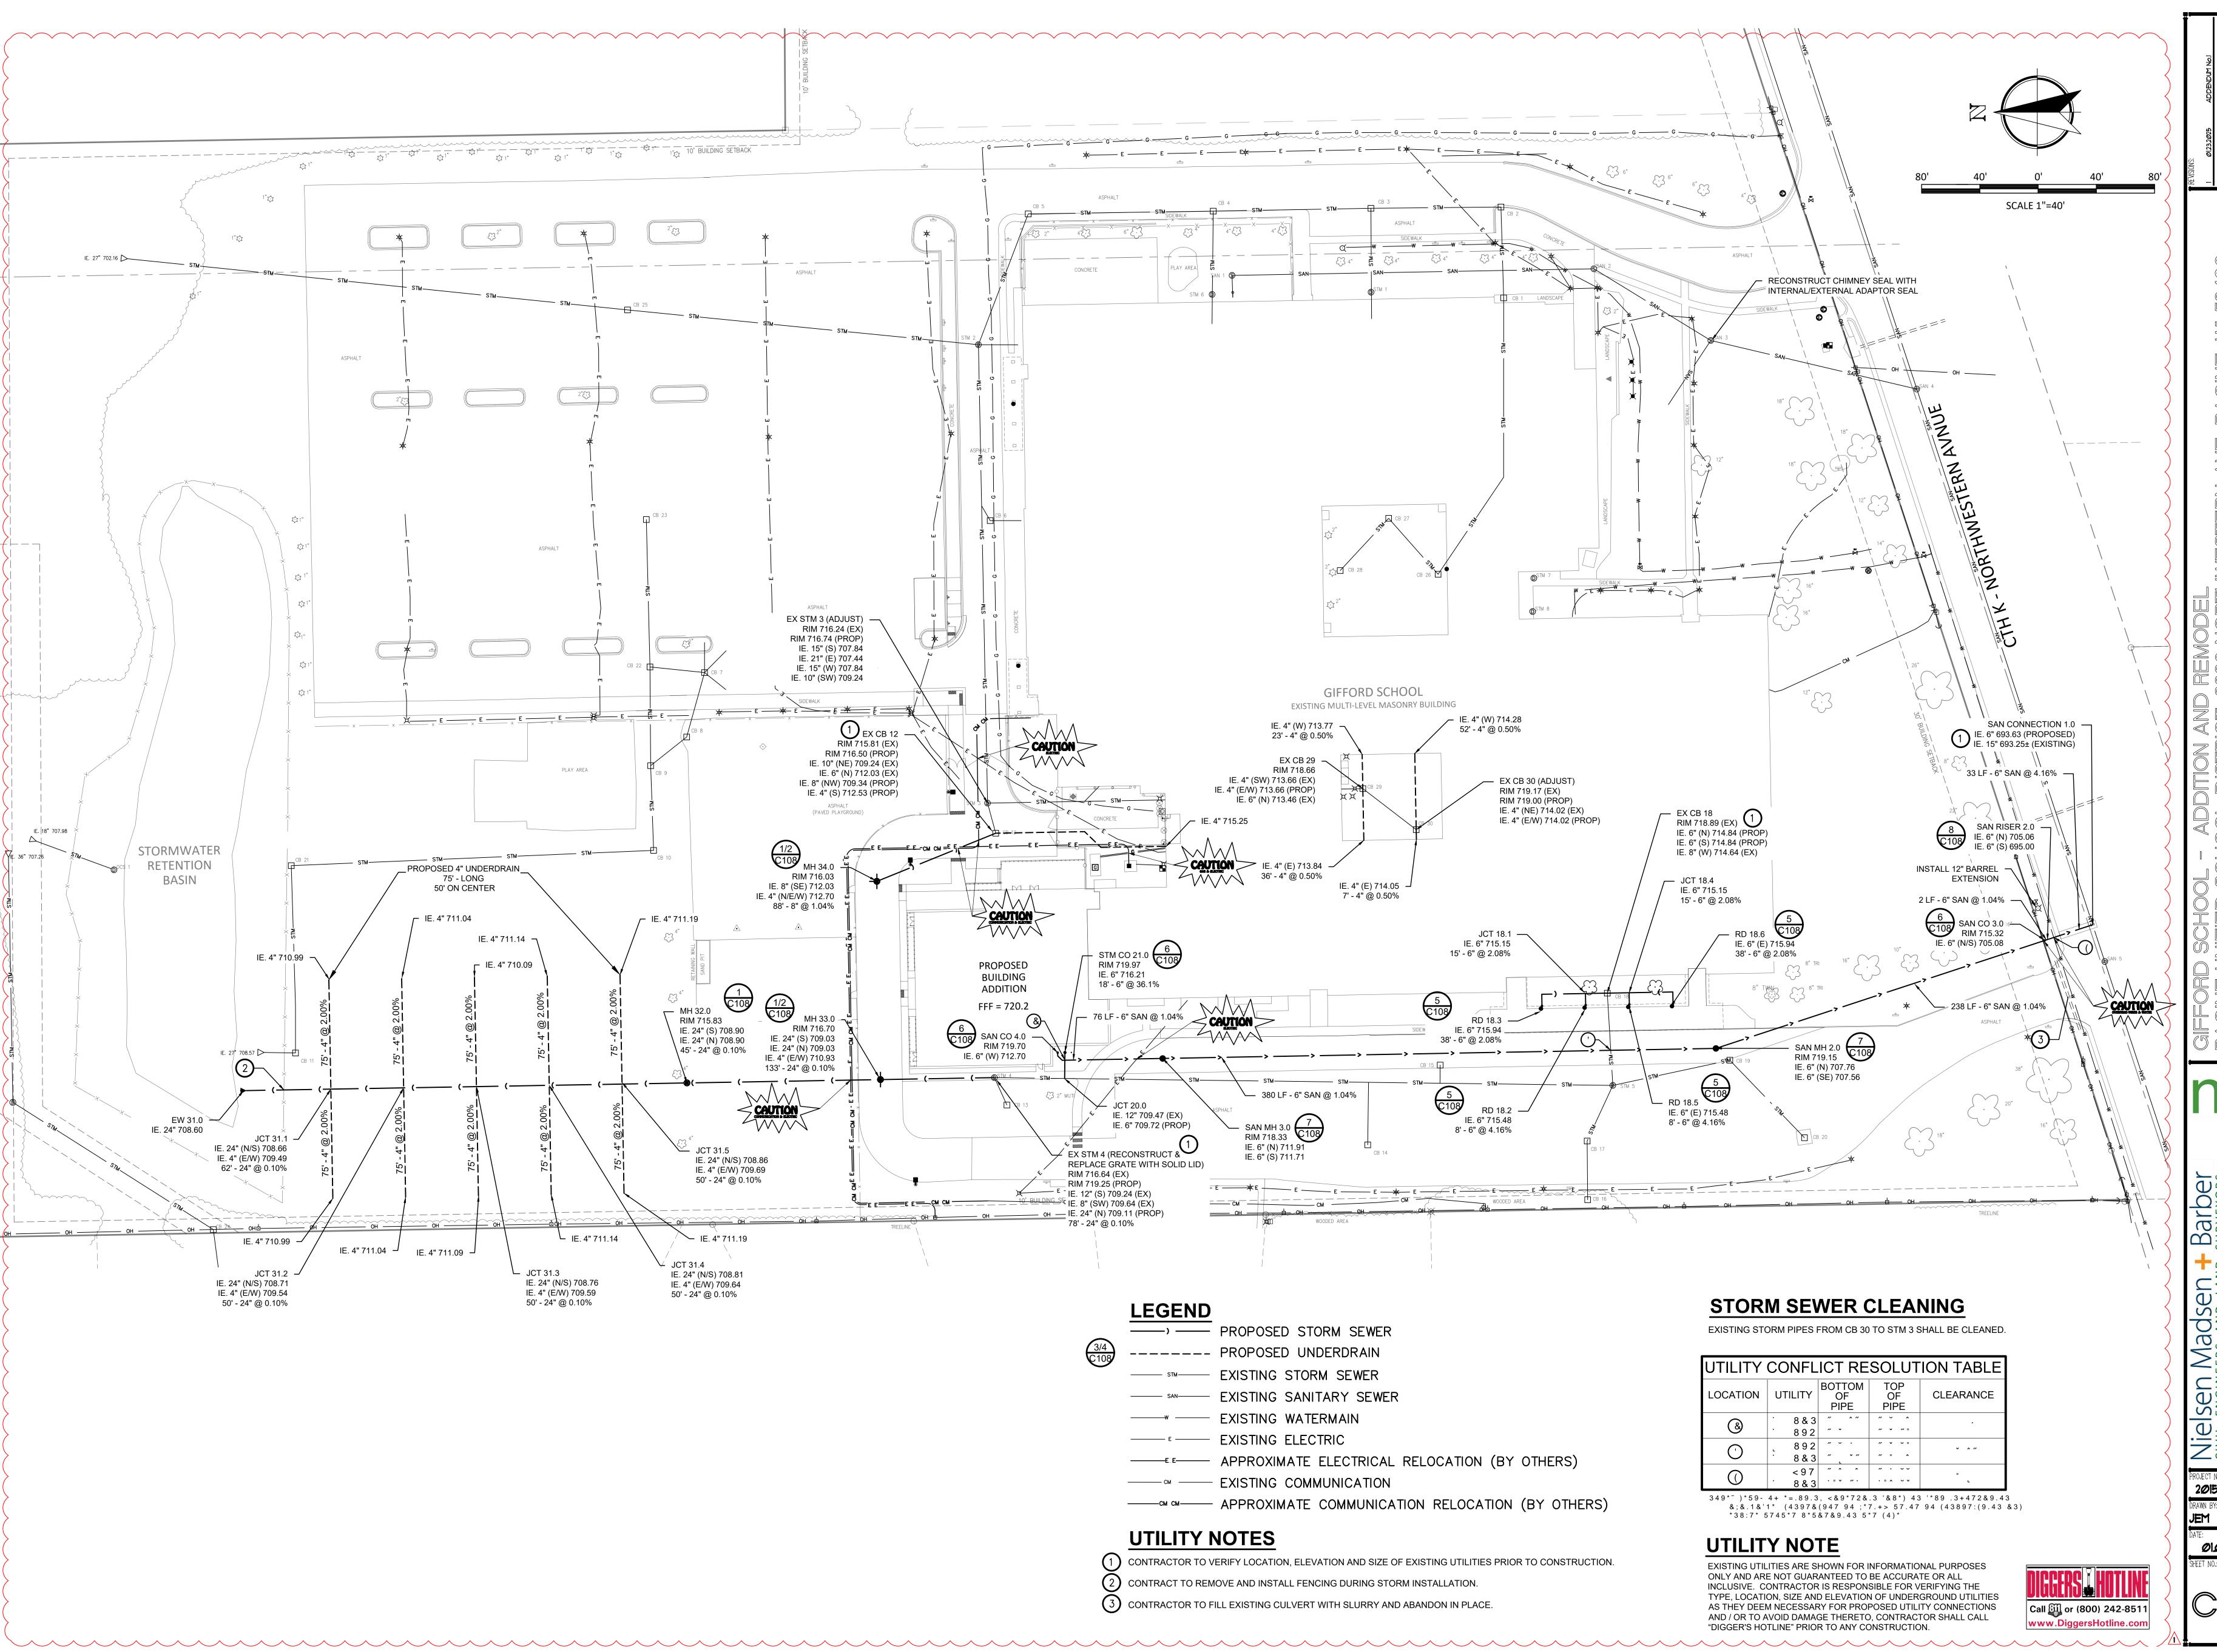


Barber

Niels CIVIL EI 1458 Ho Tele: (26

2015.0026.10

Ø1.Ø9.2Ø25

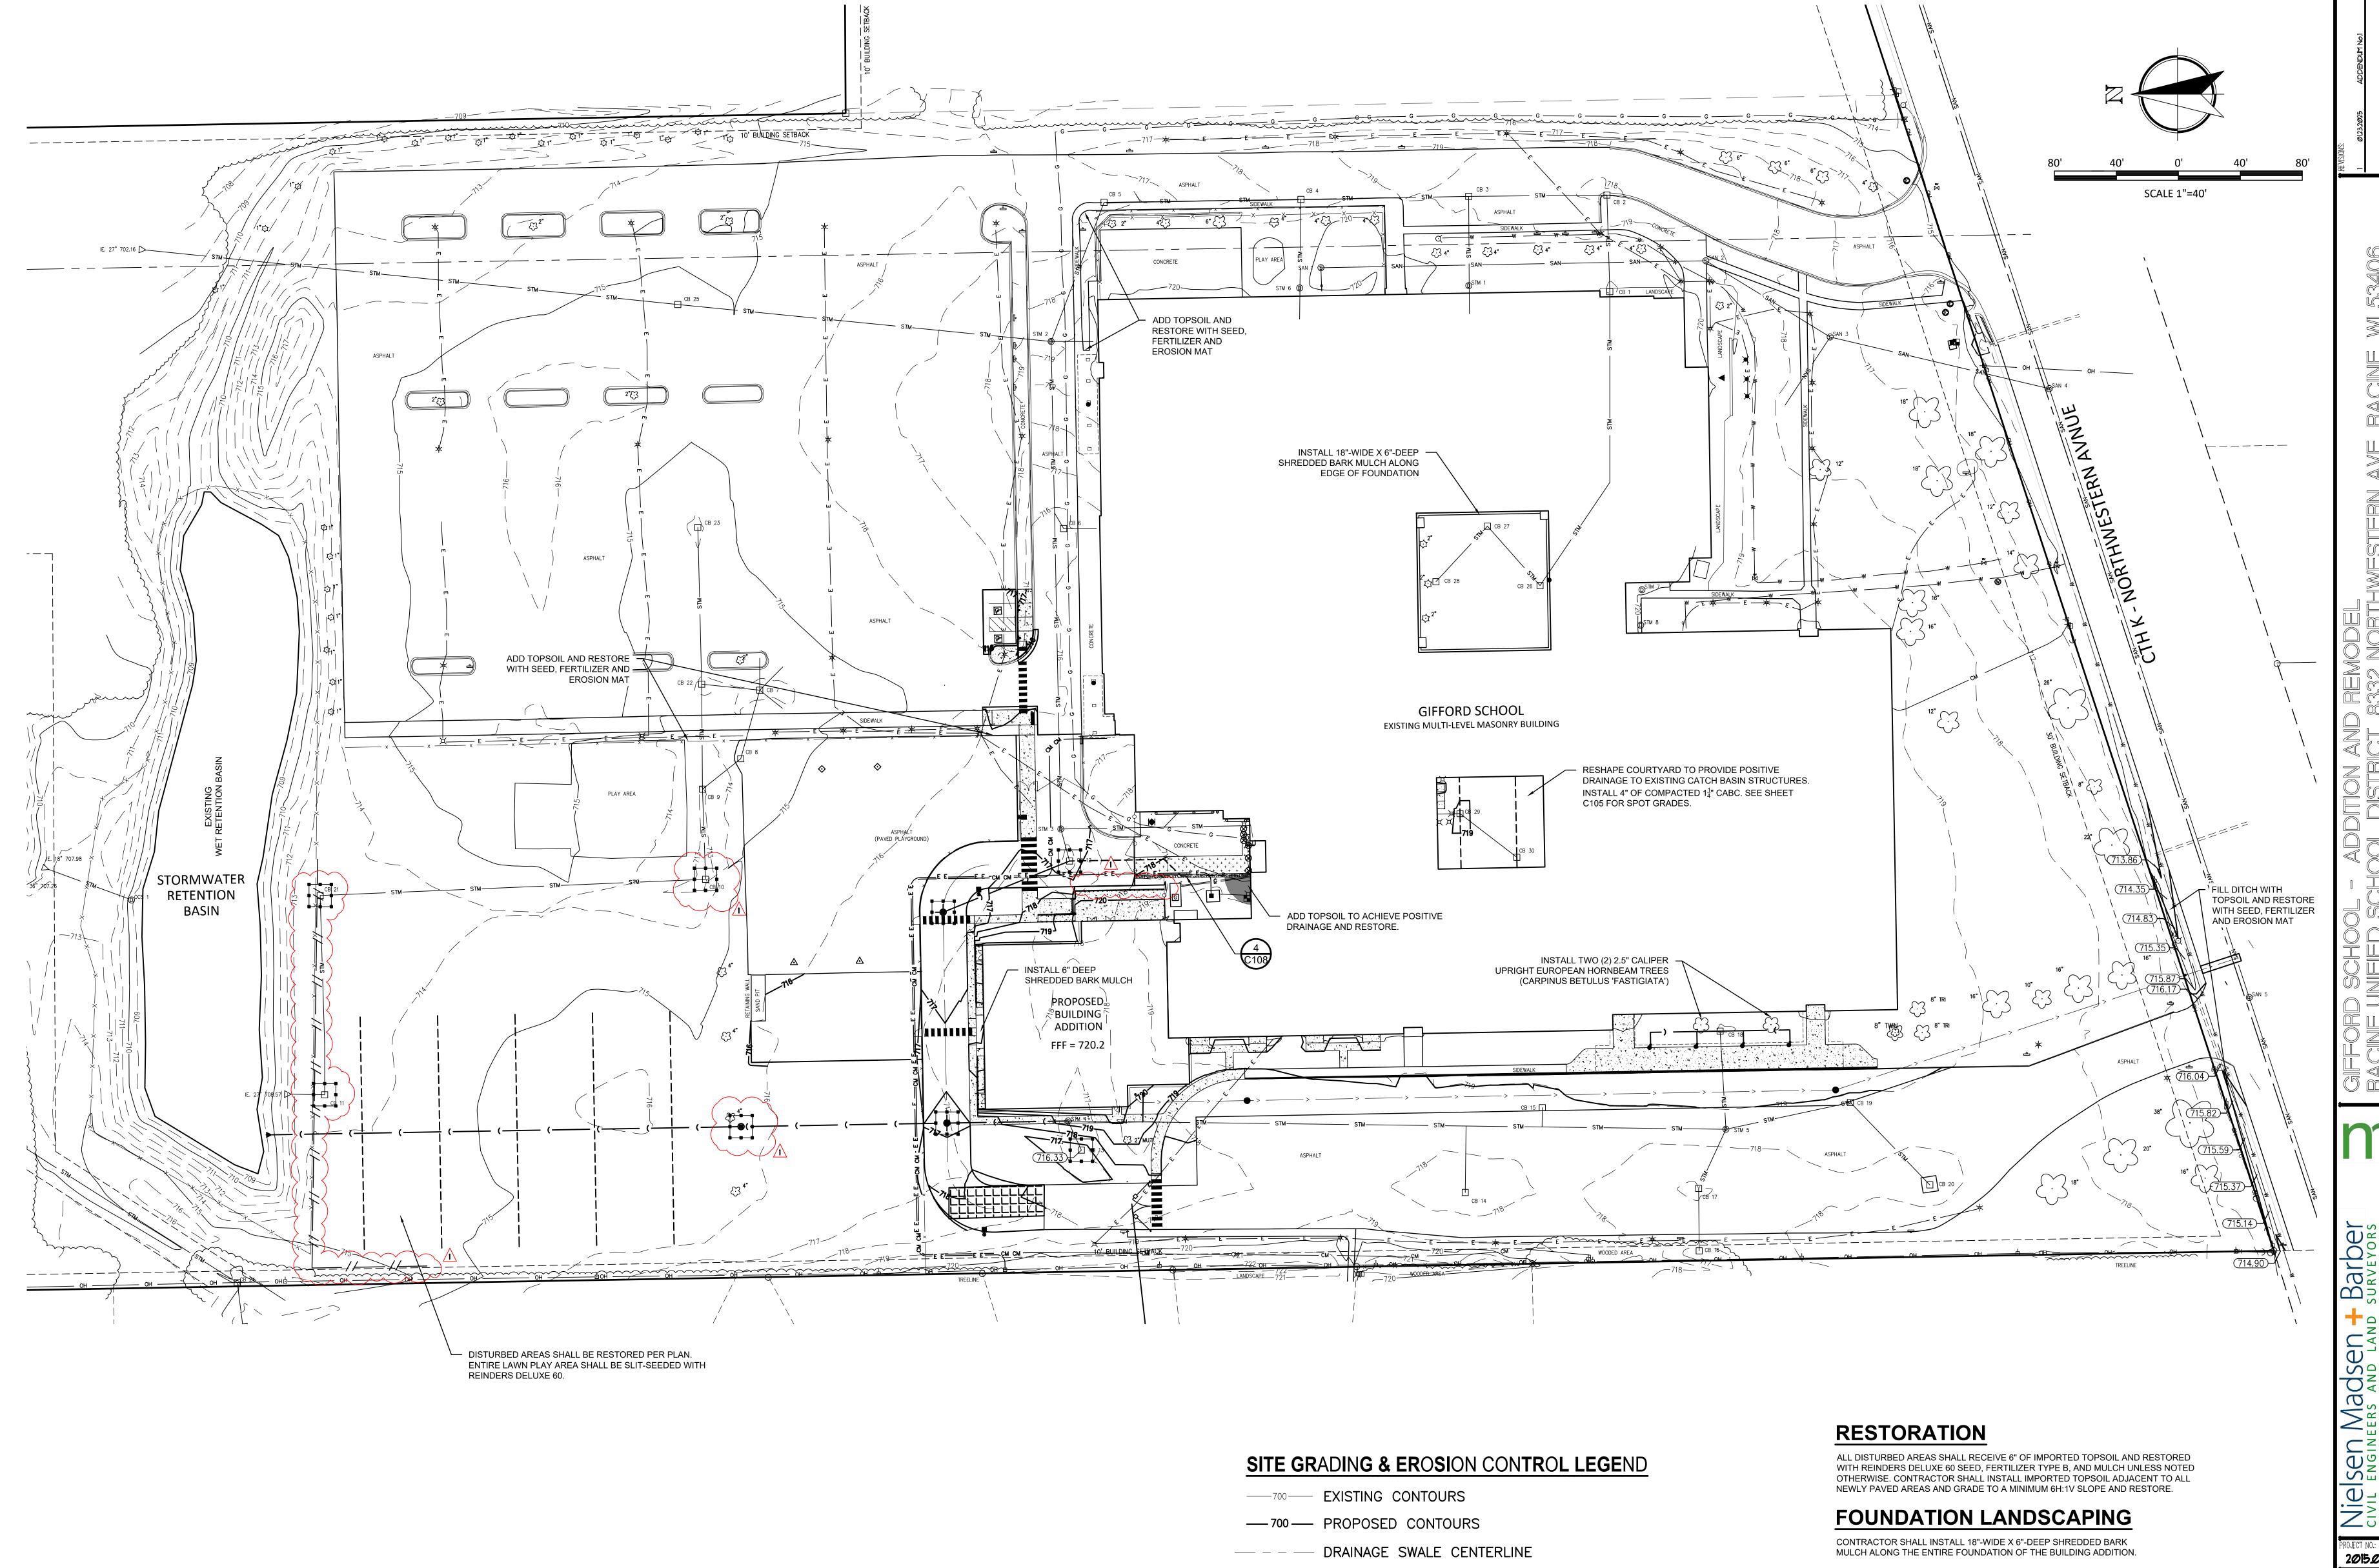

____ SILT FENCE

STONE TRACKING PAD

FINISHED YARD GRADE

STORM INLET PROTECTION

UTILITY NOTE


EXISTING UTILITIES ARE SHOWN FOR INFORMATIONAL PURPOSES ONLY AND ARE NOT GUARANTEED TO BE ACCURATE OR ALL INCLUSIVE. CONTRACTOR IS RESPONSIBLE FOR VERIFYING THE TYPE, LOCATION, SIZE AND ELEVATION OF UNDERGROUND UTILITIES AS THEY DEEM NECESSARY FOR PROPOSED UTILITY CONNECTIONS AND / OR TO AVOID DAMAGE THERETO, CONTRACTOR SHALL CALL "DIGGER'S HOTLINE" PRIOR TO ANY CONSTRUCTION.



Nielsen CIVIL ENGINE 1458 Horizon E Tele: (262)624

2015.0026.10 Ø1.Ø9.2Ø25


C104

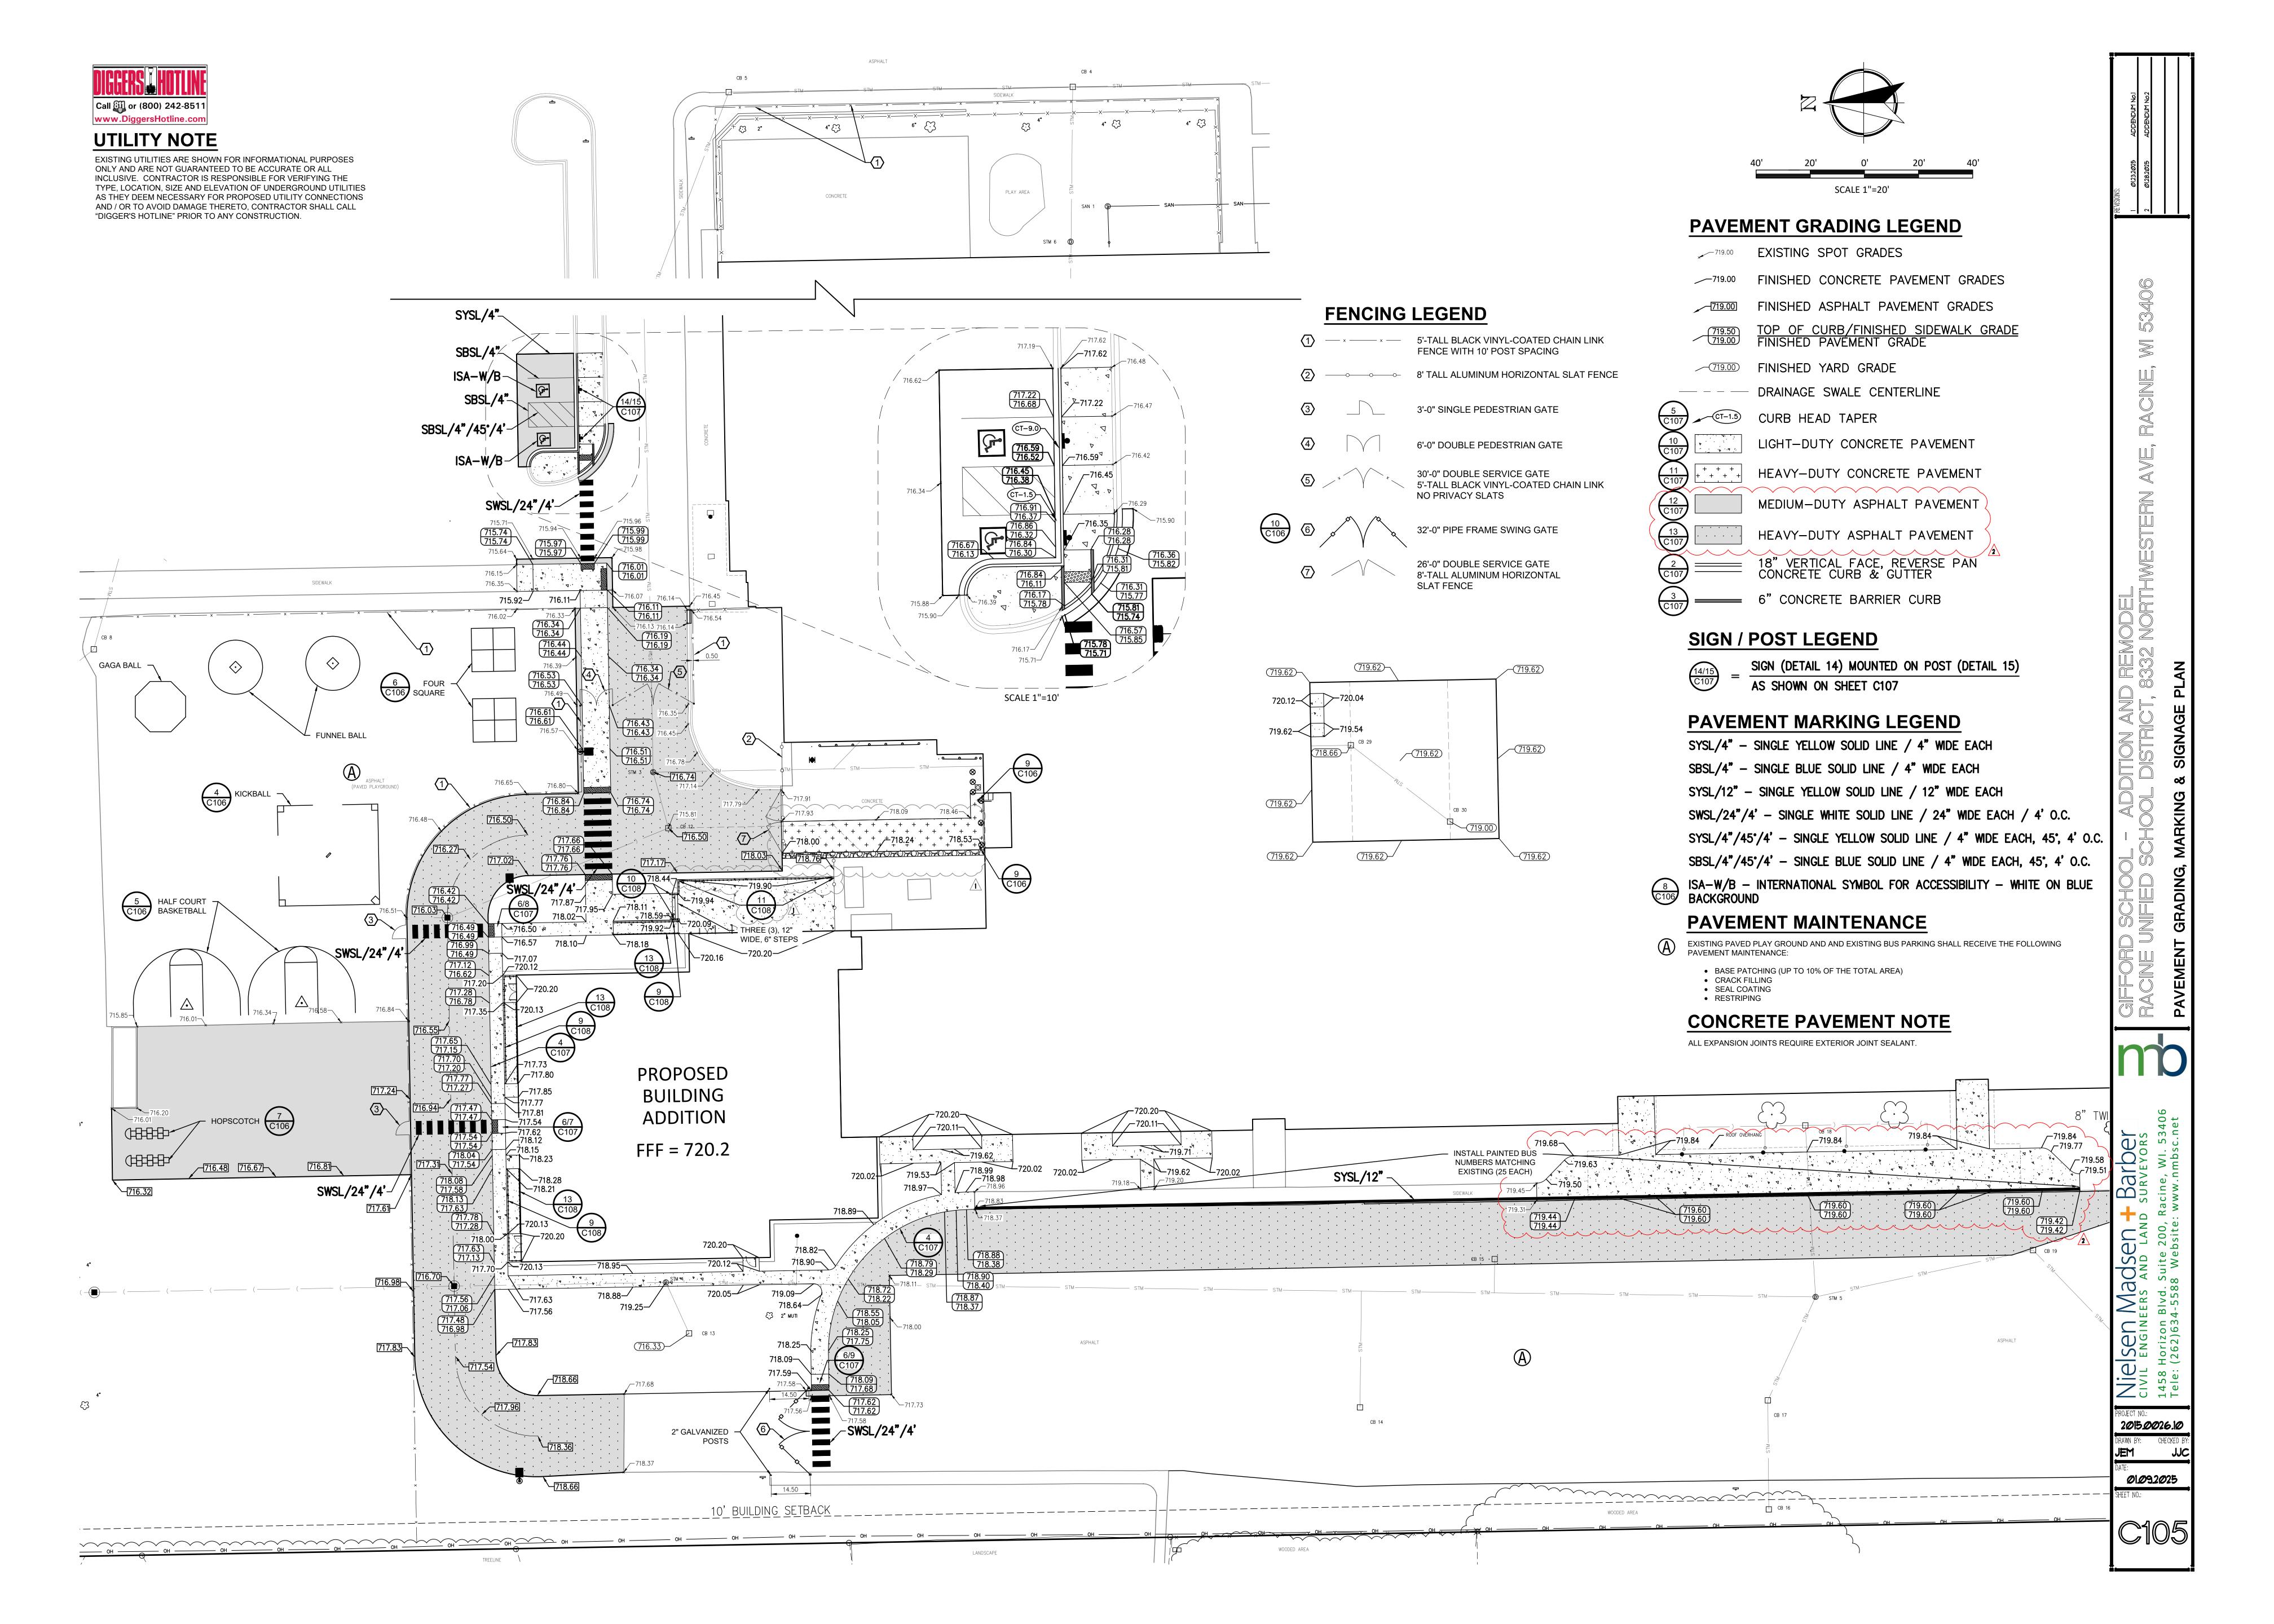



N.T.S.


N.T.S.

Ø1.Ø9.2Ø25

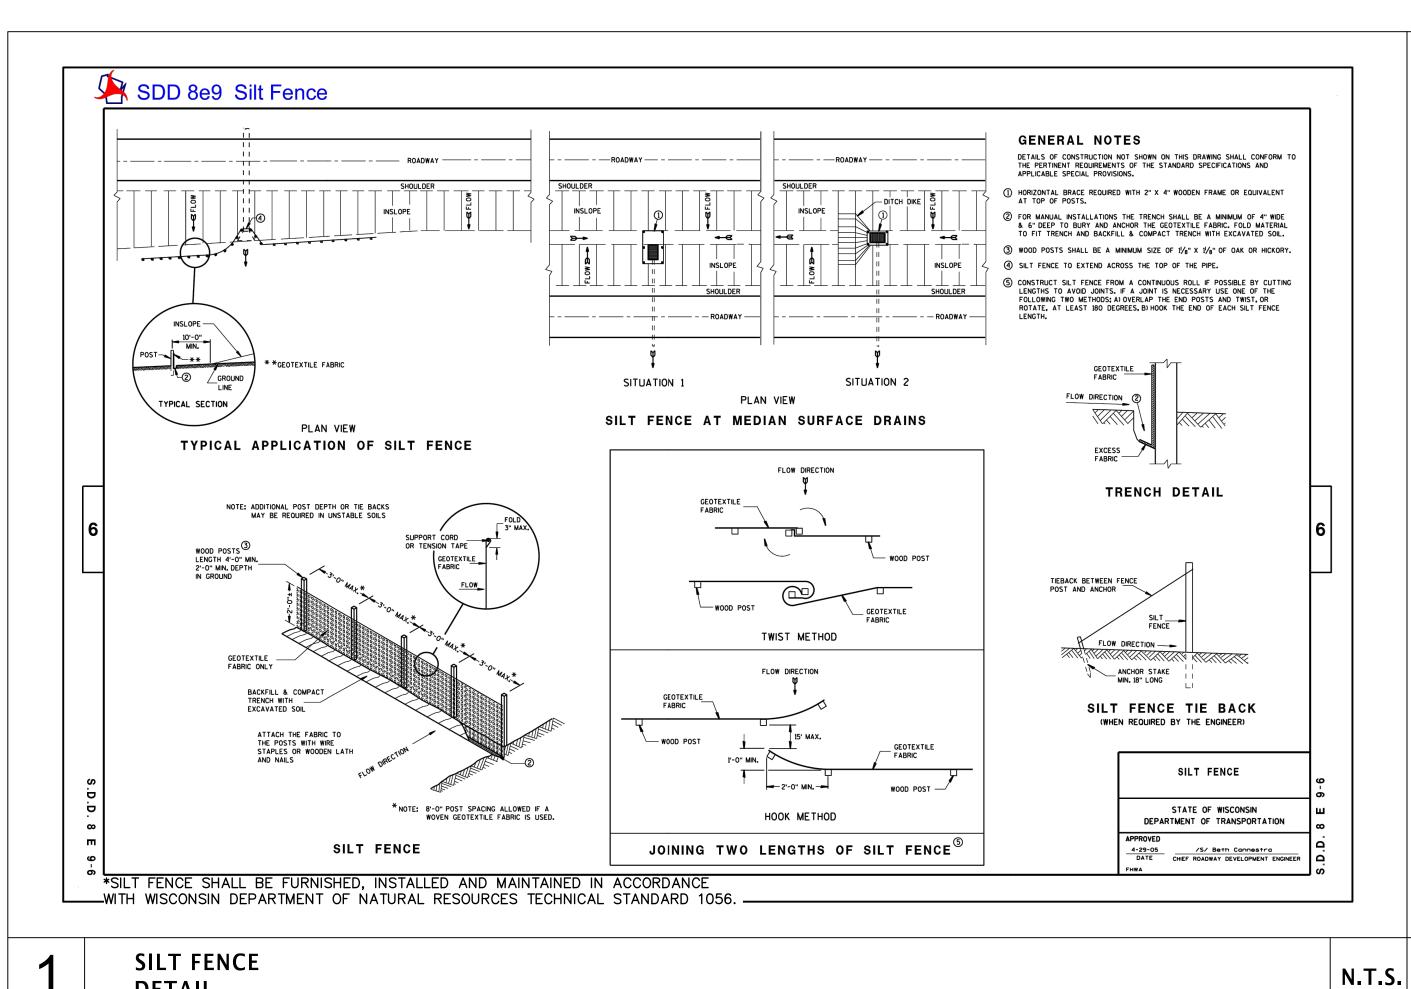

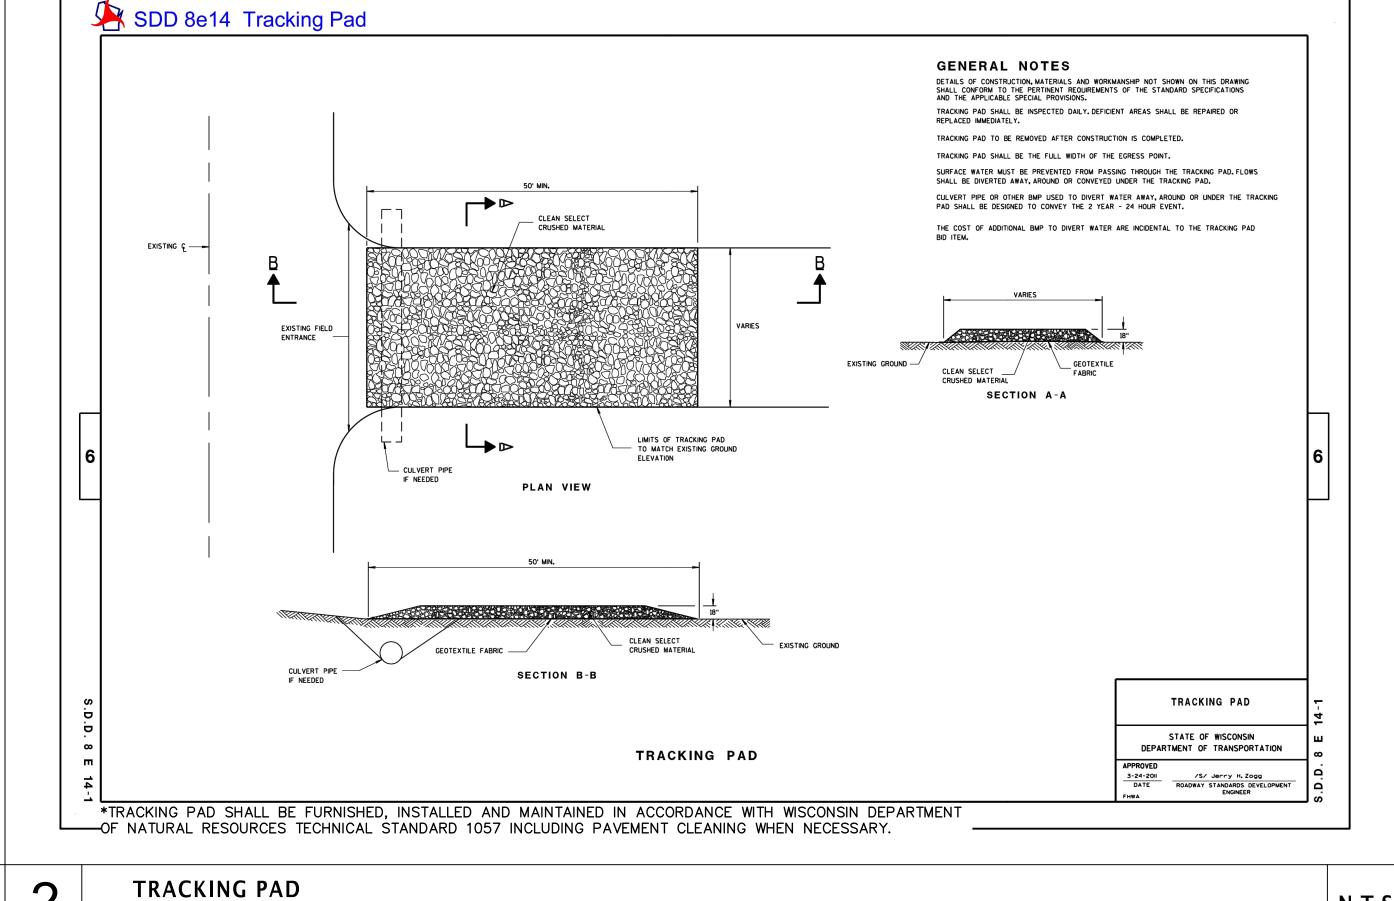


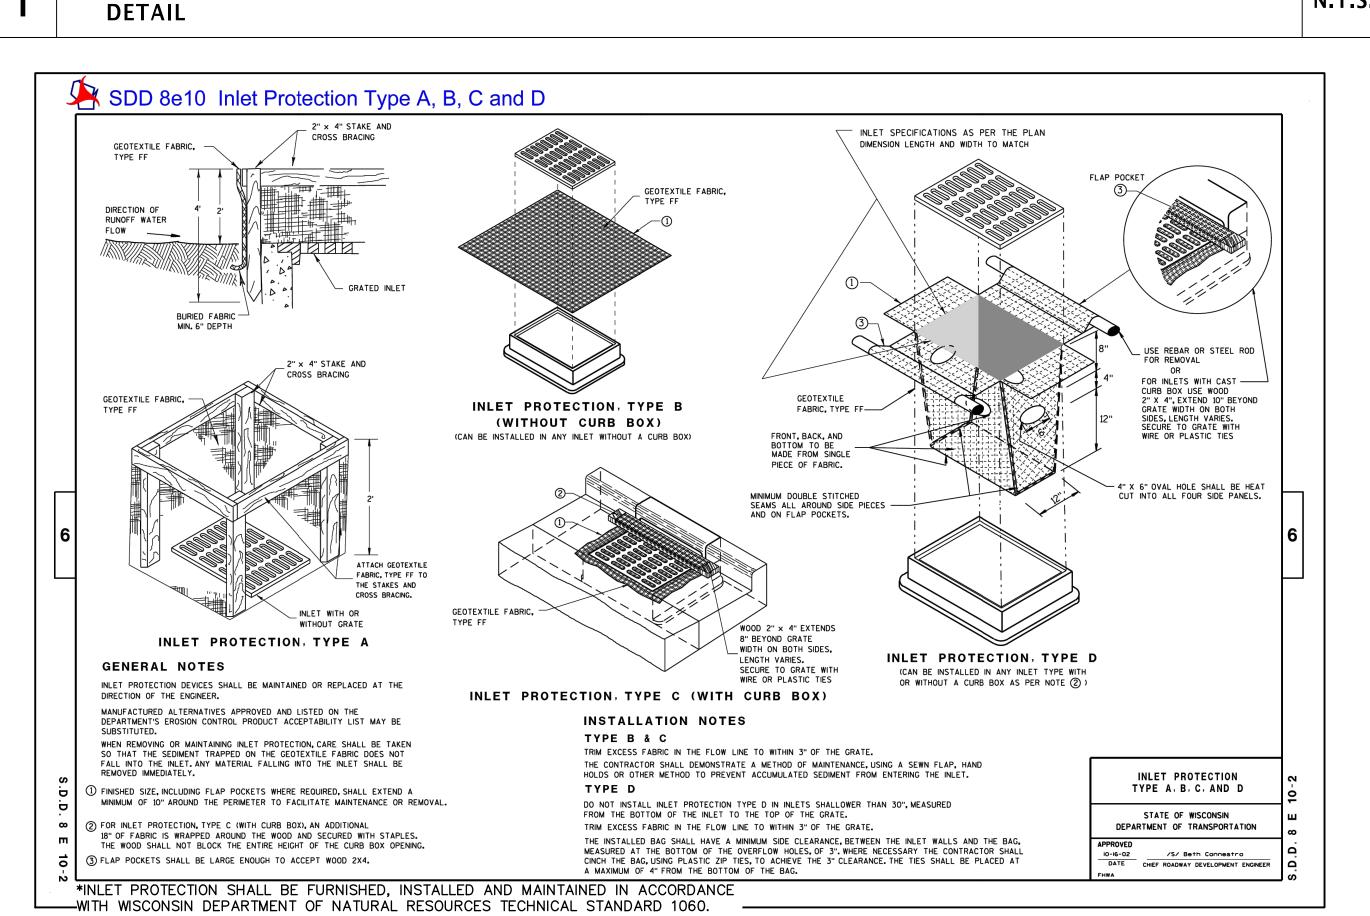

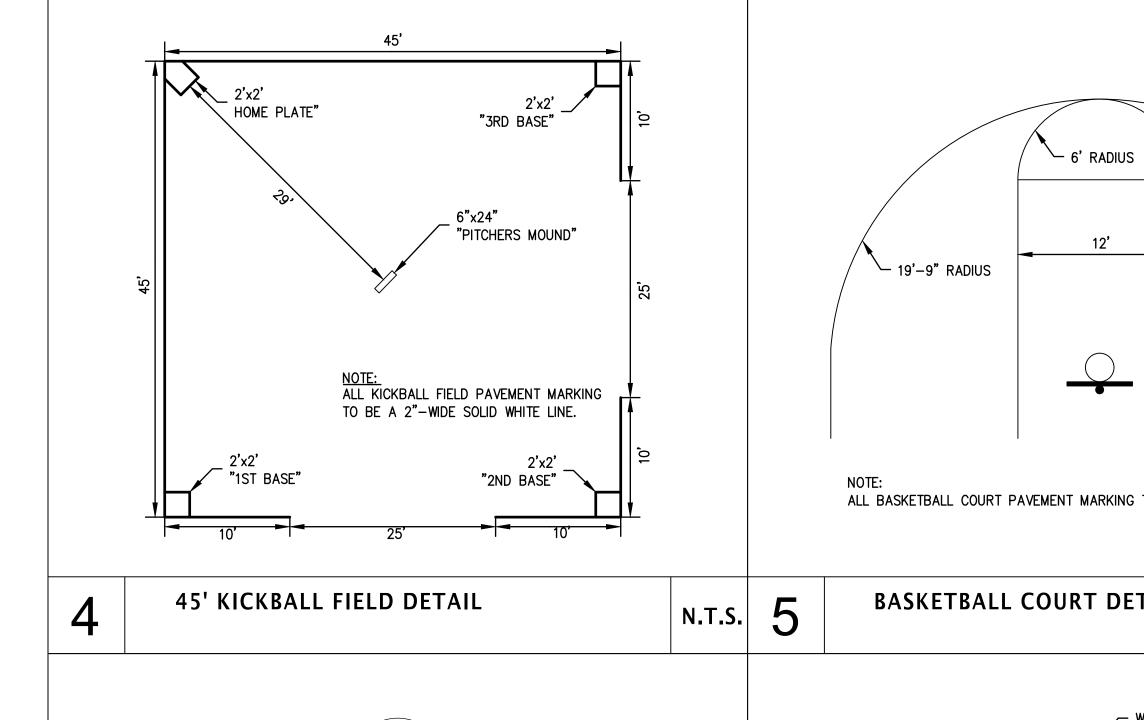

ALL BASKETBALL COURT PAVEMENT MARKING TO BE 2"-WIDE SOLID WHITE LINES.

HOPSCOTCH COURT DETAIL

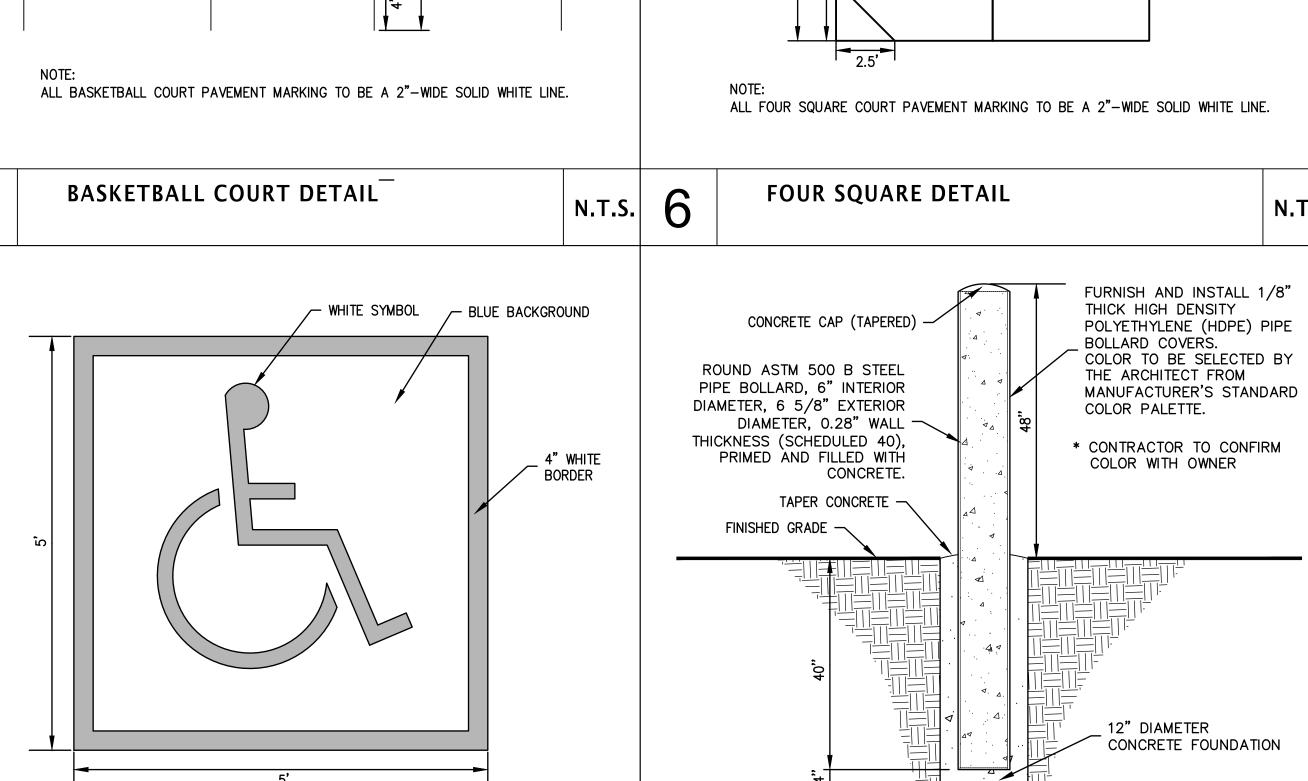

9

N.T.S.


PAINTED INTERNATIONAL SYMBOL

FOR ACCESSIBILITY DETAIL

6" STEEL PIPE BOLLARD

DETAIL

N.T.S.

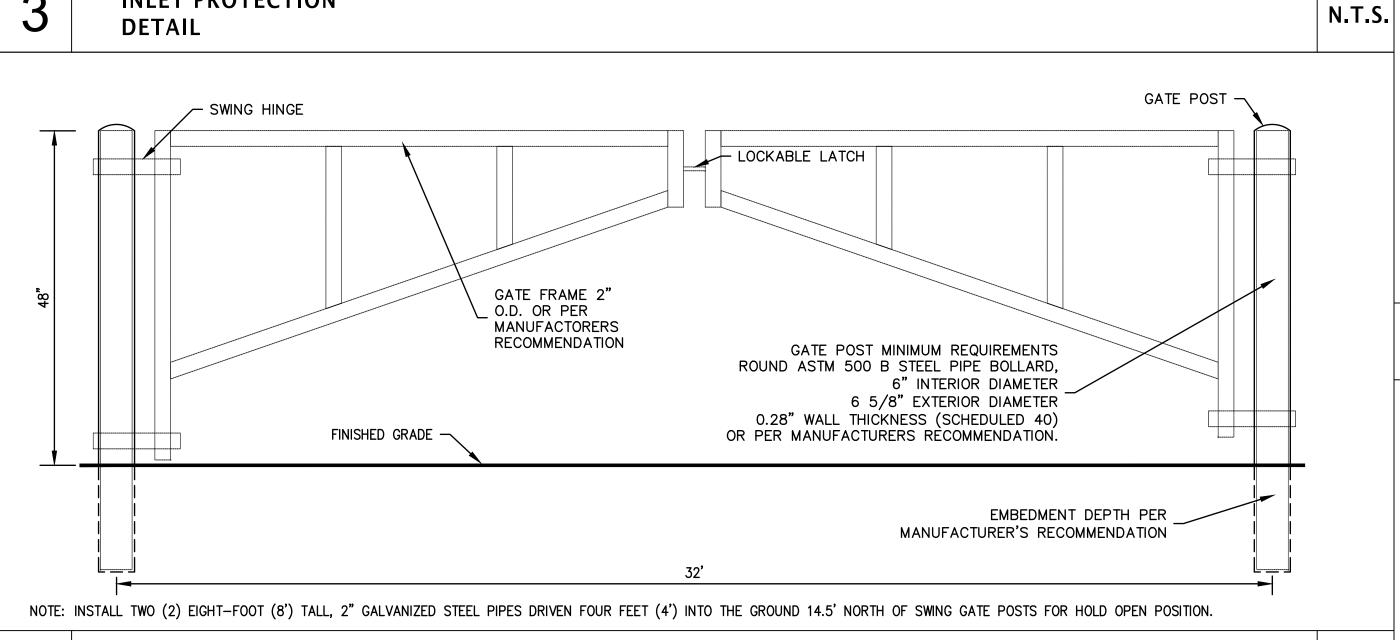



INLET PROTECTION


PIPE FRAME SWING GATE

DETAIL

N.T.S.

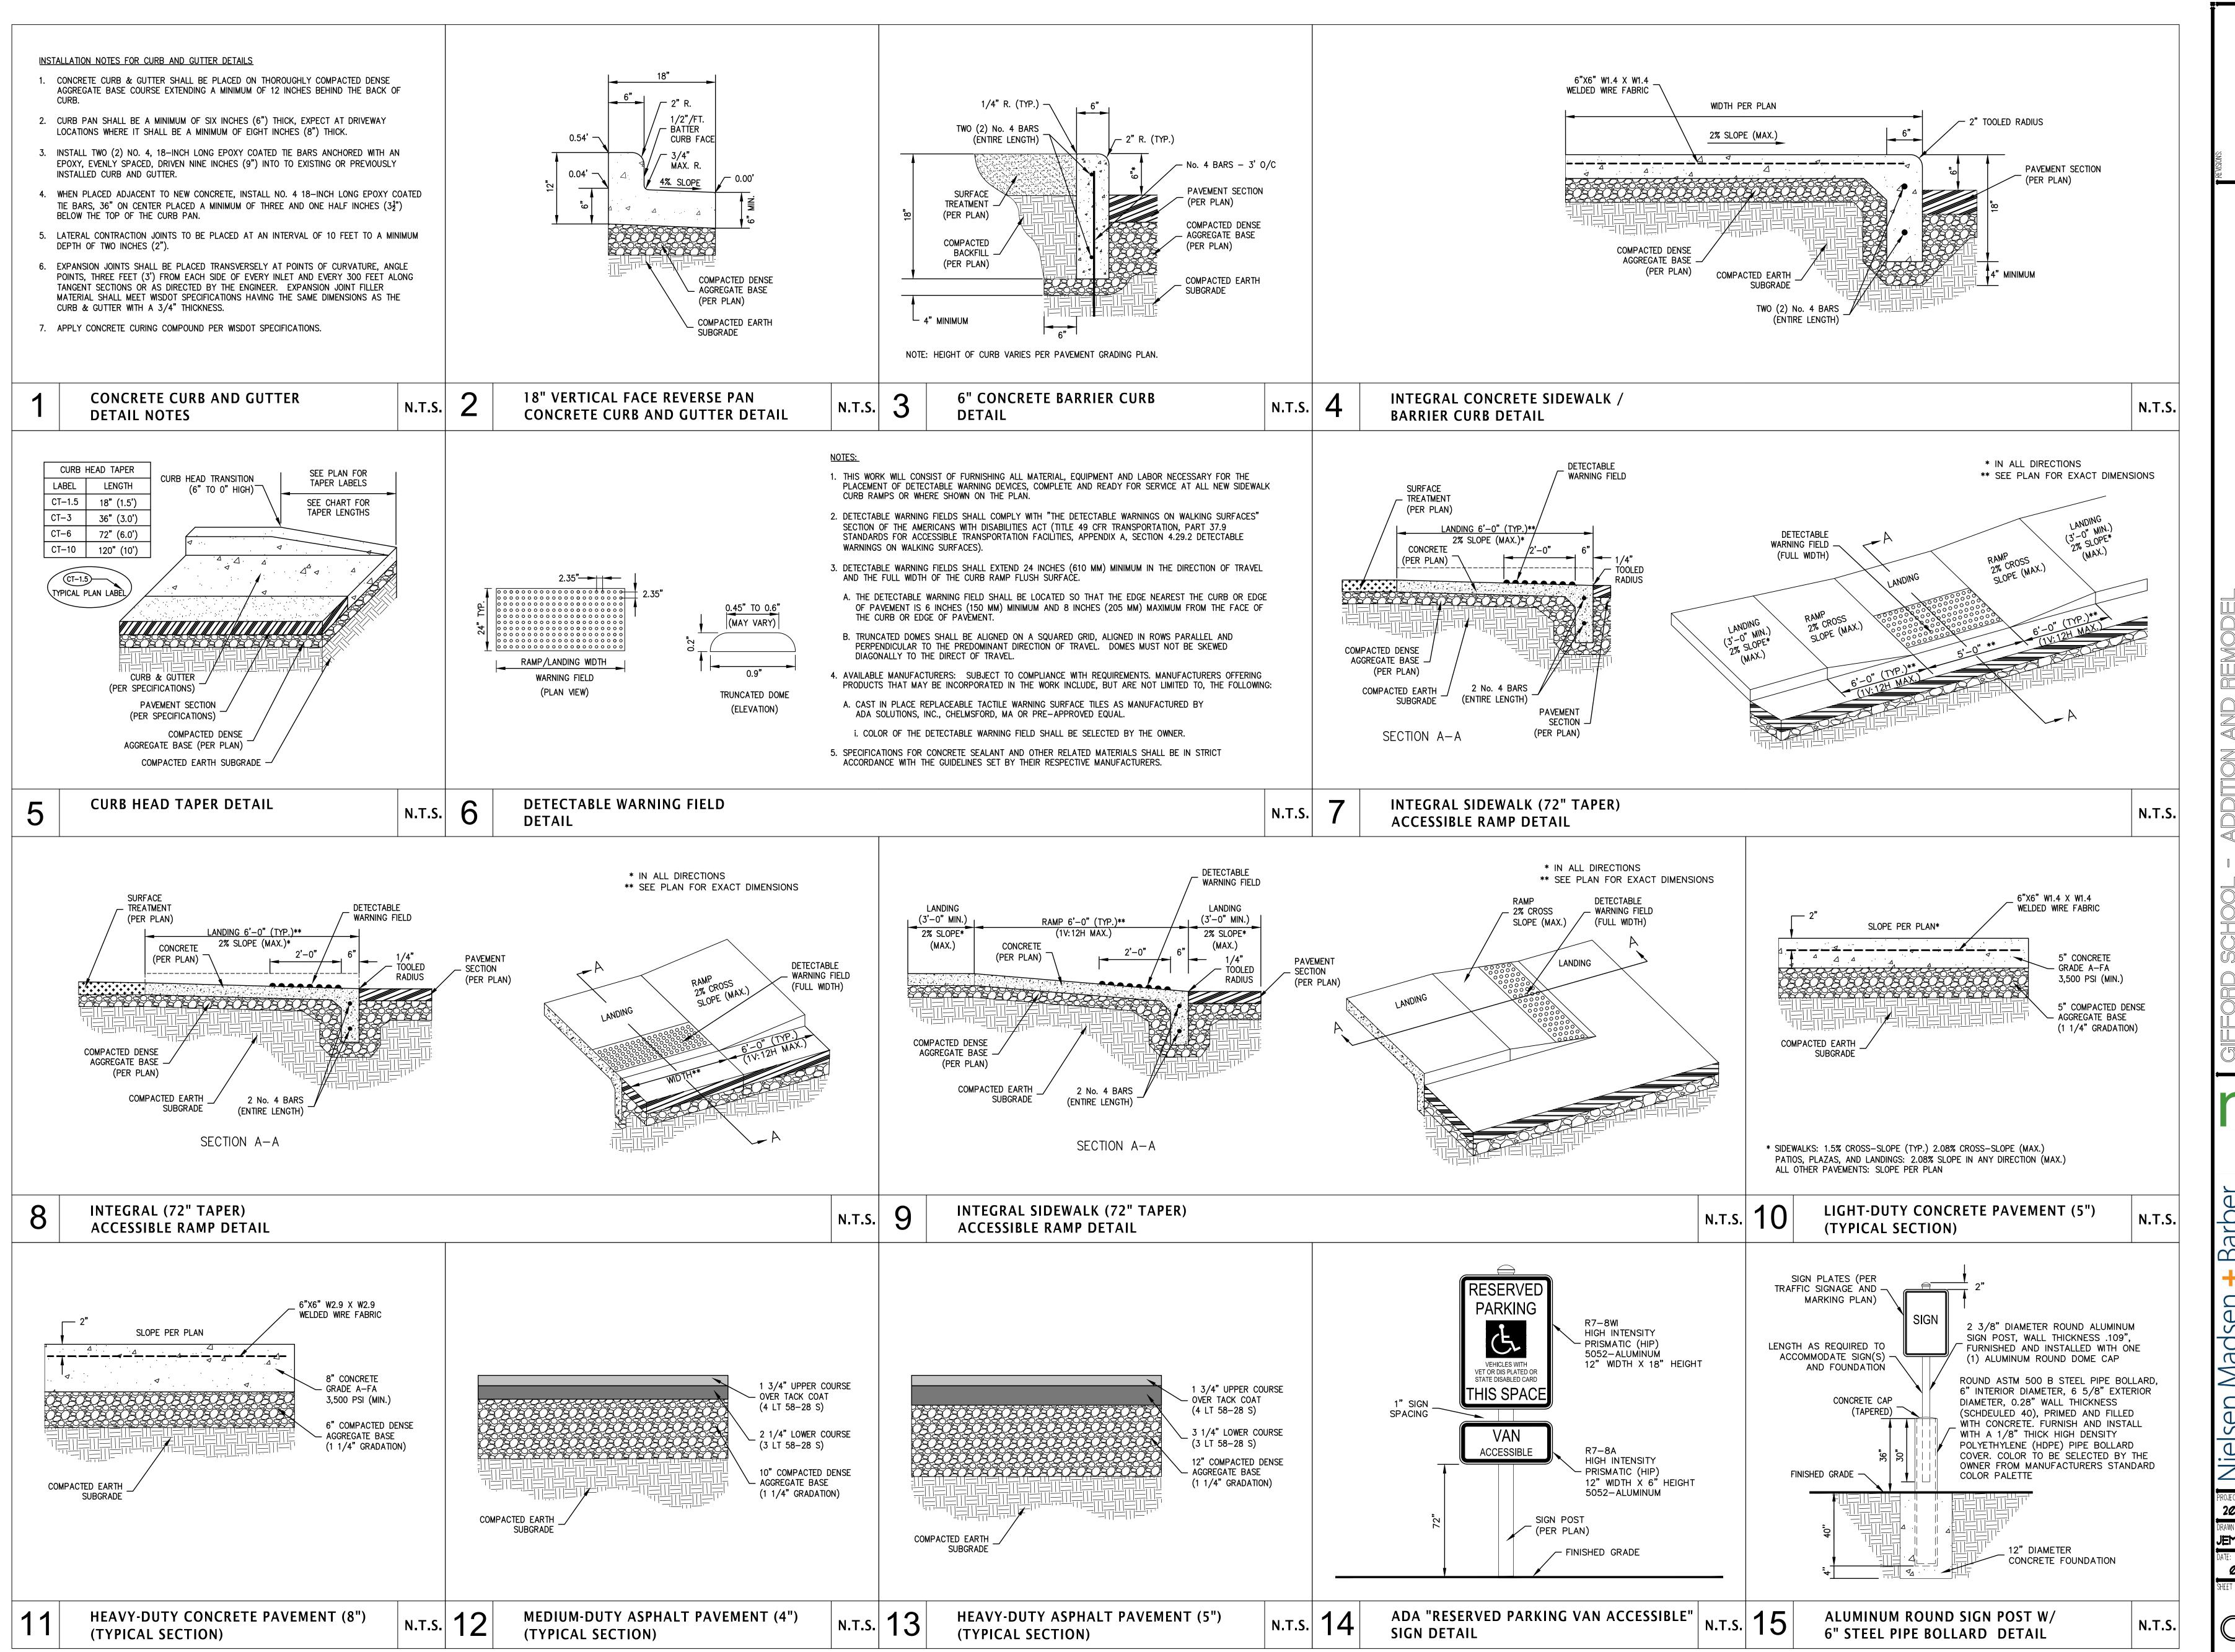

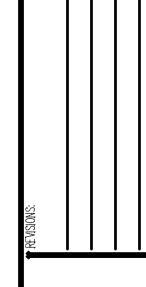

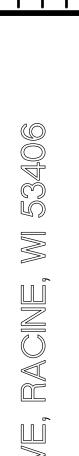

DOL - ADDITION AND REMODEL D SCHOOL DISTRICT, 8332 NORTHWES

SINEERS AND LAND SURVEYORS

DRAWN BY: CHECKED B


DRAWN BY: CHECKED B


DATE:

01.09.2025

SHEET NO.:

C107

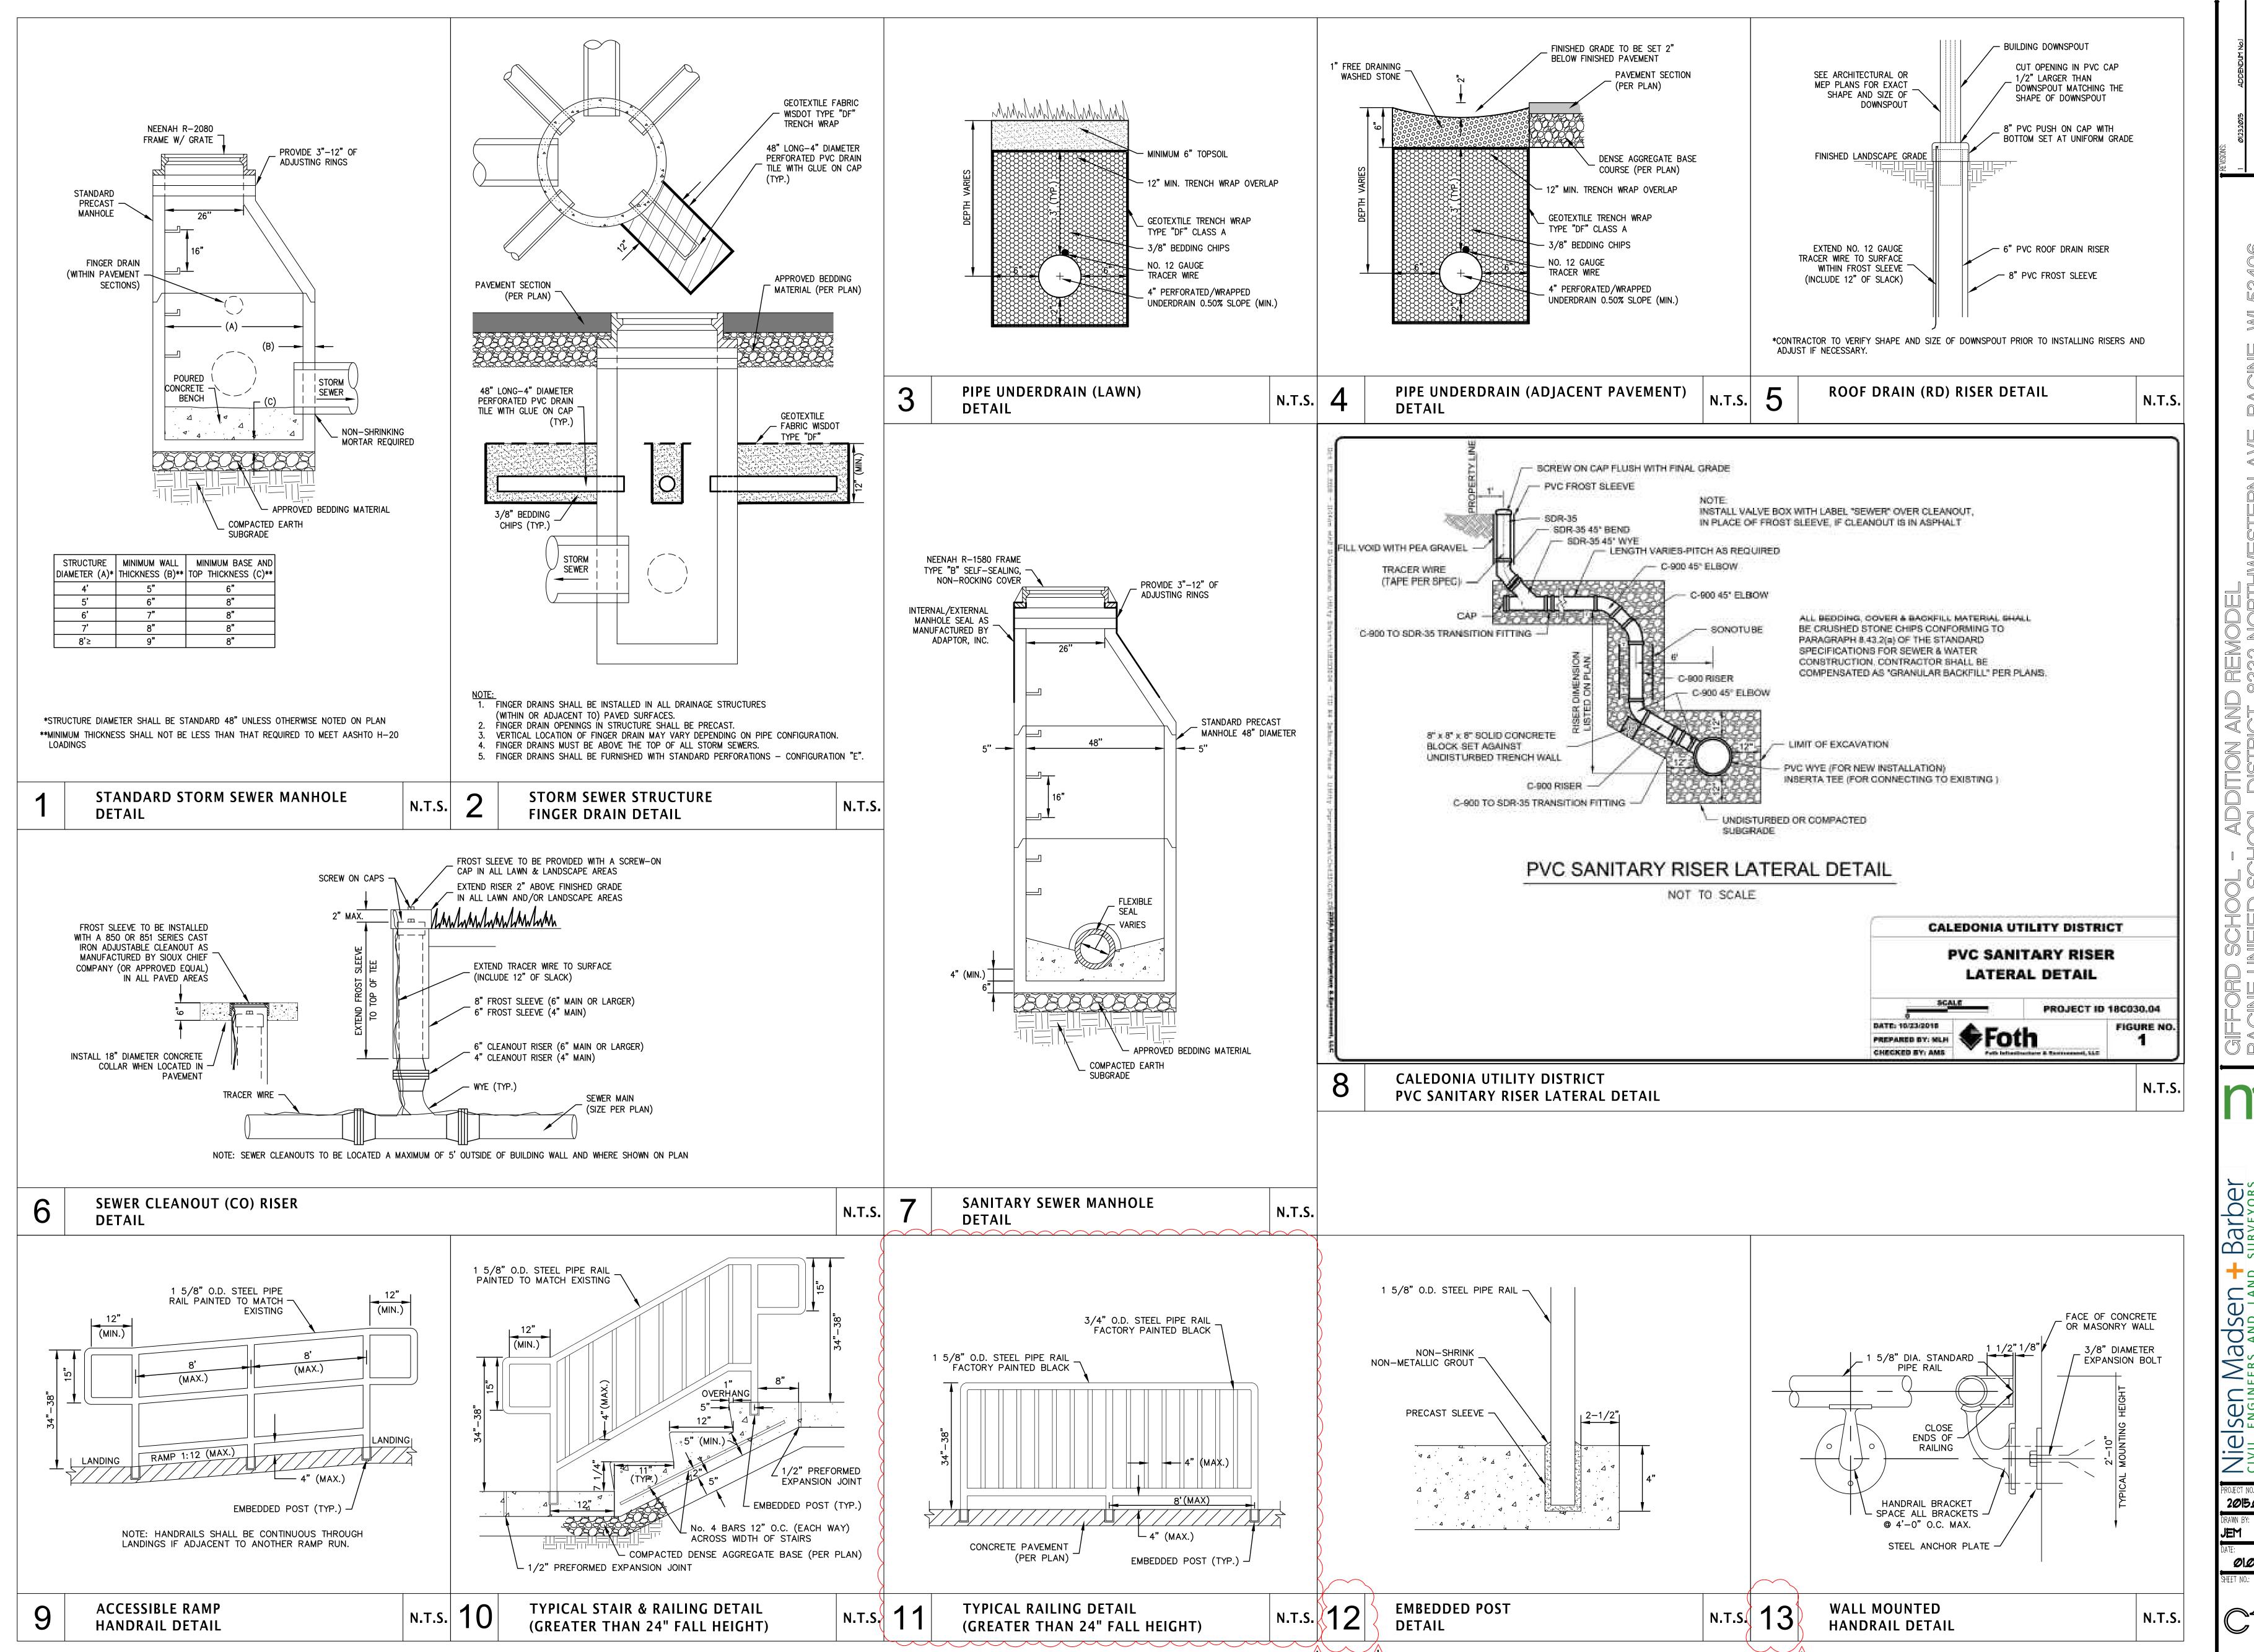


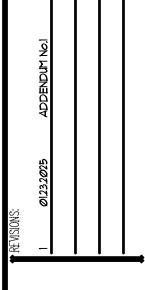

Barber Madsen -Niels CIVIL EI 1458 Ho Tele: (26

2015.0026.10 01.09.2025

C108

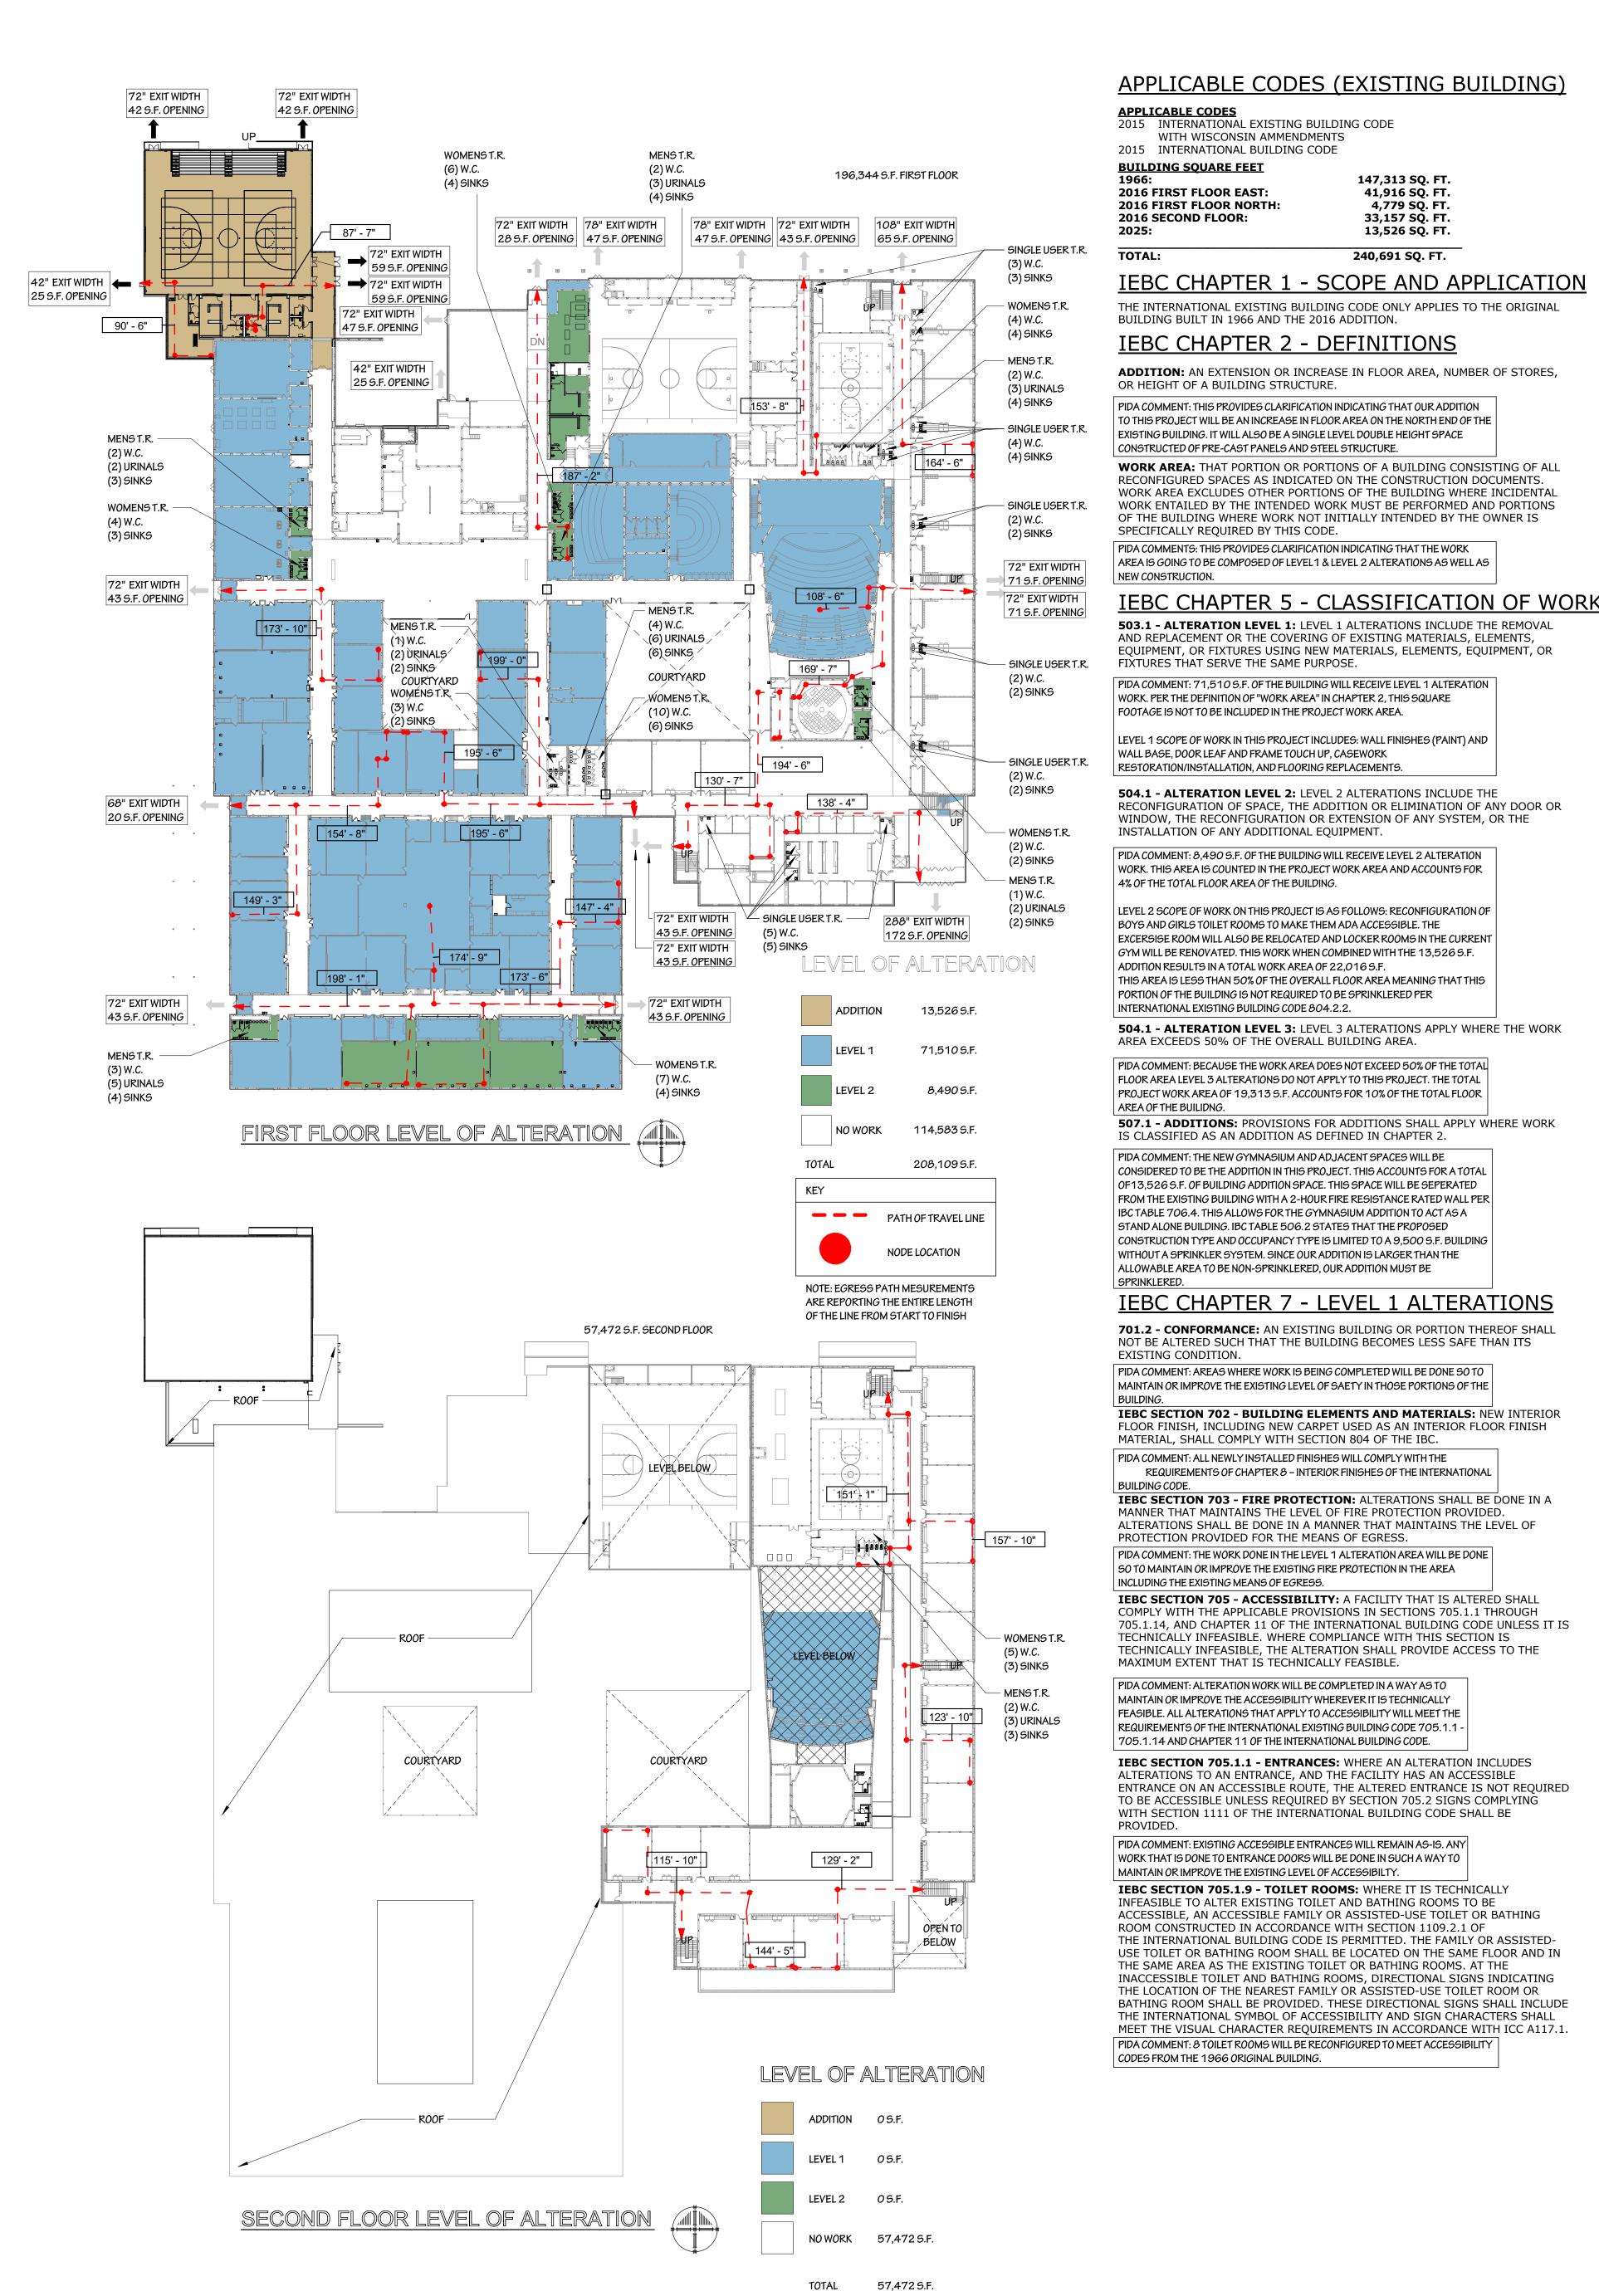

IEBC CHAPTER 8 - LEVEL 2 ALTERATIONS APPLICABLE CODES (EXISTING BUILDING) IEBC SECTION 801.2 - LEVEL 1 COMPLIANCE: IN ADDITION TO THE REQUIREMENTS OF THIS CHAPTER, ALL WORK SHALL COMPLY WITH THE 2015 INTERNATIONAL EXISTING BUILDING CODE REQUIREMENTS OF CHAPTER 7. WITH WISCONSIN AMMENDMENTS

147,313 SQ. FT.

41,916 SQ. FT.

4,779 SQ. FT.

33,157 SQ. FT.

13,526 SQ. FT.

240,691 SQ. FT.

PIDA COMMENT: ALL LEVEL 2 ALTERATION SCOPE OF WORK IS DESIGNED TO COMPLY WITH THE REQUIREMENTS OF CHAPTER 7.

A SPRINKLERED BUILDING.

IEBC SECTION 801.3 - COMPLIANCE: ALL NEW CONSTRUCTION ELEMENTS, COMPONENTS, SYSTEMS, AND SPACES SHALL COMPLY WITH THE REQUIREMENTS OF THE INTERNATIONAL BUILDING CODE. PIDA COMMENT: ALL WORK IN THIS PROJECT WILL BE CONSTRUCTED AS IT IS REQUIRED TO MEET THE REQUIREMENTS OF THE INTERNATIONAL BUILDING CODE.

IEBC SECTION 803.4.1 - SUPPLEMENTAL INTERIOR FINISH REQUIREMENTS: WHERE THE WORK AREA OF ANY FLOOR EXCEEDS 50 PERCENT OF THE FLOOR AREA, SECTION 803.4 SHALL ALSO APPLY TO THE INTERIOR FINISH IN EXIT AND CORRIDORS SERVING THE WORK AREA THROUGHOUT THE FLOOR. PIDA COMMENT: THIS SECTION PROVIDES LANGUAGE THAT EXCLUDES THE

MAJORITY OF THE CORRIDOR FROM BEING FIRE RATED. THE EXISTING BUILDING IS

804.2.2 - GROUPS A, B, E, F-1, H, I, M, R-1, R-2, R-4, S-1 AND S-2: IN BUILDINGS WITH OCCUPANCIES IN GROUPS A, B, E, F-1, H, I, M, R-1, R-2, R-4, S-1, AND S-2, WORK AREAS THAT HAVE EXITS OR CORRIDORS SHARED BY MORE THAN ONE TENANT OR THAT HAVE EXITS OR CORRIDORS SERVING AN OCCUPANT LOAD GREATER THAN 30 SHALL BE PROVIDED WITH AUTOMATIC SPRINKLER

PROTECTION WHERE ALL OF THE FOLLOWING CONDITIONS OCCUR: THE WORK ARE IS REQUIRED TO BE PROVIDED WITH AUTOMATIC SPRINKLER PROTECTION IN ACCORDANCE WITH THE INTERNATIONAL

BUILDING CODE AS APPLICABLE TO NEW CONSTRUCTION; AND

THE WORK AREA EXCEEDS 50 PERCENT OF THE FLOOR AREA. PIDA COMMENTS: DUE TO LEVEL 2 WORK AREA BEING LESS THAN 50% OF THE

FLOOR AREA (ITEM 2) THE AREA OF WORK IN THE EXISTING BUILDING IS AN

EXISTING FULLY SPRINKLERED BUILDING. 804.4 - FIRE ALARM AND DETECTION: AN APPROVED FIRE ALARM SYSTEM SHALL BE INSTALLED IN ACCORDANCE WITH SECTIONS 804.4.1 THROUGH 804.4.3. WHERE AUTOMATIC SPRINKLER PROTECTION IS PROVIDED IN ACCORDANCE WITH SECTION 804.2 AND IS CONNECTED TO THE BUILDING FIRE ALARM SYSTEM, AUTOMATIC HEAT DETECTION SHALL NOT BE REQUIRED.

AN APPROVED AUTOMATIC FIRE DETECTION SYSTEM SHALL BE INSTALLED IN ACCORDANCE WITH THE PROVISIONS OF THIS CODE AND NFPA 72. DEVICES. COMBINATIONS OF DEVICES, APPLIANCES, AND EQUIPMENT SHALL NOT BE APPROVED. THE AUTOMATIC FIRE DETECTORS SHALL BE SMOKE DETECTORS, EXCEPT THAT AN APPROVED ALTERNATIVE TYPE OF DETECTOR SHALL BE INSTALLED IN SPACES SUCH AS BOILER ROOMS, WHERE PRODUCTS OF COMBUSTION ARE PRESENT DURING NORMAL OPERATION IN SUFFICIENT QUANTITY TO ACTUATE A SMOKE DETECTOR.

PIDA COMMENTS: THE FIRE ALARM AND SMOKE DETECTION SYSTEM SHALL BE DESIGNED TO MEET THE REQUIREMENTS FO THE INTERNATIONAL EXISTING BUILDING CODE SECTION 804.4.

805.4.2 - DOOR SWING: IN THE WORK AREA AND IN THE EGRESS PATH FROM ANY WORK AREA TO THE EXIT DISCHARGE, ALL EGRESS DOORS SERVING AN OCCUPANT LOAD GREATER THAN 50 SHALL SWING IN THE DIRECTION OF EXIT

PIDA COMMENTS: ALL DOORS IN EXIT CORRIDORS CURRENTLY COMPLY WITH THIS REQUIREMENT.

805.7.1 - MEANS OF EGRESS - ARTIFICIAL LIGHTING REQUIRED: MEANS OF EGRESS IN ALL WORK AREAS SHALL BE PROVIDED WITH ARTIFICIAL LIGHTING IN EGRESS IN ALL WORK AREAS SHALL BE PROVIDED WITH ARTIFICIAL LIGHTING IN ACCORDANCE WITH THE REQUIREMENTS OF THE INTERNATIONAL BUILDING CODE. PIDA COMMENTS: ALL OF THE MEANS OF EGRESS WILL BE PROVIDED WITH CODE COMPLIANT MEANS OF EGRESS LIGHTING. ALL EXISTING EMERGENCY LIGHTING WILL BE POWERED BY THE GENERATOR.

805.8.1 - EXIT SIGNS - WORK AREAS: MEANS OF EGRESS IN ALL WORK AREAS SHALL BE PROVIDED WITH EXIT SIGNS IN ACCORDANCE WITH THE REQUIREMENTS OF THE INTERNATIONAL BUILDING CODE.

PIDA COMMENTS: ALL MEANS OF EGRESS THROUGHOUT THE BUILDING WILL BE SUPPLIED WITH CODE COMPLIANT EXIT SIGNS 810.1 - MINIMUM FIXTURES: WHERE THE OCCUPANT LOAD OF THE STORY IS INCREASED BY MORE THAN 20%, PLUMBING FIXTURES FOR THE STORY SHALL BE PROVIDED IN QUANTITIES SPECIFIED IN THE INTERNATIONAL PLUMBING CODE BASED ON THE INCREASED OCCUPANT LOAD.

IEBC CHAPTER 11 - ADDITIONS

1101.1 SCOPE: AN ADDITION TO A BUILDING OR STRUCTURE SHALL COMPLY WITH THE INTERNATIONAL BUILDING CODES AS ADOPTED FOR NEW CONSTRUCTION WITHOUT REQUIRING THE EXISTING BUILDING OR STRUCTURE TO COMPLY WITH ANY REQUIREMENTS OF THOSE CODES OR OF THESE PROVISIONS, EXCEPT AS REQUIRED BY THIS CHAPTER. WHERE AN ADDITION IMPACTS THE EXISTING BUILDING OR STRUCTURE, THAT PORTION SHALL COMLY WITH THIS

PIDA COMMENTS: ALL COMPONENTS OF THE NEW GYMNASIUM ADDITION WILL COMPLY WITH ALL ASSOCIATED CODES PER THE INTERNATIONAL BUILDING CODE FOR NEW CONSTRUCTION.

APPLICABLE CODES (BUILDING ADDITION)

VILLAGE OF CALEDONIA, APPLICABLE CODES 2015 INTERNATIONAL BUILDING CODE

2015 INTERNATIONAL MECHANICAL CODE

2015 INTERNATIONAL FIRE CODE 2015 INTERNATIONAL EXISTING BUILDING CODE

IBC CHAPTER 3 - USE AND OCCUPANCY THE GYMNASIUM ADDITION WILL BE CLASSIFIED AS A SPRINKLERED, FULLY FIRE ALAMED, SEPERATED (A3) ASSEMBLY OCCUPANCY CLASSIFICATION AND AN ACCESSORY TO THE PRIMARY (E) OCCUPANCY WHICH IS THE EXISTING SCHOOL

IBC CHAPTER 5 - BUILDING HEIGHTS

NOTE: THIS GYMNASIUM IS A SINGLE STORY SPACE CONSTRUCTED OF LOAD BEARING PRE-CAST CONCRETE PANELS, UNPROTECTED STEEL COLUMNS, JOIST BEAMS, AND METAL ROOF DECKING. THEREFORE, WITH THE USE OF THESE NON-COMBUSTIBLE MATERIALS, THIS BUILDINGS CONSTRUCTION CLASSIFICATION IS A TYPE II-B. TABLE 504.3 "ALLOWABLE BUILDING HEIGHT IN FEET ABOVE GRADE PLANE"

(A-3) BUILDING OCCUPANCY, WITH TYPE II-B CONSTRUCTION, AND SPRINKLERED

MAXIMUM BUILDING HEIGHT OF: 75'-0" ABOVE GRADE PLANE ALLOWABLE NUMBER OF STORIES ABOVE GRADE PLANE: 3 ALLOWABLE AREA FACTOR: 38,000 S.F. FOR A SINGLE STORY SPRINKLERED

ACTUAL BUILDING: BUILDING HEIGHT:32'-0" NUMBER OF STORIES: 1 STORY AREA:13,526 S.F.

506.1.1 UNLIMITED AREA BUILDINGS: UNLIMITED AREA BUILDINGS SHALL BE DESIGNED IN COORDANCE WITH SECTION 507. PIDA COMMENT: UNLIMITED AREA IS SATISFIED BECAUSE OUR SITE HAS FULL ACCESS AROUND THE ENTIRE PERIMITER OF THE BUILDING AND

ADDITION FOR EMERGENCY VEHICLE ACCESS. **507.1 GENERAL:** THE AREA OF BUILDINGS OF THE OCCUPANCIES AND CONFIGURATIONS SPECIFIED IN SECTIONS 507.1 THROUGH 507.12 SHALL NOT BE LIMITED. BASEMENTS NOT MORE THAN ONE STORY BELOW GRAE PLANE SHALL BE

507.2.1 REDUCED OPEN SPACE: THE PUBLIC WAYS OR YARDS OF 60 FEET IN WIDTH REQUIRED IN SECTIONS 507.3, 507.4, 507.5. 507.6 AND 507.12 SHALL BE PERMITTED TO BE REDUCED TO NOT LESS THAN 40 FEET IN WIDTH PROVIDED ALL OF THE FOLLOWING REQUIREMENTS ARE MET:

- THE REDUCED WIDTH SHALL NOT BE ALLOWED FOR MORE THAN 75 PERCENT OF THE PERIMETER OF THE BUILDING
- THE EXTERIOR WALLS FACING THE REDUCED WIDTH SHALL HAVE A FIRE-RESISTANCE OF NOT LESS THAN 3 HOURS
- OPENINGS IN THE EXTERIOR WALLS FACING THE REDUCED WIDTH SHALL HAVE OPENING PROTECTIVES WITHA FIRE PROTECTION RATING OF NOT

IBC CHAPTER 6 - TYPES OF

HOURS / NONCOMBUSTIBLE

CONSTRUCTION 602.2 TYPES I AND II: TYPES I AND II CONSTRUCTION ARE THOSE TYPES OF CONSTRUCTION IN WHICH THE BUILDING ELEMENTS LISTED IN TABLE 601 ARE OF NONCOMBUSTIBLE MATERIALS, EXCEP AS PERMITTED IN SECTION 603 AND ELSEWHERE IN THIS CODE.

602.2 TYPES I AND II: TYPES I AND II CONSTRUCTION ARE THOSE TYPES OF CONSTRUCTION IN WHICH THE BUILDING ELEMENTS LISTED IN TABLE 601 ARE OF NONCOMBUSTIBLE MATERIALS, EXCEP AS PERMITTED IN SECTION 603 AND ELSEWHERE IN THIS CODE.

BUILDING ELEMENTS STRUCTURAL FRAME INCLUDING COLUMNS, GIRDERS, TRUSSES HOURS / NONCOMBUSTIBLE BEARING WALLS EXTERIOR (>30') HOURS / NONCOMBUSTIBLE HOURS / NONCOMBUSTIBLE NONBEARING WALLS EXTERIOR (>30') HOURS / NONCOMBUSTIBLE HOURS / NONCOMBUSTIBLE FLOOR CONSTRUCTION INCLUDING SUPPORTING BEAMS AND JOIST HOURS / NONCOMBUSTIBLE ROOF CONSTRUCTION INCLUDING SUPPORTING BEAMS AND JOIST

THE BUILDING ADDITION IS CLASSIFIED AS A TYPE II B (NONCOMBUSTIBLE) CONSTRUCTION

IBC CHAPTER 8 - INTERIOR FINISHES

803.1 GENERAL: INTERIOR WALL AND CEILING FINISH MATERIALS SHALL BE CLASSIFIED FOR FIRE PERFORMANCE AND SMOKE DEVELOPMENT IN ACCORDANC WITH SECTION 803.1.1 OR 803.1.2, EXCEPT AS SHOWN IN SECTIONS 803.2 THROUGH 803.13. MATERIALS TESTED IN ACCORDANCE WITH SECTION 803.1.2 SHALL NOT BE REQUIRED TO BE TESTED IN ACCORDANCE WITH SECTION 803.1.1 803.1.1 INTERIOR WALL AND CEILING FINISH MATERIALS: INTERIOR WALL AND CEILING FINISH MATERIALS SHALL BE CLASSIFIED IN ACCORDANCE WITH ASTM E84 OR UL 723. SUCH INTERIOR FINISH MATERIALS SHALL BE GROUPED IN THE FOLLOWING CLASSES IN ACCORDANCE WITH THEIR FLAME SPREAD AND SMOKE-DEVELOPED INDEXES.

CLASS A: = FLAME SPREAD INDEX 0-25; SMOKEDEVELOPED INDEX 0-450. CLASS B: = FLAME SPREAD INDEX 26-5; SMOKEDEVELOPED INDEX 0-450. CLASS C: = FLAME SPREAD INDEX 76-200; SMOKEDEVELOPED INDEX 0-450.

EXCEPTION: MATERIALS TESTED IN ACCORDANCE WITH SECTION 803.1.2. 803.11 INTERIOR FINISH REQUIREMENTS BASED ON GROUP: INTERIOR WALL AND CEILING FINISH SHALL HAVE A FLAME SPREAD INDEX NOT GREATER THAN SPECIFIED IN TABLE 803.11 FOR THE GROUP AND LOCATION DESIGNATED INTERIOR WALL AND CEILING FINISH MATERIALS TESTED IN ACCORDANCE WITH NFPA 286 AND MEETING THE ACCEPTANCE CRITERIA OF SECTION 803.1.2.1, SHALL BE PERMITTED TO BE USED WHERE A CLASS A CLASSIFICATION IN ACCORDANCE WITH ASTM E84 OR UL 723 IS REQUIRED. ADDTION OCCUPANCY IS FOR AN (A3)

INTERIOR EXIT STAIRWAYS, RAMPS, & EXIT PASSAGEWAYS - B CORRIDORS AND ENCLOSURE FOR EXIT ACCESS STAIRWAYS AND RAMPS - B ROOMS OR ENCLOSED SPACES - C

803.12 STABILITY: INTERIOR FINISH MATERIALS REGULATED BY THIS CHAPTER SHALL BE APPLIED OR OTHERWISE FASTENED IN SUCH A MANNER THAT SUCH MATERIALS WILL NOT READILY BECOME DETACHED WHERE SUBJECTED TO ROOM TEMPERATURES OF 200 F (93 C) FOR NOT LESS THAN 30 MINUTES. 803.13.4 MATERIALS: AN INTERIOR WALL OR CEILING FINISH MATERIAL THAT IS NOT MORE THAN 1/4" THICK SHALL BE APPLIED DIRECTLY TO THE WALL, CEILING, OR STRUCTURAL ELEMENT WITHOUT THE USE OF FURRING STRIPS AND SHALL NOT BE SUSPENDED AWAY FROM THE BUILDING ELEMENT TO WHICH THAT FINISH

IBC CHAPTER 9 - INTERIOR FINISHES

901.2 FIRE PROTECTION SYSTEMS: FIRE PROTECTION SYSTEMS SHALL BE INSTALLED, REPAIRED, OPERATED AND MAINTAINED IN ACCORDANCE WITH THIS CODE AND THE INTERNATIONAL FIRE CODE. ANY FIRE SYSTEM FOR WHICH AN EXCEPTION OR REDUCTION TO THE PROVISIONS OF THIS CODE SHALL BE PERMITTED TO BE INSTALLED FOR PARTIAL OR COMPLETE PROTECTING PROVIDED THAT SUCH SYSTEM MEETS THE REQUIREMENTS OF THIS CODE. 907.2.12.1 ALARM: ACTIVATION OF ANY SINGLE SMOKE DETECTOR, THE AUTOMATIC SPRINKLER SYSTEM OR ANY OTHER AUTOMATIC FIRE DETECTION DIENTIALE SHALL IMMEDIATELY ACTIVATE AN AUDIBLE AND VISIBLE ALARM AT THE BUILDING AT A CONSTANTLY ATTENDED LOCATION FROM WHICH EMERGENCY ACTION CAN BE INITIATED, INCLUDING THE CAPABILITY OF MANUAL INITIATION REQUIREMENTS IN SECTION 907.2.12.2.

IBC CHAPTER 10 - MEANS OF EGRESS

NAME	AREA	OCCUPANTS
ACCESSORY	2428 SF	8
ASSEMBLY FIXED	6361 SF	718
BUSINESS	116295F	117
CAFETERIA	81765F	546
CLASSROOM	65123 SF	3257
CONCENTRATED	12530 SF	251
DAYCARE	1047 SF	30
KITCHEN	4082 SF	21
LOCKER ROOM	2400 SF	120
READING ROOM	194 SF	4
STACK AREA	4561 SF	46
STAGE	2831 SF	189
STORAGE	3959 SF	14
VOCATIONAL	20070 SF	402

145,392S.F. 5,723 OCCUPANTS

EDUCATIONAL CLASSROOMS = 20 NET S.F. EDUCATIONAL VOCATIONAL AREAS = 50 NET S.F. OFFICE AREAS = 100 GROSS S.F.

EDUCATIONAL CLASSROOMS: 65,124/20 NET S.F. = 3,257 OCCUPANTS EDUCATIONAL VOCATIONAL AREAS: 20,070/50 NET S.F. = 402 OCCUPANTS OFFICE AREAS: 11,629/100 GROSS S.F. = 117 OCCUPANTS

TABLE 1005.1 "EGRESS WIDTH PER OCCUPANT SERVED": WITH SPRINKLER SYSTEM = 0.2 INCHES PER OCCUPANT CALCULATION: 5,723 OCCUPANTS (0.2 / OCCUPANT) = 1,145" OF EGRESS WIDTH

TABLE 1006.2.1 "COMMON PATH OF TRAVEL": COMMON PATH OF TRAVEL SHALL NOT EXCEED 75 FEET. ALL SPACES IN THE BUILDING COMPLY.

1017.2 "EXIT ACCESS TRAVEL DISTANCE": EXITS SHALL BE LOCATED SO THAT THE MAXIMUM LENGTH OF EXIT ACCESS TRAVEL, MEASURED FROM THE MOST REMOTE POINT TO THE ENTRANCE TO AN EXIT ALONG THE NATURAL AND UNOBSTRUCTED PATH OF EGRESS TRAVEL, SHALL NOT EXCEED THE DISTANCES GIVEN IN TABLE 1017.2.

TABLE 1017.2 "EXIT ACCESS TRAVEL DISTANCE": (E) = 250 FEET WITH A SPRINKLER SYSTEM. ALL SPACES WITHIN THE BUILDING COMPLY.

IBC CHAPTER 29 - PLUMBING SYSTEMS **TABLE 2902.1 "MINIMUM NUMBER OF PLUMBING FACILITIES CALCULATION":**

EDUCATIONAL OCCUPANCY = 3,758 OCCUPANTS WATER CLOSETS: 38 BOYS / 38 GIRLS REQUIRED

LAVATORIES: 38 BOYS / 38 GIRLS REQUIRED DRINKING FOUNTAINS: 38 REQUIRED

BUSINESS OCCUPANCY = 118 OCCUPANTS WATER CLOSETS: 2 BOYS / 2 GIRLS REQUIRED

SERVICE SINK: 1 REQUIRED

LAVATORIES: 1 BOYS / 1 GIRLS REQUIRED DRINKING FOUNTAINS: 2 REQUIRED SERVICE SINK: 1 REQUIRED

ASSEMBLY OCCUPANCY A-3 = 0 OCCUPANTS

ASSEMBLY OCCUPANCY A-1 = 0 OCCUPANTS

TOTALS REQUIRED VS. PROVIDED

WATER CLOSETS: MEN 48 REQUIRED / WOMEN 55 REQUIRED MEN 37 PROVIDED / WOMEN 33 PROVIDED

LAVATORIES: MEN 55 REQUIRED / WOMEN REQUIRED MEN PROVIDED / WOMEN PROVIDED

DRINKING FOUNTAINS: MEN REQUIRED / WOMEN REQUIRED MEN PROVIDED / WOMEN PROVIDED

SERVICE SINK: MEN REQUIRED / WOMEN REQUIRED MEN PROVIDED / WOMEN PROVIDED

ADDITION YEAR 138,815 S.F. ADDITION YEARS

ROJECT NO. 723.24.035 DRAWN BY: CHECKED B

13,526 S.F.

2024

DEMOLITION SITE PLAN LEGEND EXISTING WALL TO REMAIN STUD WALL DEMOLITION EXISTING DOOR TO REMAIN DOOR TO BE REMOVED EXISTING WINDOW TO REMAIN WINDOW TO BE REMOVED MASONRY WALL DEMOLITION ASPHALT TO BE SAW CUT AND REMOVED CONCRETE AND ALL ASSOCIATED COMPONENTS TO BE REMOVED EXISTING BUILDING TO REMAIN PROPERTY LINE ----

DEMO KEY NOTES

SITE / BUILDING

REMOVE A PORTION OF CONCRETE SIDEWALK AND BASE COMPLETELY. PREP AREA TO RECIEVE NEW TOP SOIL AND SEED.

REMOVE A PORTION OF CONCRETE SIDEWALK AND CURB. PREP AREA AS NECESSARY TO POUR NEW SIDEWALK AND CURB.

5AW CUT AND REMOVE A PORTION OF ASPHALT DRIVE TO ACCOMODATE THE NEW UTILITY AND CONCRETE FLAT WORK.

REMOVE AND SALVAGE LIGHT POLE FOR REINSTALLATION, SEE ELECTRICAL DRAWINGS FOR DETAILS.

REMOVE A PORTION OF THE CONCRETE DRIVE AS NECESSARY TO
ACCOMODATE THE NEW UTILITIES AND DELIVERY DOCK
REPLACEMENT.

REMOVE FENCING, GATES, POST, FOUNDATION AND ALL ASSOCIATED COMPONENTS.

16 REMOVE AND GRUB TREE.

17 REMOVE, SALVAGE, AND REINSTALL BASKETBALL HOOP.

REMOVE EXISTING GRASS AND PREPARE AREA TO RECIEVE NEW FINISH. REFER TO CIVIL FOR SCOPE OF WORK.

SAWCUT AND REMOVE A PORTION OF ACPHALT TO ACCOMODATE SANITATION CONNECTION. REFER TO CIVIL FOR SCOPE OF WORK.

TRENCH OUT A PORTION OF GRASS TO ACCOMODATE STORM PIPING. REFER TO CIVIL FOR ENTIRE SCOPE OF WORK.

GENERAL DEMOLITION NOTES

1. DEMOLITION DRAWINGS ARE PROVIDED AS A REFERENCE TO ESTABLISH THE GENERAL SCOPE OF DEMOLITION WORK. CONTRACTOR IS RESPONSIBLE TO COMPLETE ALL DEMOLITION WORK WHERE REQUIRED TO ACCOMMODATE NEW CONSTRUCTION AND PROTECT THE STRUCTURAL INTEGRITY OF EXISTING-TO-REMAIN

2. MAINTAIN THE STRUCTURAL INTEGRITY OF THE EXISTING BUILDING TO REMAIN.
IMMEDIATELY CONTACT THE ARCHITECT IS SCHEDULED DEMOLITION WORK WILL
COMPROMISE STRUCTURAL INTEGRITY OF EXISTING BUILDING PRIOR TO DEMOLITION.

3. VERIFY EXISTING STRUCTURAL SUPPORTS AND LOCATION OF ALL STRUCTURAL SUPPORTING WALLS PRIOR TO DEMOLITION. ALL EXISTING STRUCTURAL SUPPORTS ARE TO REMAIN UNLESS NOTED OTHERWISE ON DEMOLITION PLAN.

4. COORDINATE ALL DEMOLITION WORK OUTLINED ON DEMOLITION PLAN WITH NEW FLOOR PLAN LAYOUT TO ALL FOR PROTECTION OF EXISTING TO REMAIN.

5. GENERAL CONTRACTOR TO COORDINATE WITH OTHER CONTRACTORS FOR ALL DEMOLITION WORK. G.C. SHALL PROVIDE NECESSARY ACCESS FOR OTHER CONTRACTORS TO ALLOW OTHER DEMOLITION WORK AND SHALL REPAIR SUCH DEMOLITION AREAS WITH MATERIALS TO MATCH FINAL FINISHES.

6. CONTRACTOR IS RESPONSIBLE FOR PATCHING WALLS, FLOORS, ETC. AND LEVELING EXISTING SURFACES AS REQUIRED TO MATCH ALL ADJACENT SURFACES WHERE REMOVAL WORK HAS OCCURRED, ESPECIALLY WHERE REMOVED WALLS INTERSECT WALLS TO REMAIN AND EXISTING FLOORS SCHEDULED FOR NEW FINISHES.

7. GENERAL CONTRACTOR IS REQUIRED TO WALK THROUGH THE PROJECT SITE TO BECOME FAMILIAR WITH THE SCOPE AND INTENT OF THE CONSTRUCTION DOCUMENTS.

8. SAWCUT AND REMOVE & PATCH ALL WALLS AND FLOORS AS REQUIRED FOR NEW MECHANICAL, PLUMBING, ELECTRICAL, AND STRUCTURAL WORK AS REQUIRED.

9. CONTRACTORS TO FIELD VERIFY REQUIRED MECHANICAL, PLUMBING, AND ELECTRICAL DEMOLITION.

10. RECONFIGURE EXISTING MECHANICAL, ELECTRICAL, AND PLUMBING SYSTEMS PER THE NEW FLOOR PLAN AND ALL APPLICABLE CODES - TERMINATE AND REMOVE ALL UNUSED CONNECTIONS PER CODE.

11. ALL DEMOLITION DIMENSIONS ARE TO FINISHED OPENINGS & TO BE COORDINATED WITH NEW CONSTRUCTION.

REVISION TO THE PROPERTY OF TH

SIFFORD SCHOOL ADDITION AND RENOV 1332 Northwestern Ave, Racine, Wisconsin

Partnersin Des





PROJECT NO.:
723.24.035

DRAWN BY: CHECKED E
MGP JE


DATE: 01.09.2025

A1.1

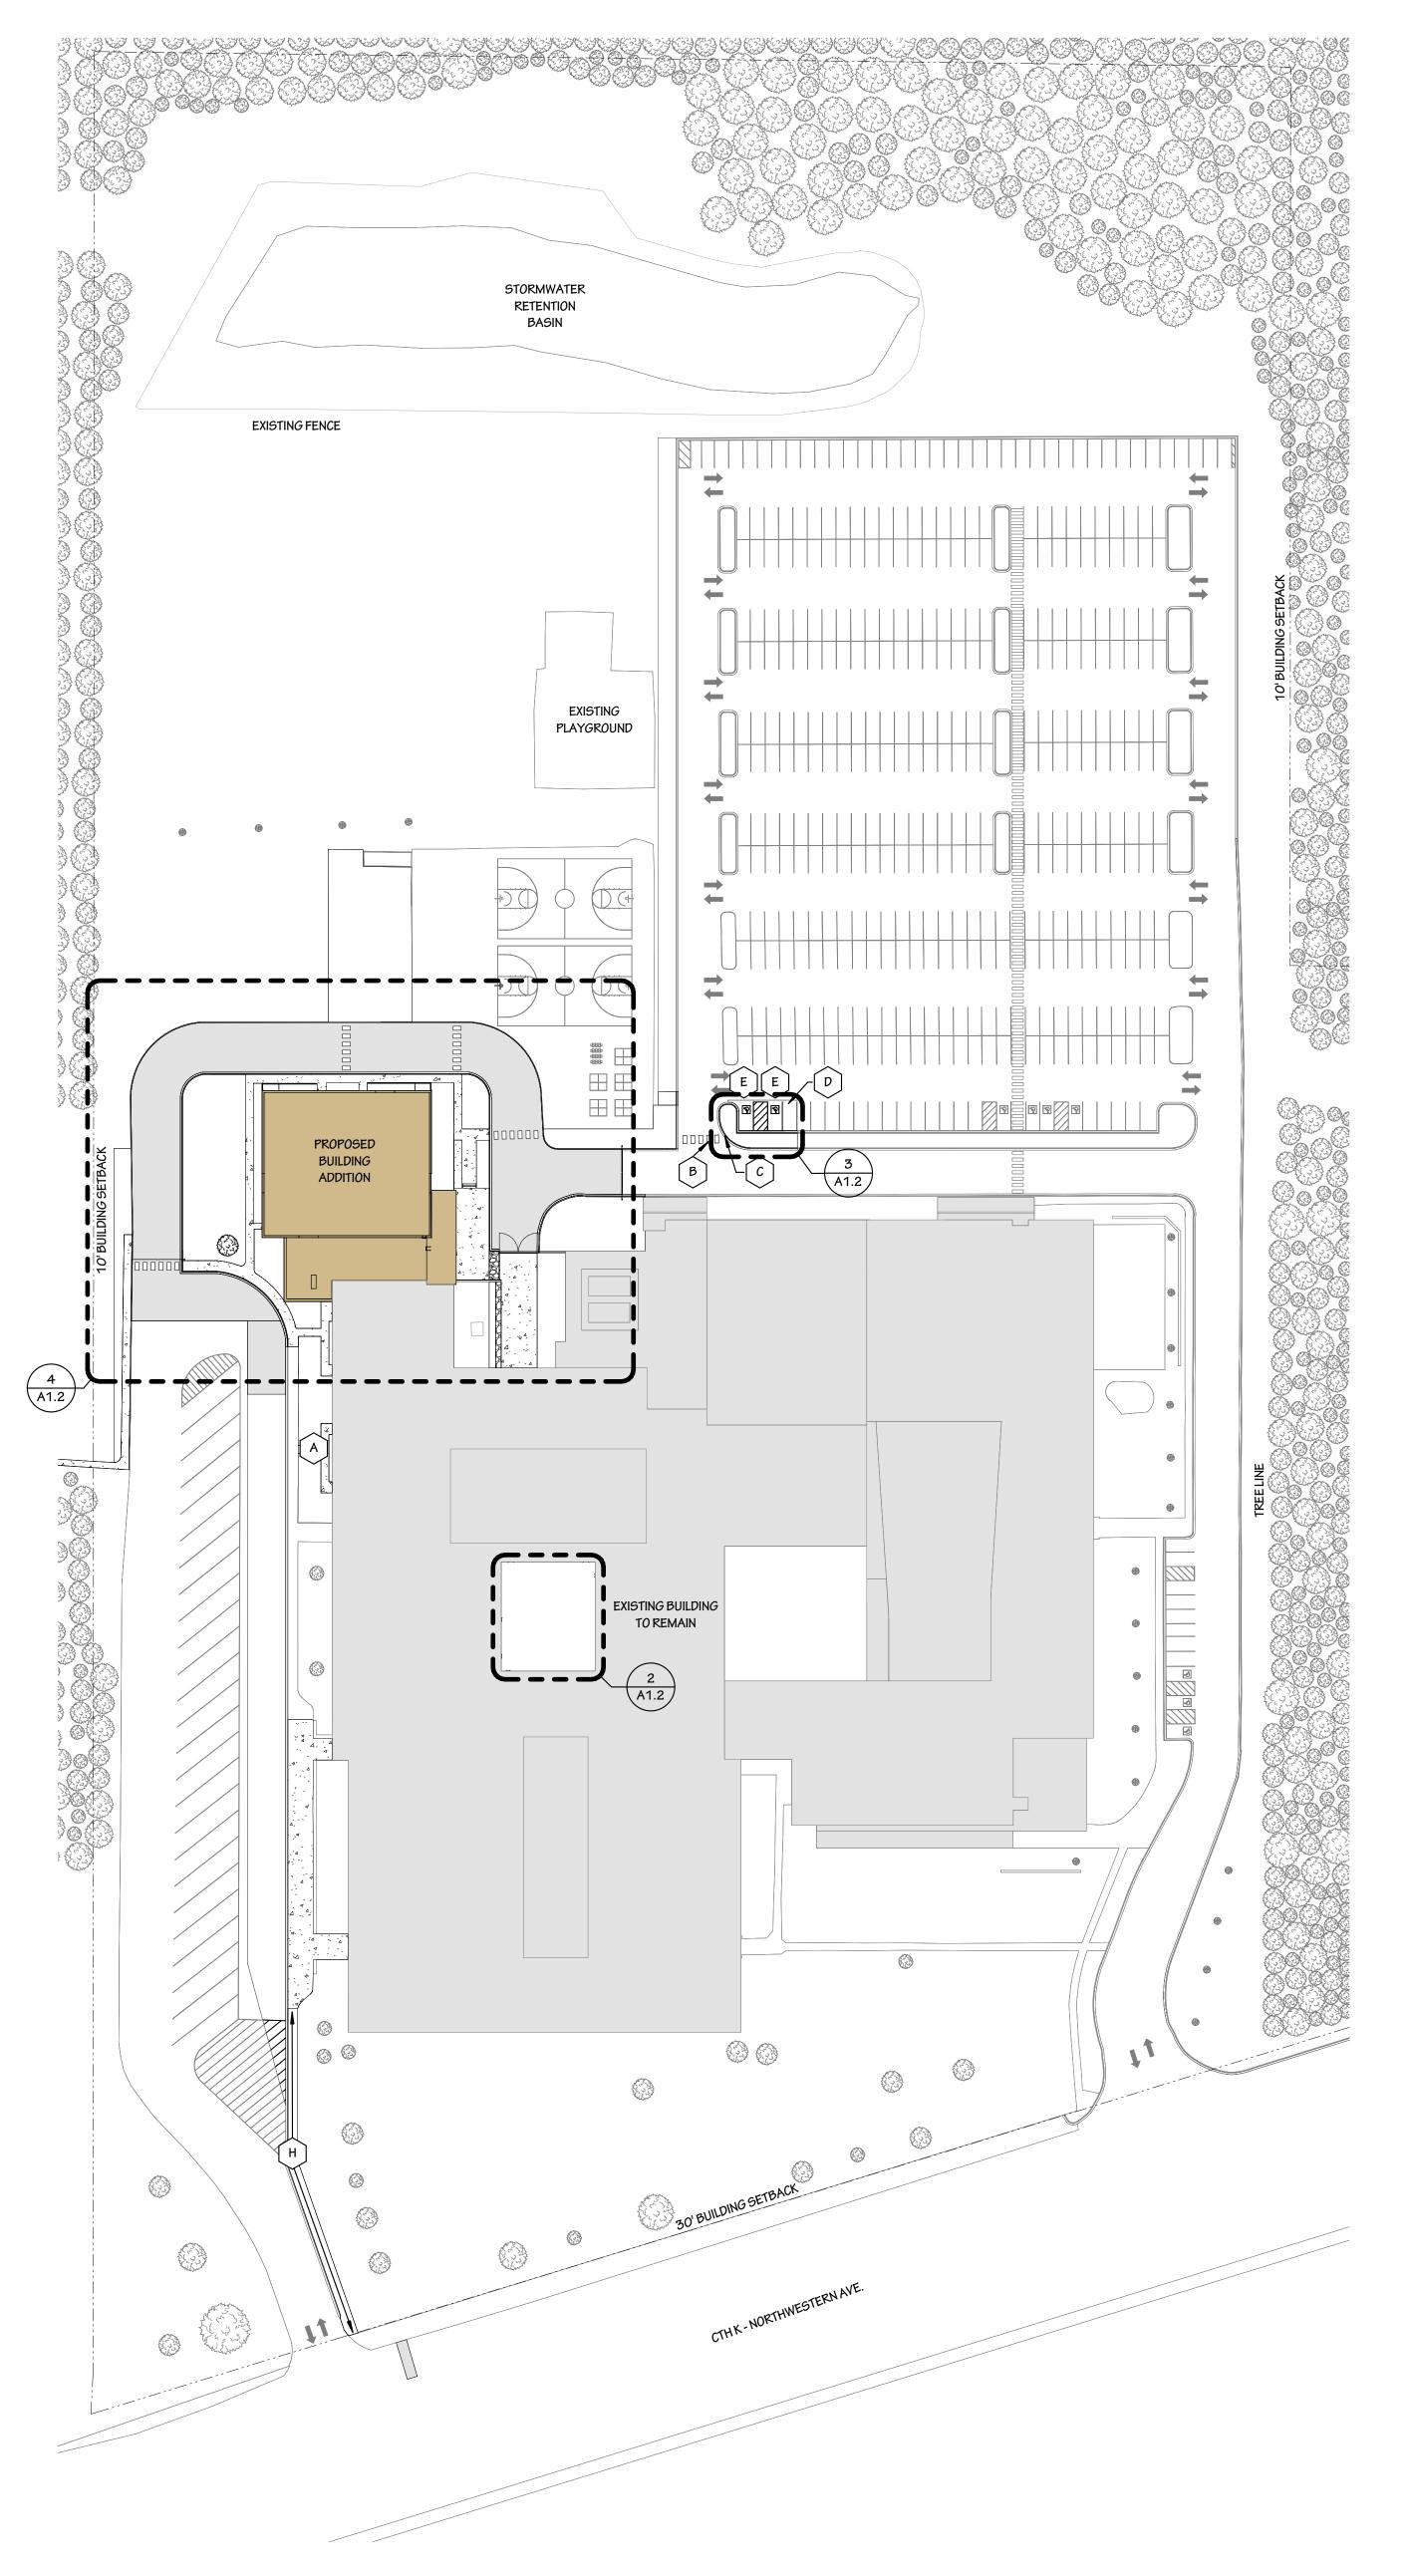

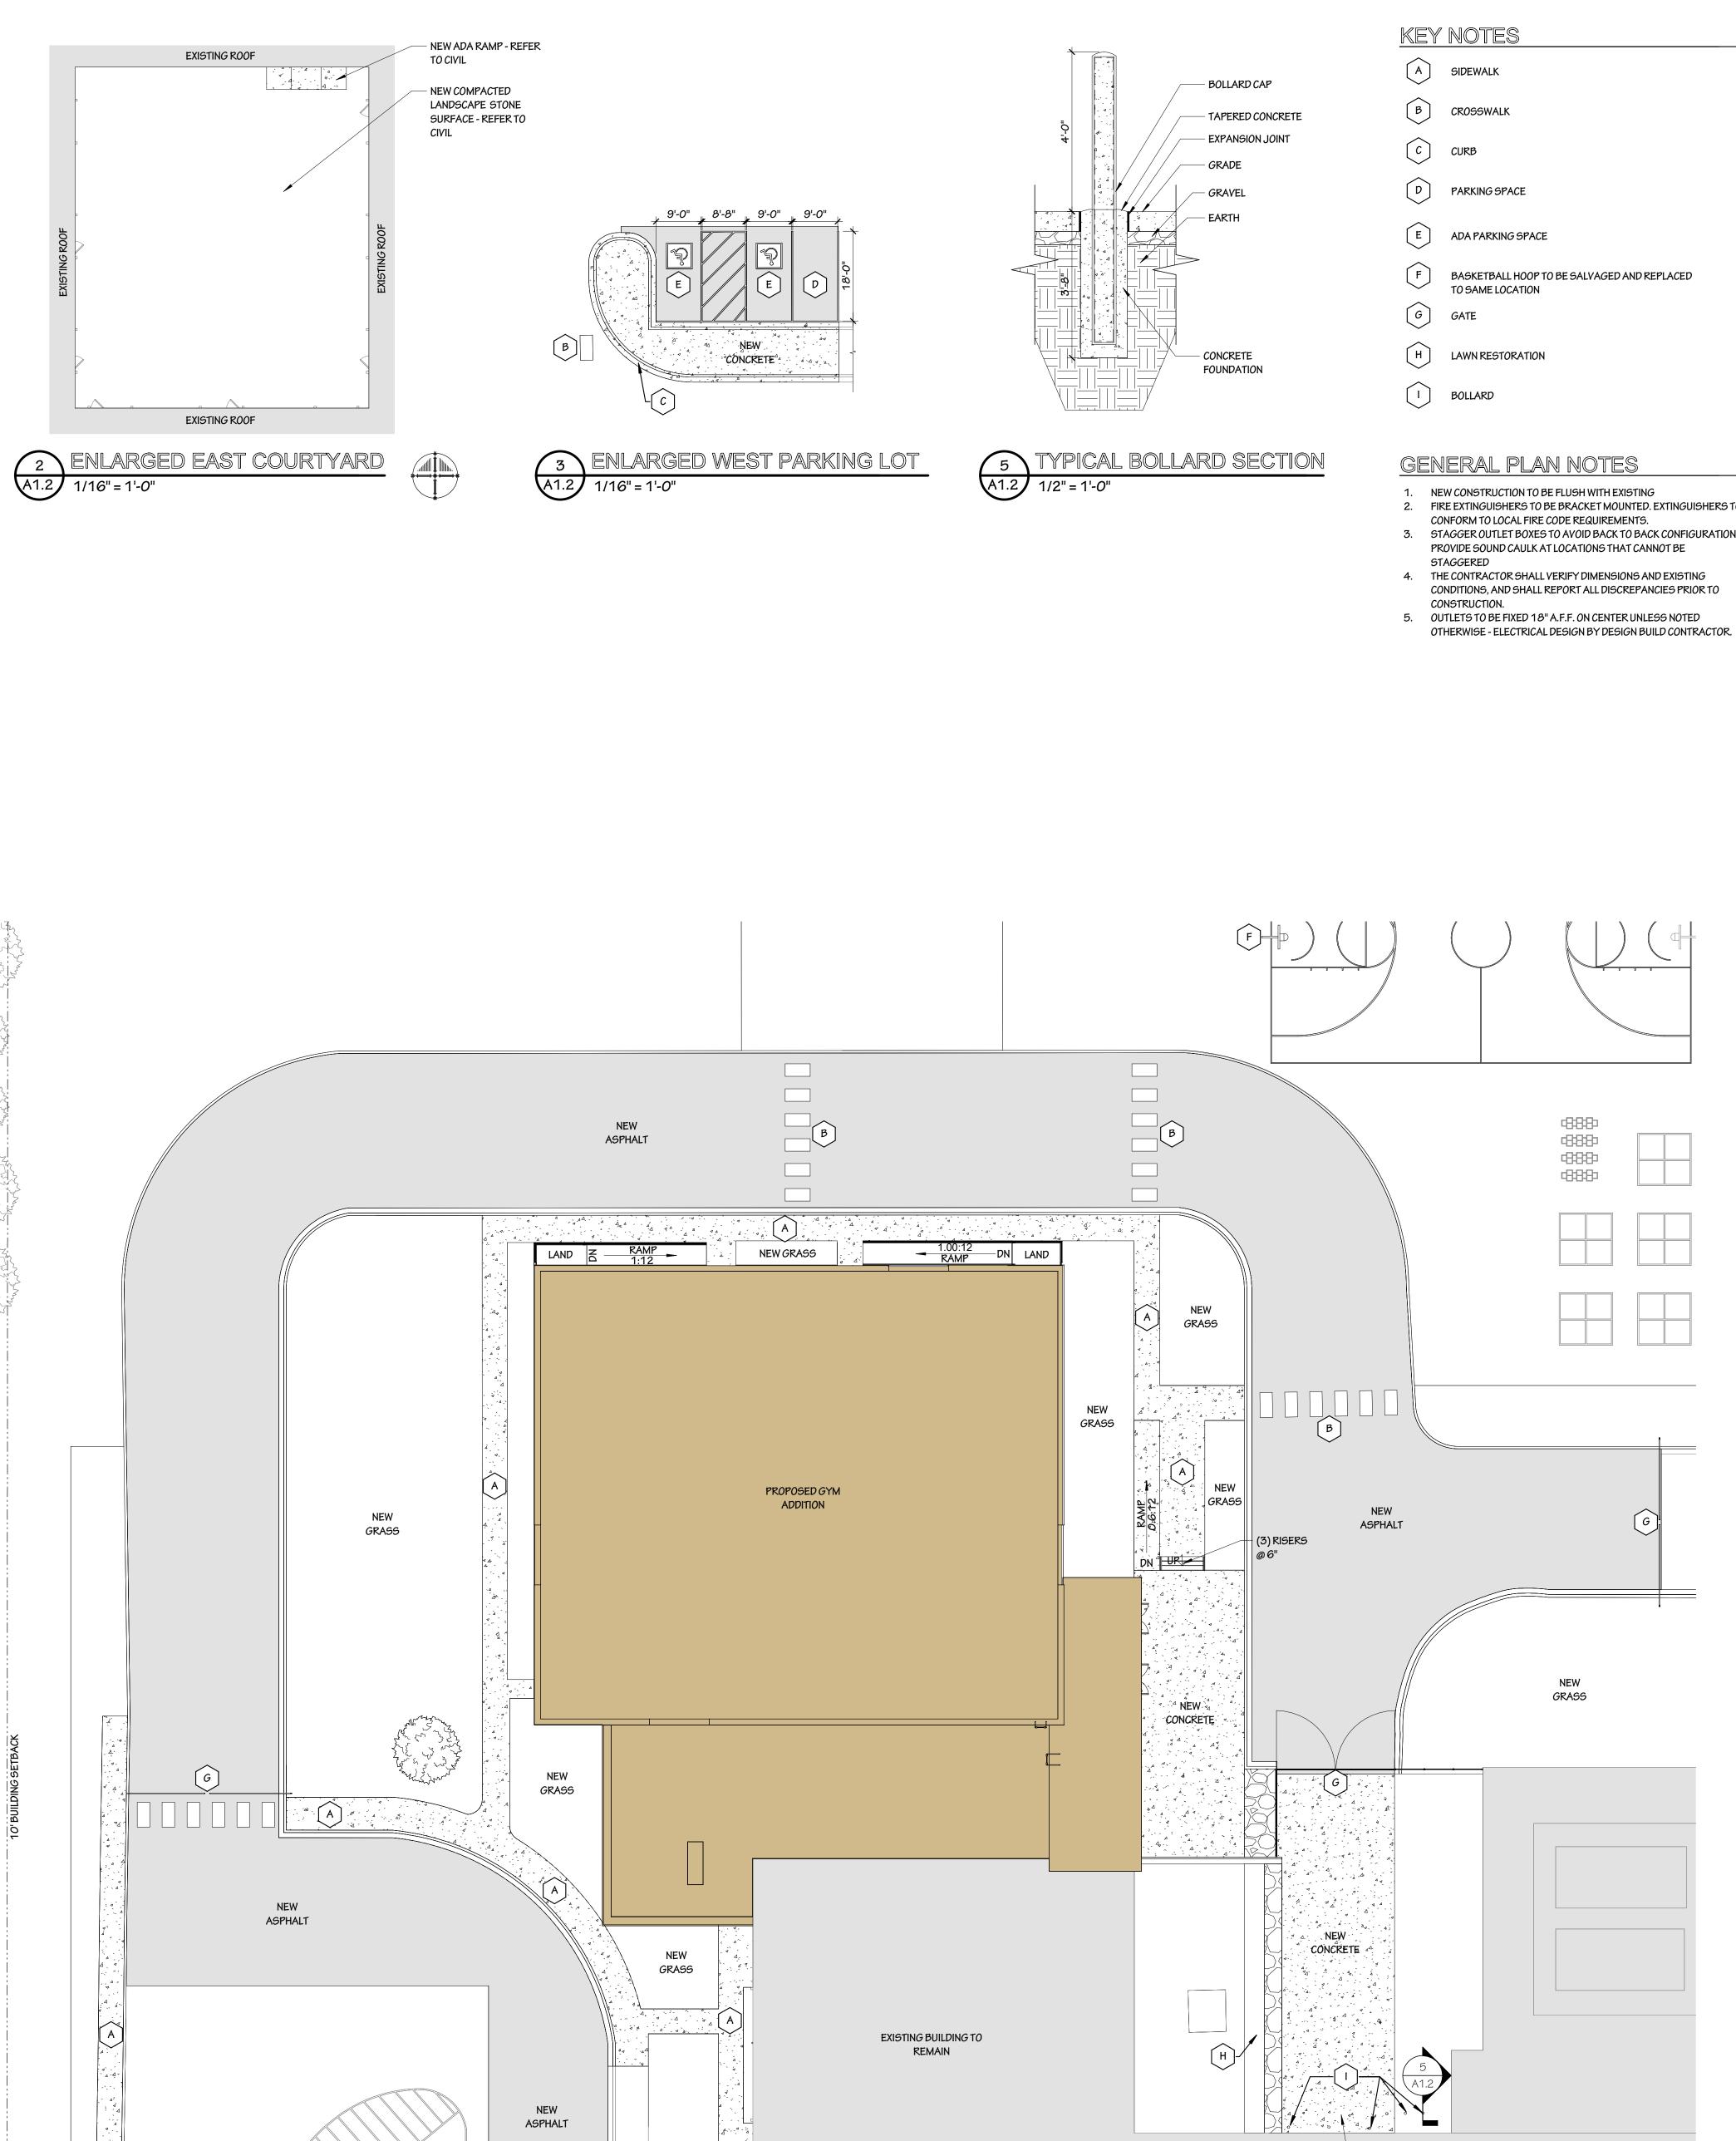

4 ENLARGED GYM ADDITION SITE PLAN
A1.2 1/16" = 1'-0"

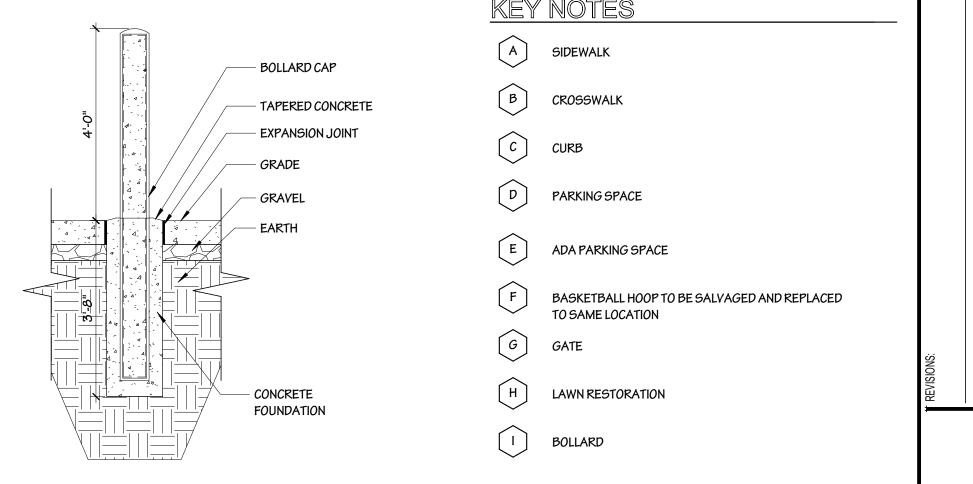

- 2. FIRE EXTINGUISHERS TO BE BRACKET MOUNTED. EXTINGUISHERS TO
- 3. STAGGER OUTLET BOXES TO AVOID BACK TO BACK CONFIGURATION.
- 5. OUTLETS TO BE FIXED 18" A.F.F. ON CENTER UNLESS NOTED

723.24.035


01.09.2025

LOCATION OF EXISTING LOADING
 DOCK TO BE DEMOLISHED AND


REPLACED

HEET NO.:

OVERALL ARCHITECTURAL SITE PLAN A1.2 1" = 60'-0"

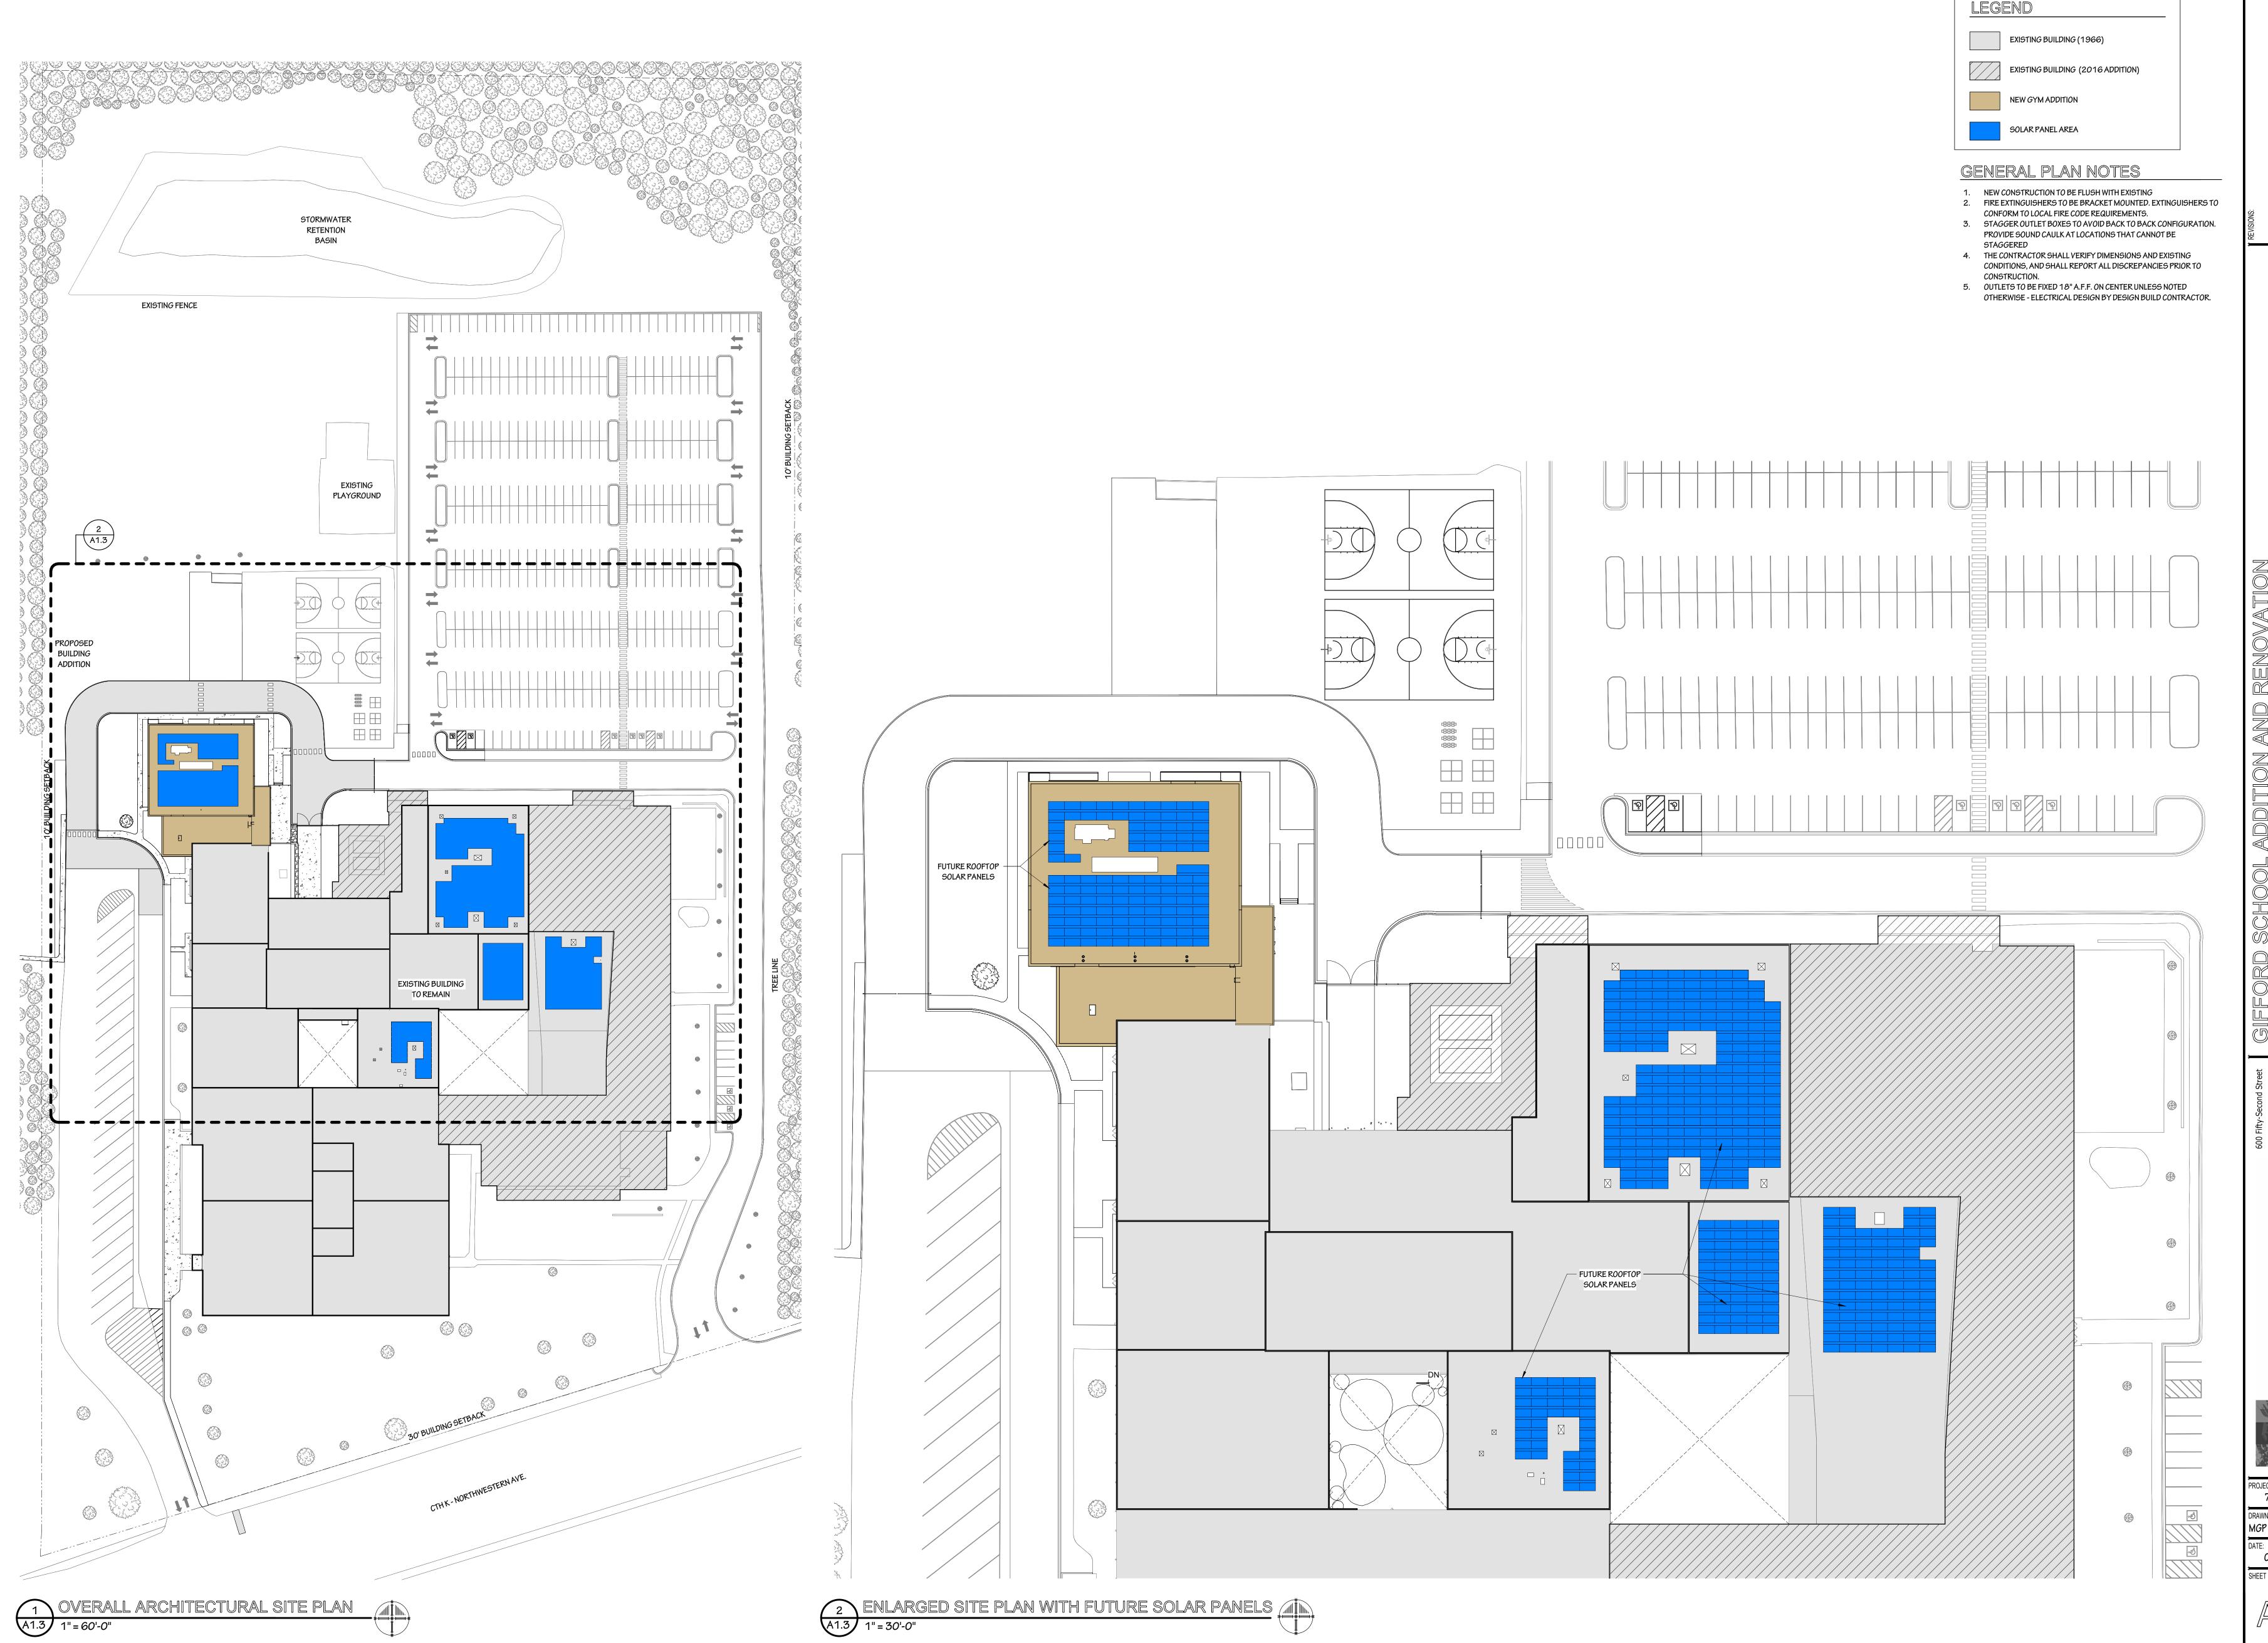

723.24.035

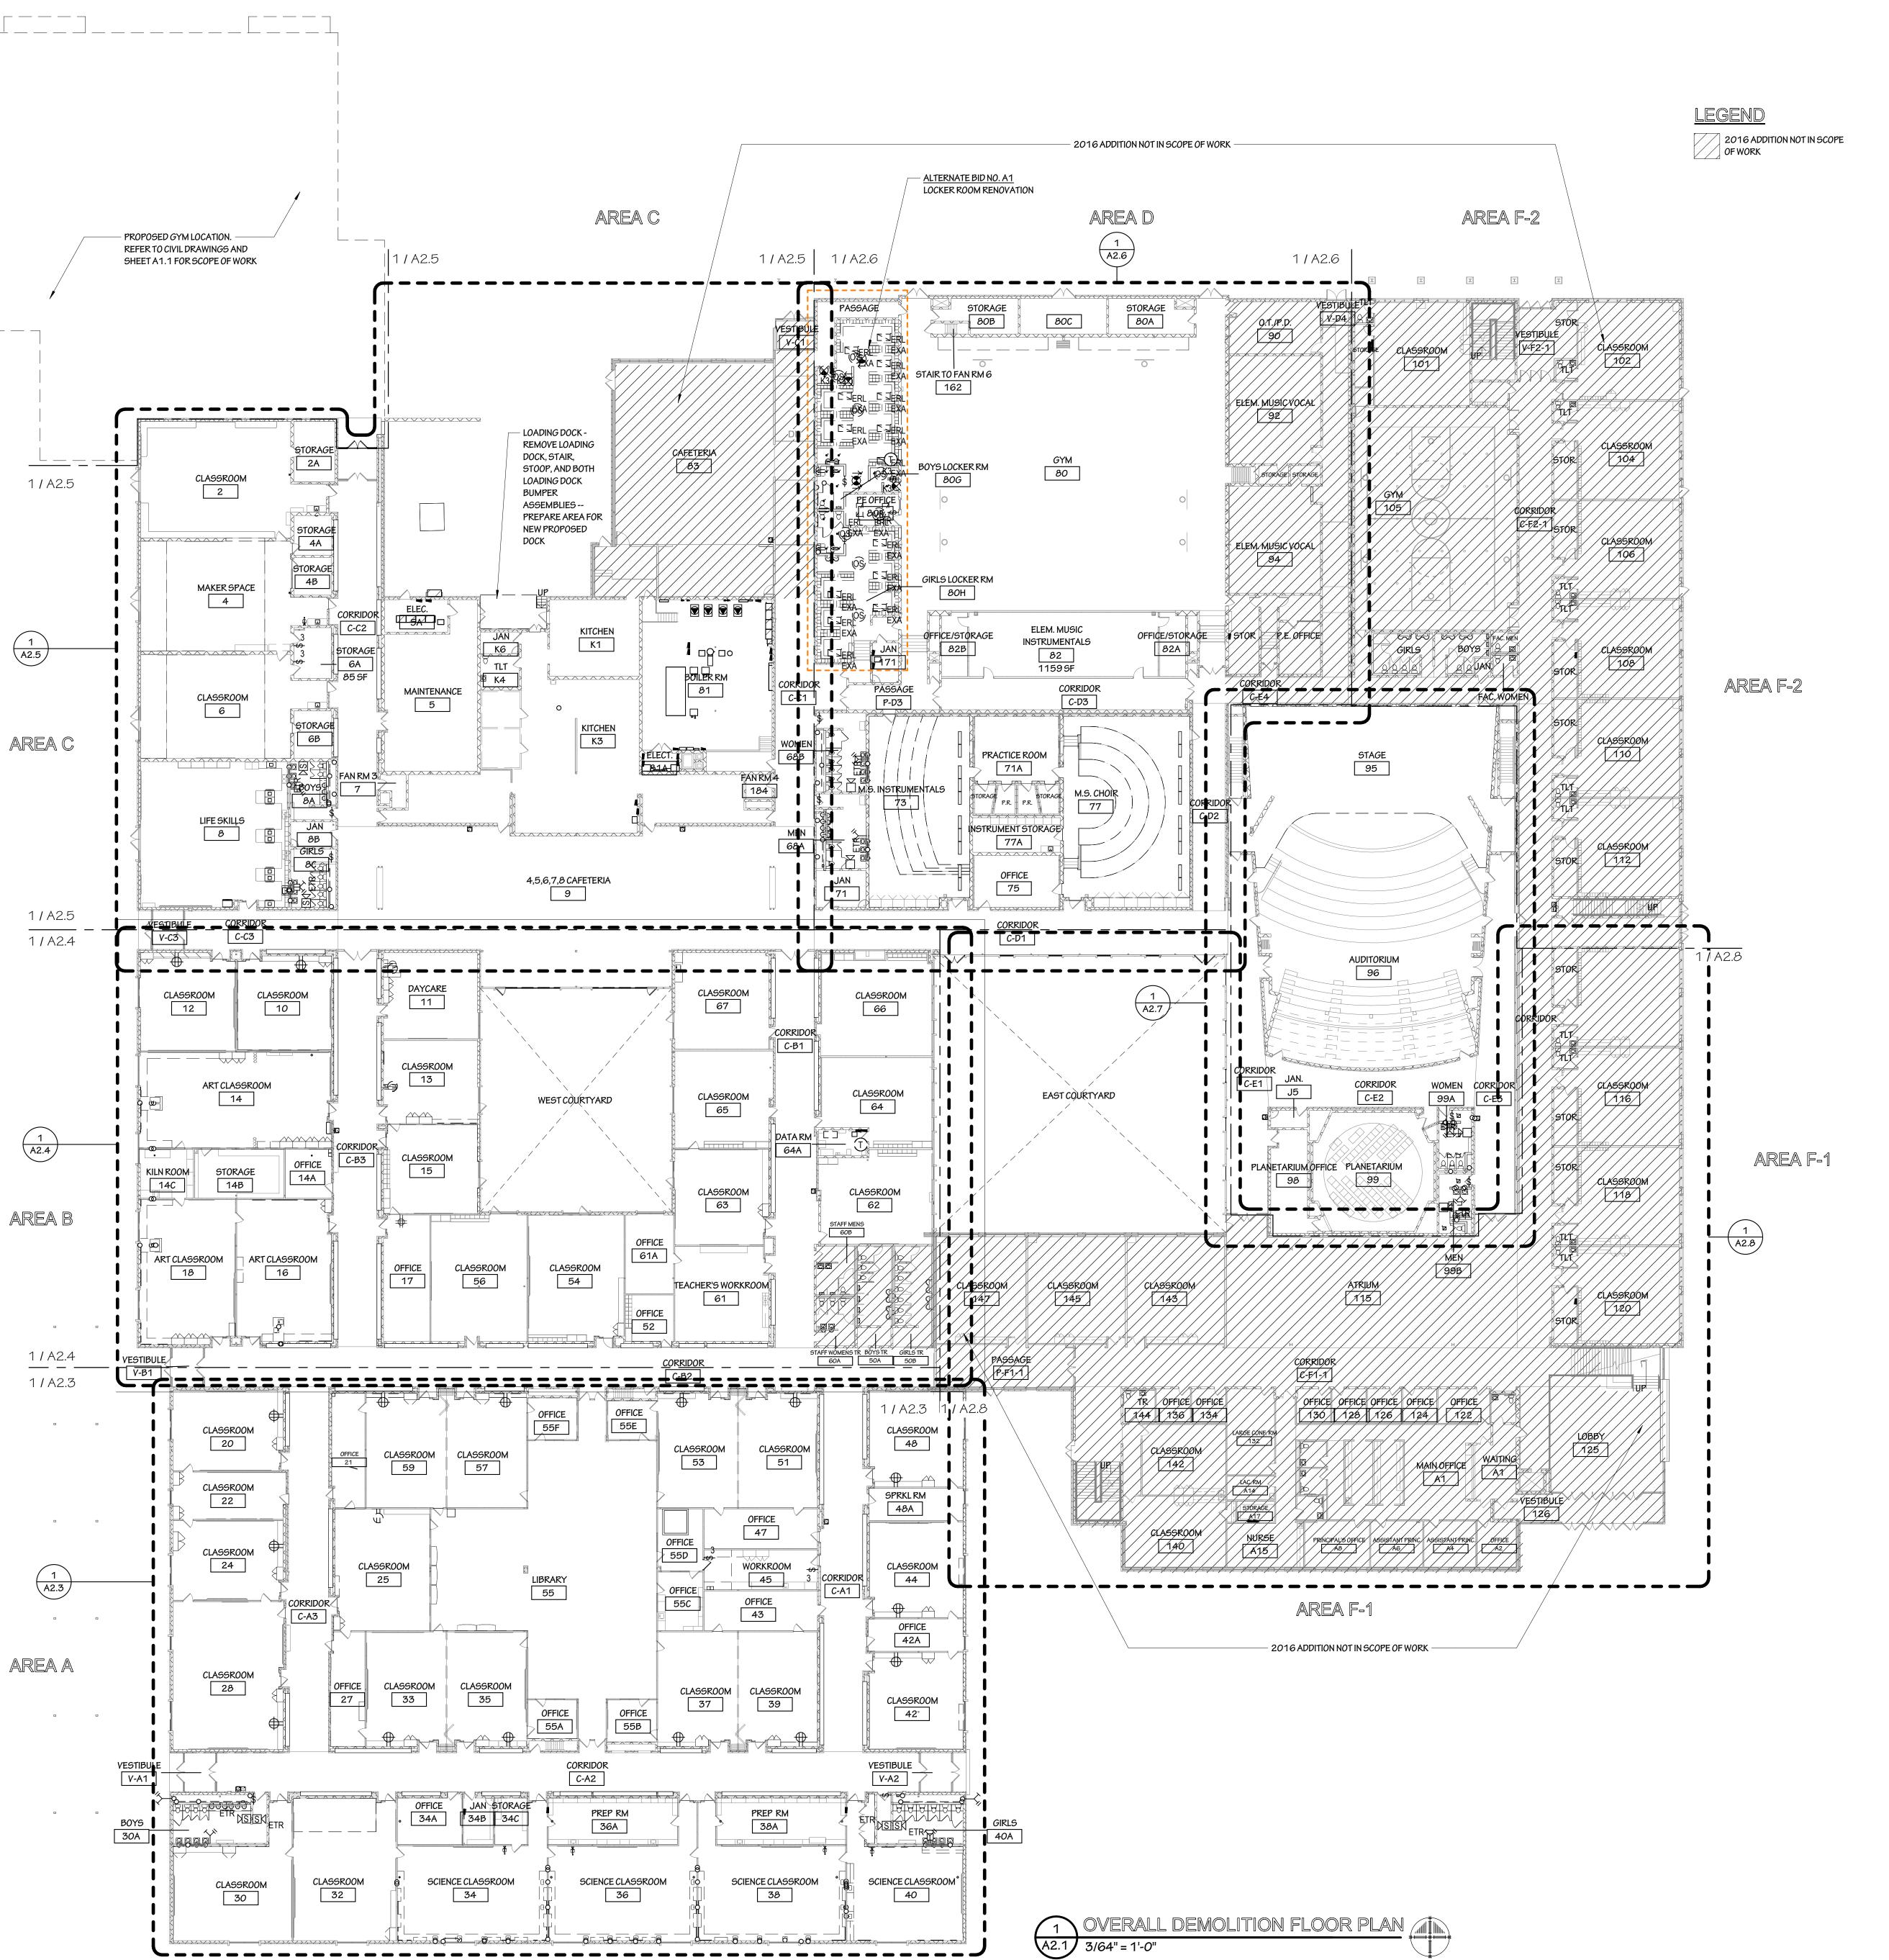

GENERAL DEMOLITION NOTES

- 1. DEMOLITION DRAWINGS ARE PROVIDED AS A REFERENCE TO ESTABLISH THE GENERAL SCOPE OF DEMOLITION WORK. CONTRACTOR IS RESPONSIBLE TO COMPLETE ALL DEMOLITION WORK WHERE REQUIRED TO ACCOMMODATE NEW CONSTRUCTION AND PROTECT THE STRUCTURAL INTEGRITY OF EXISTING-TO-REMAIN
- 2. MAINTAIN THE STRUCTURAL INTEGRITY OF THE EXISTING BUILDING TO REMAIN. IMMEDIATELY CONTACT THE ARCHITECT IS SCHEDULED DEMOLITION WORK WILL COMPROMISE STRUCTURAL INTEGRITY OF EXISTING BUILDING PRIOR TO DEMOLITION.
- 3. VERIFY EXISTING STRUCTURAL SUPPORTS AND LOCATION OF ALL STRUCTURAL SUPPORTING WALLS PRIOR TO DEMOLITION. ALL EXISTING STRUCTURAL SUPPORTS ARE TO REMAIN UNLESS NOTED OTHERWISE ON DEMOLITION PLAN.
- 4. COORDINATE ALL DEMOLITION WORK OUTLINED ON DEMOLITION PLAN WITH NEW FLOOR PLAN LAYOUT TO ALL FOR PROTECTION OF EXISTING TO REMAIN.
- 5. GENERAL CONTRACTOR TO COORDINATE WITH OTHER CONTRACTORS FOR ALL DEMOLITION WORK. G.C. SHALL PROVIDE NECESSARY ACCESS FOR OTHER CONTRACTORS TO ALLOW OTHER DEMOLITION WORK AND SHALL REPAIR SUCH DEMOLITION AREAS WITH MATERIALS TO MATCH FINAL FINISHES.
- 6. CONTRACTOR IS RESPONSIBLE FOR PATCHING WALLS, FLOORS, ETC. AND LEVELING EXISTING SURFACES AS REQUIRED TO MATCH ALL ADJACENT SURFACES WHERE REMOVAL WORK HAS OCCURRED, ESPECIALLY WHERE REMOVED WALLS INTERSECT WALLS TO REMAIN AND EXISTING FLOORS SCHEDULED FOR NEW FINISHES.
- 7. GENERAL CONTRACTOR IS REQUIRED TO WALK THROUGH THE PROJECT SITE TO BECOME FAMILIAR WITH THE SCOPE AND INTENT OF THE CONSTRUCTION DOCUMENTS.
- 8. SAWCUT AND REMOVE & PATCH ALL WALLS AND FLOORS AS REQUIRED FOR NEW MECHANICAL, PLUMBING, ELECTRICAL, AND STRUCTURAL WORK AS REQUIRED.
- 9. CONTRACTORS TO FIELD VERIFY REQUIRED MECHANICAL, PLUMBING, AND ELECTRICAL DEMOLITION.
- 10. RECONFIGURE EXISTING MECHANICAL, ELECTRICAL, AND PLUMBING SYSTEMS PER THE NEW FLOOR PLAN AND ALL APPLICABLE CODES TERMINATE AND REMOVE ALL UNUSED CONNECTIONS PER CODE.
- ALL DEMOLITION DIMENSIONS ARE TO FINISHED OPENINGS & TO BE COORDINATED WITH NEW CONSTRUCTION.


AREA C

AREA B


AREA F-1


AREA A


FIRST FLOOR KEY PLAN

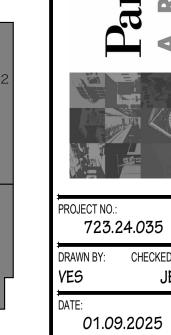


SHEET NO.:

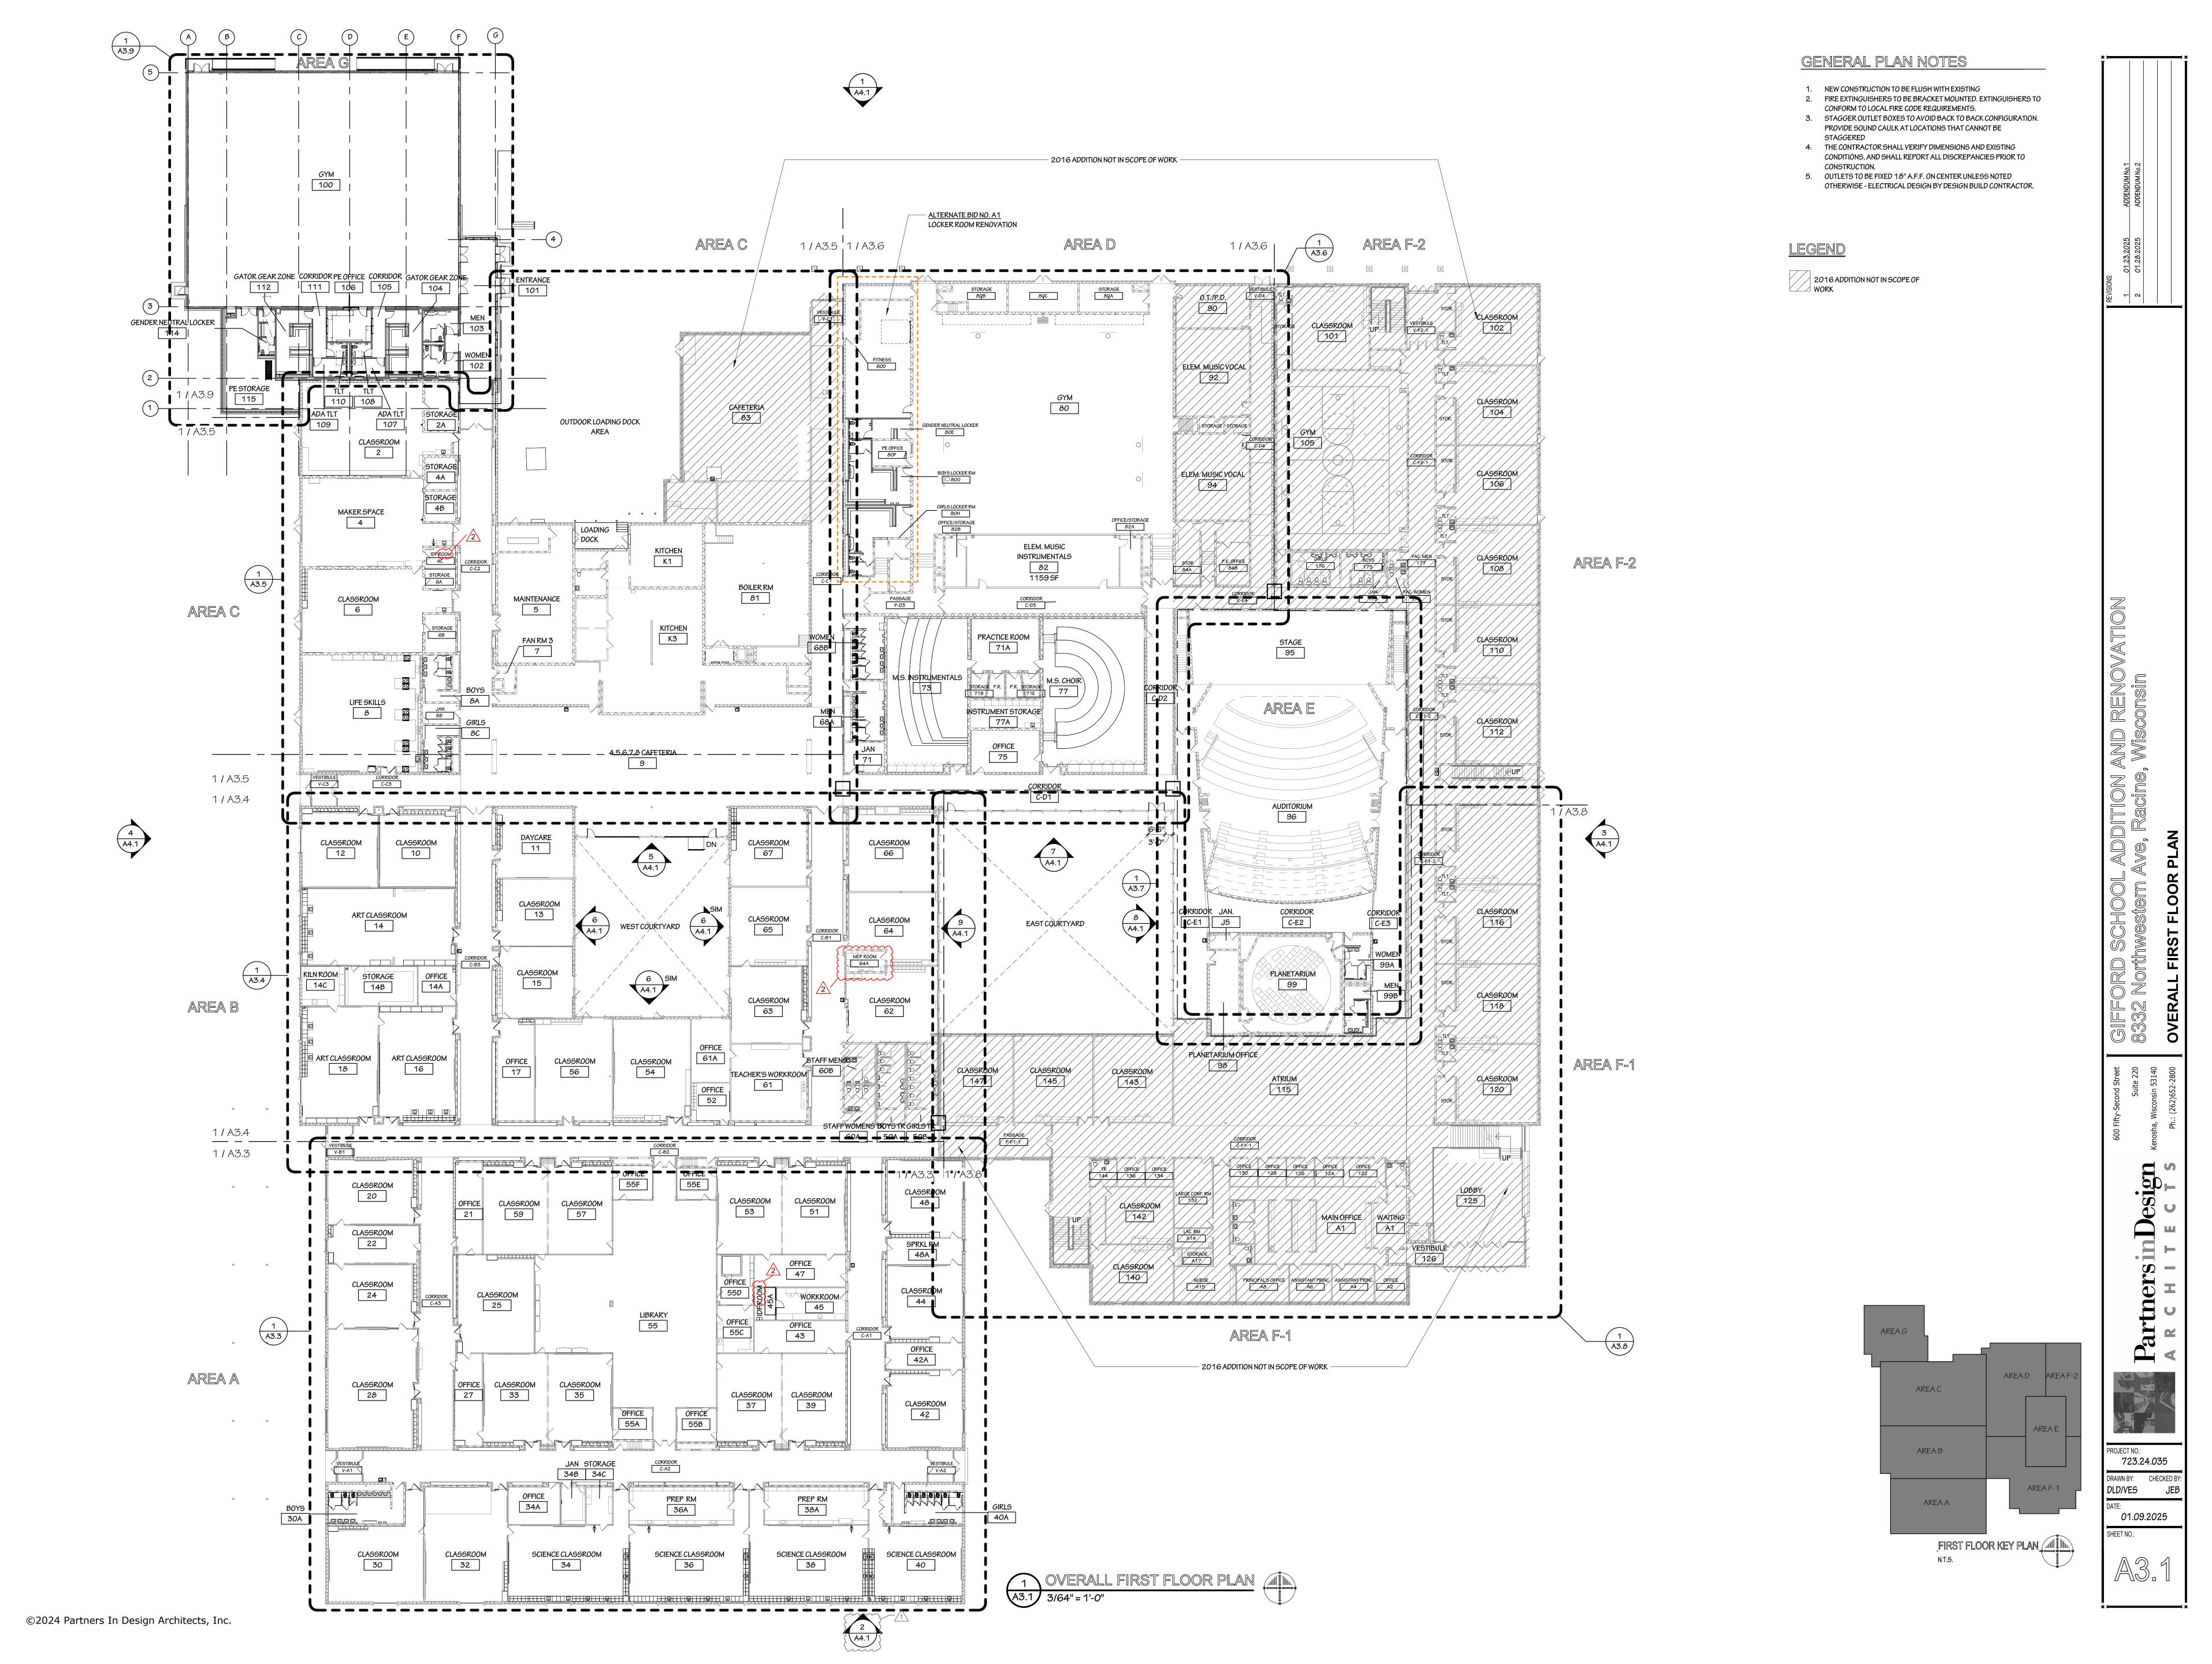

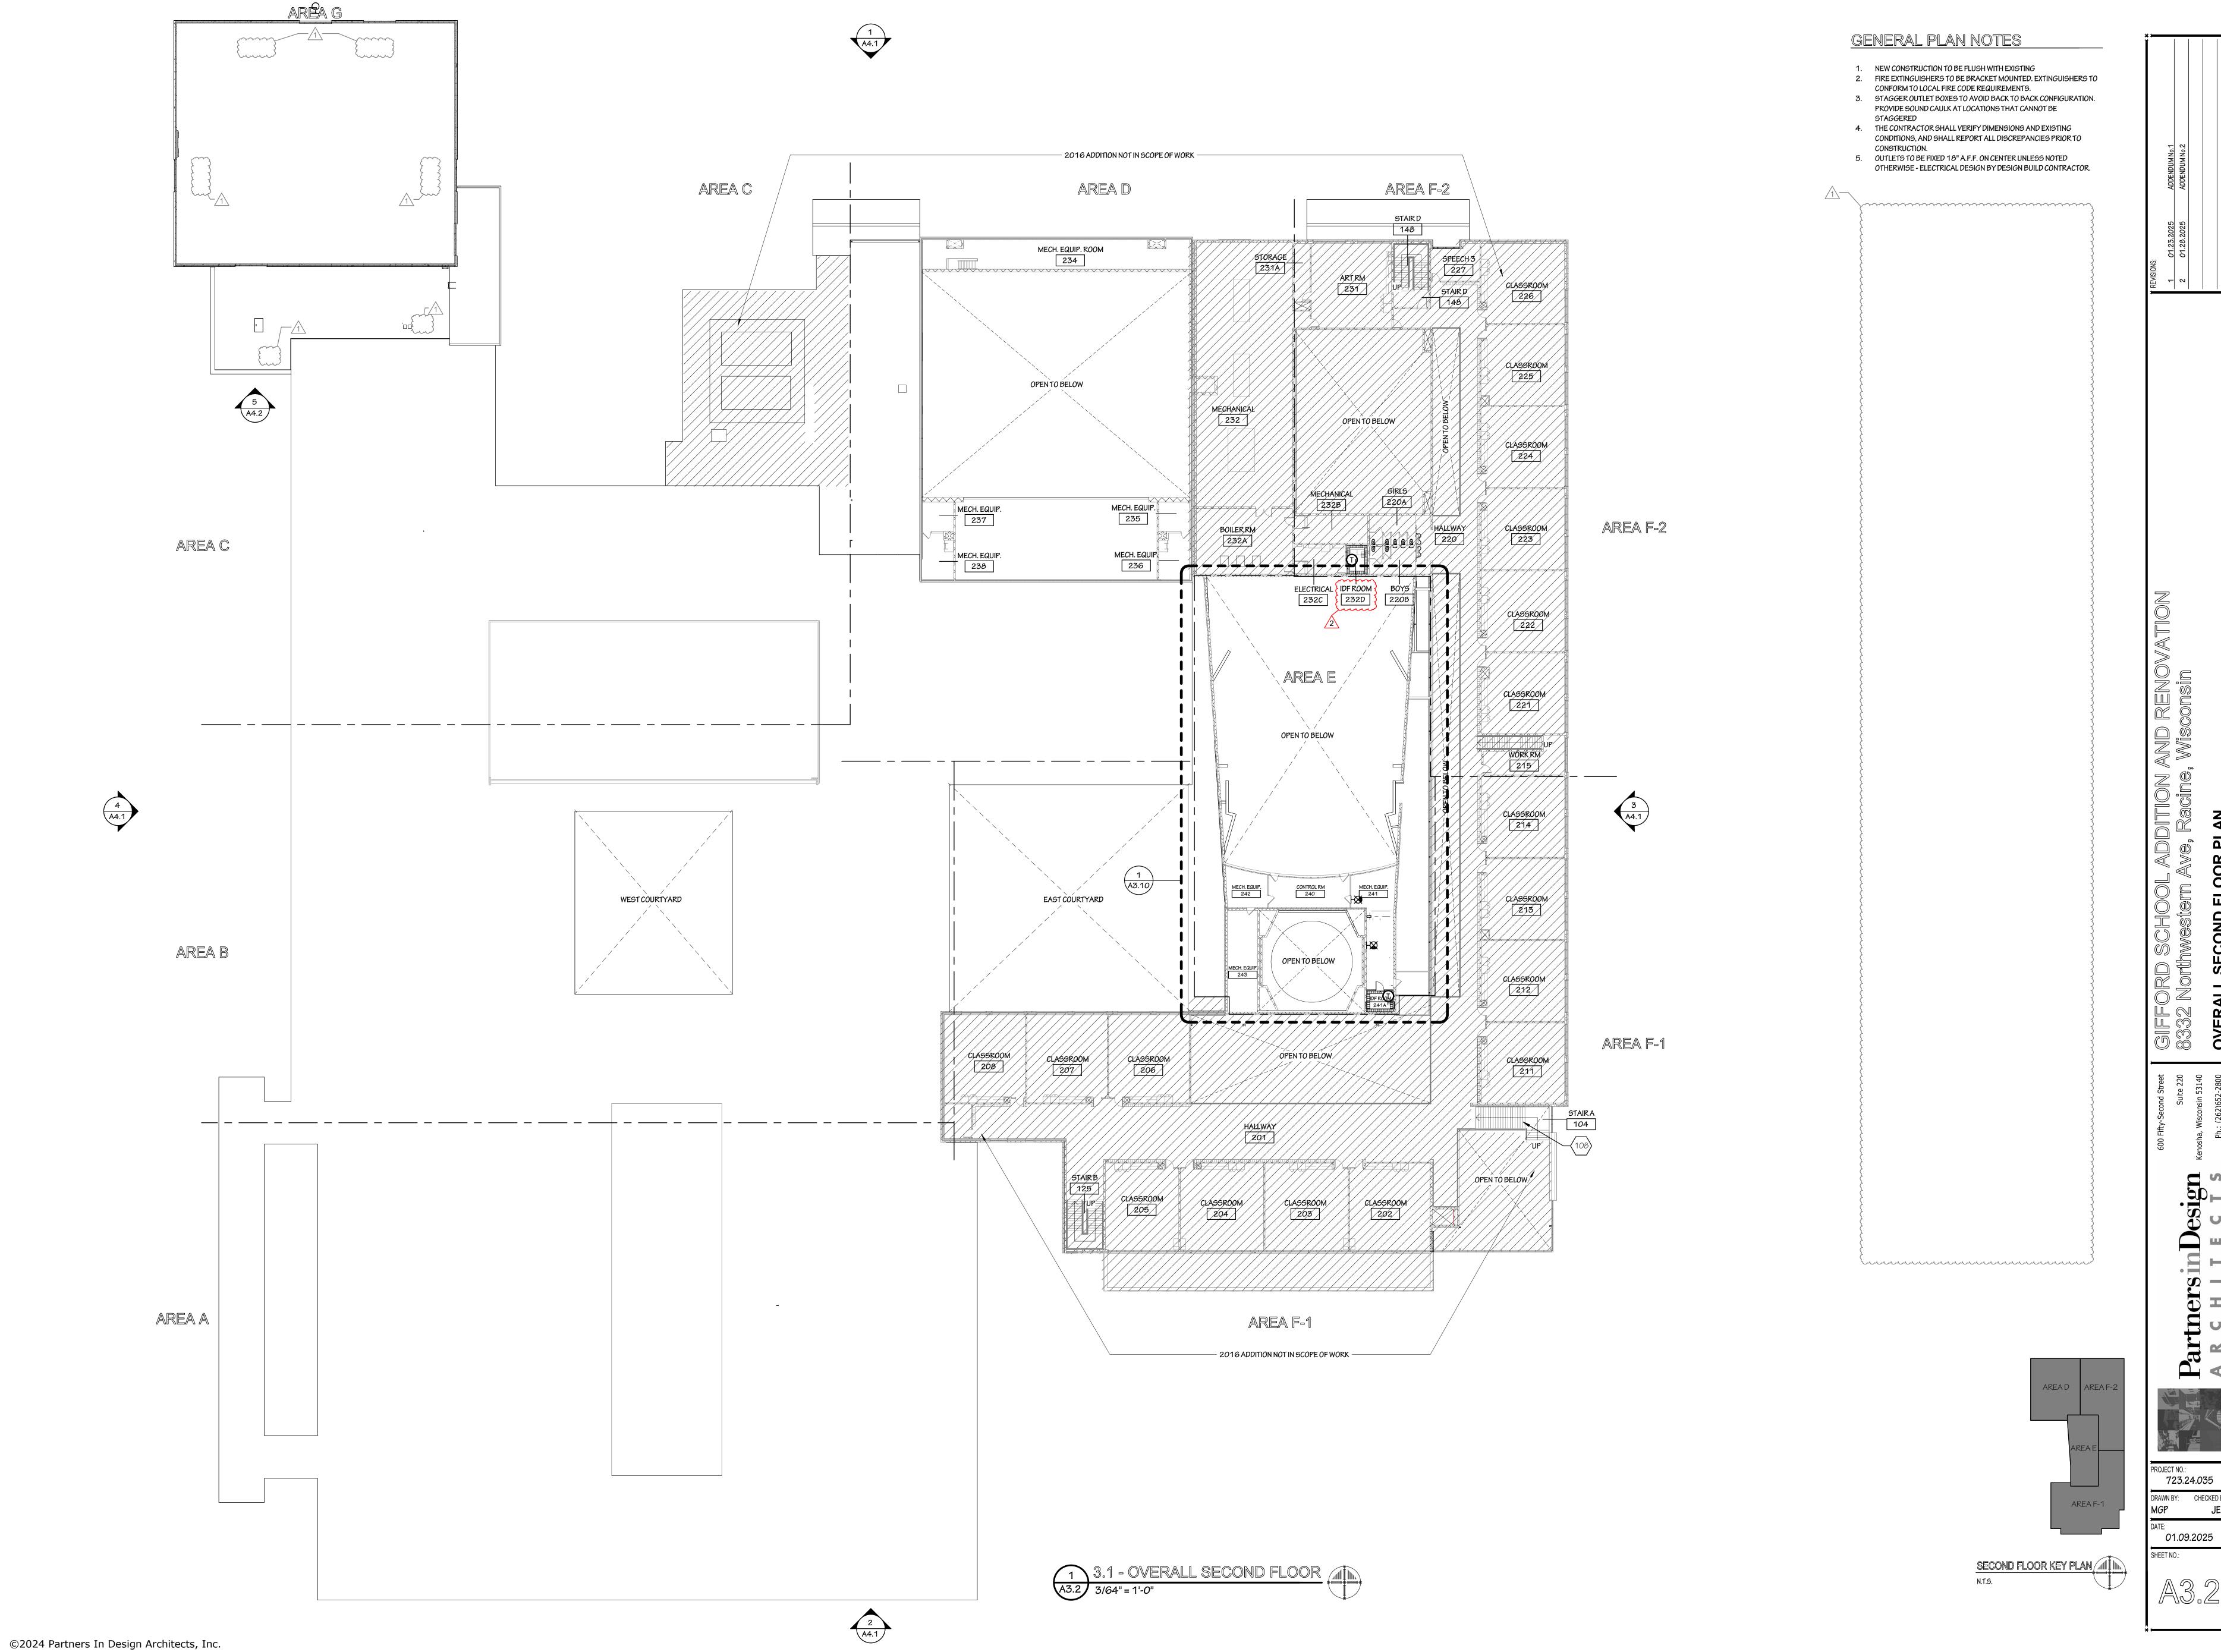

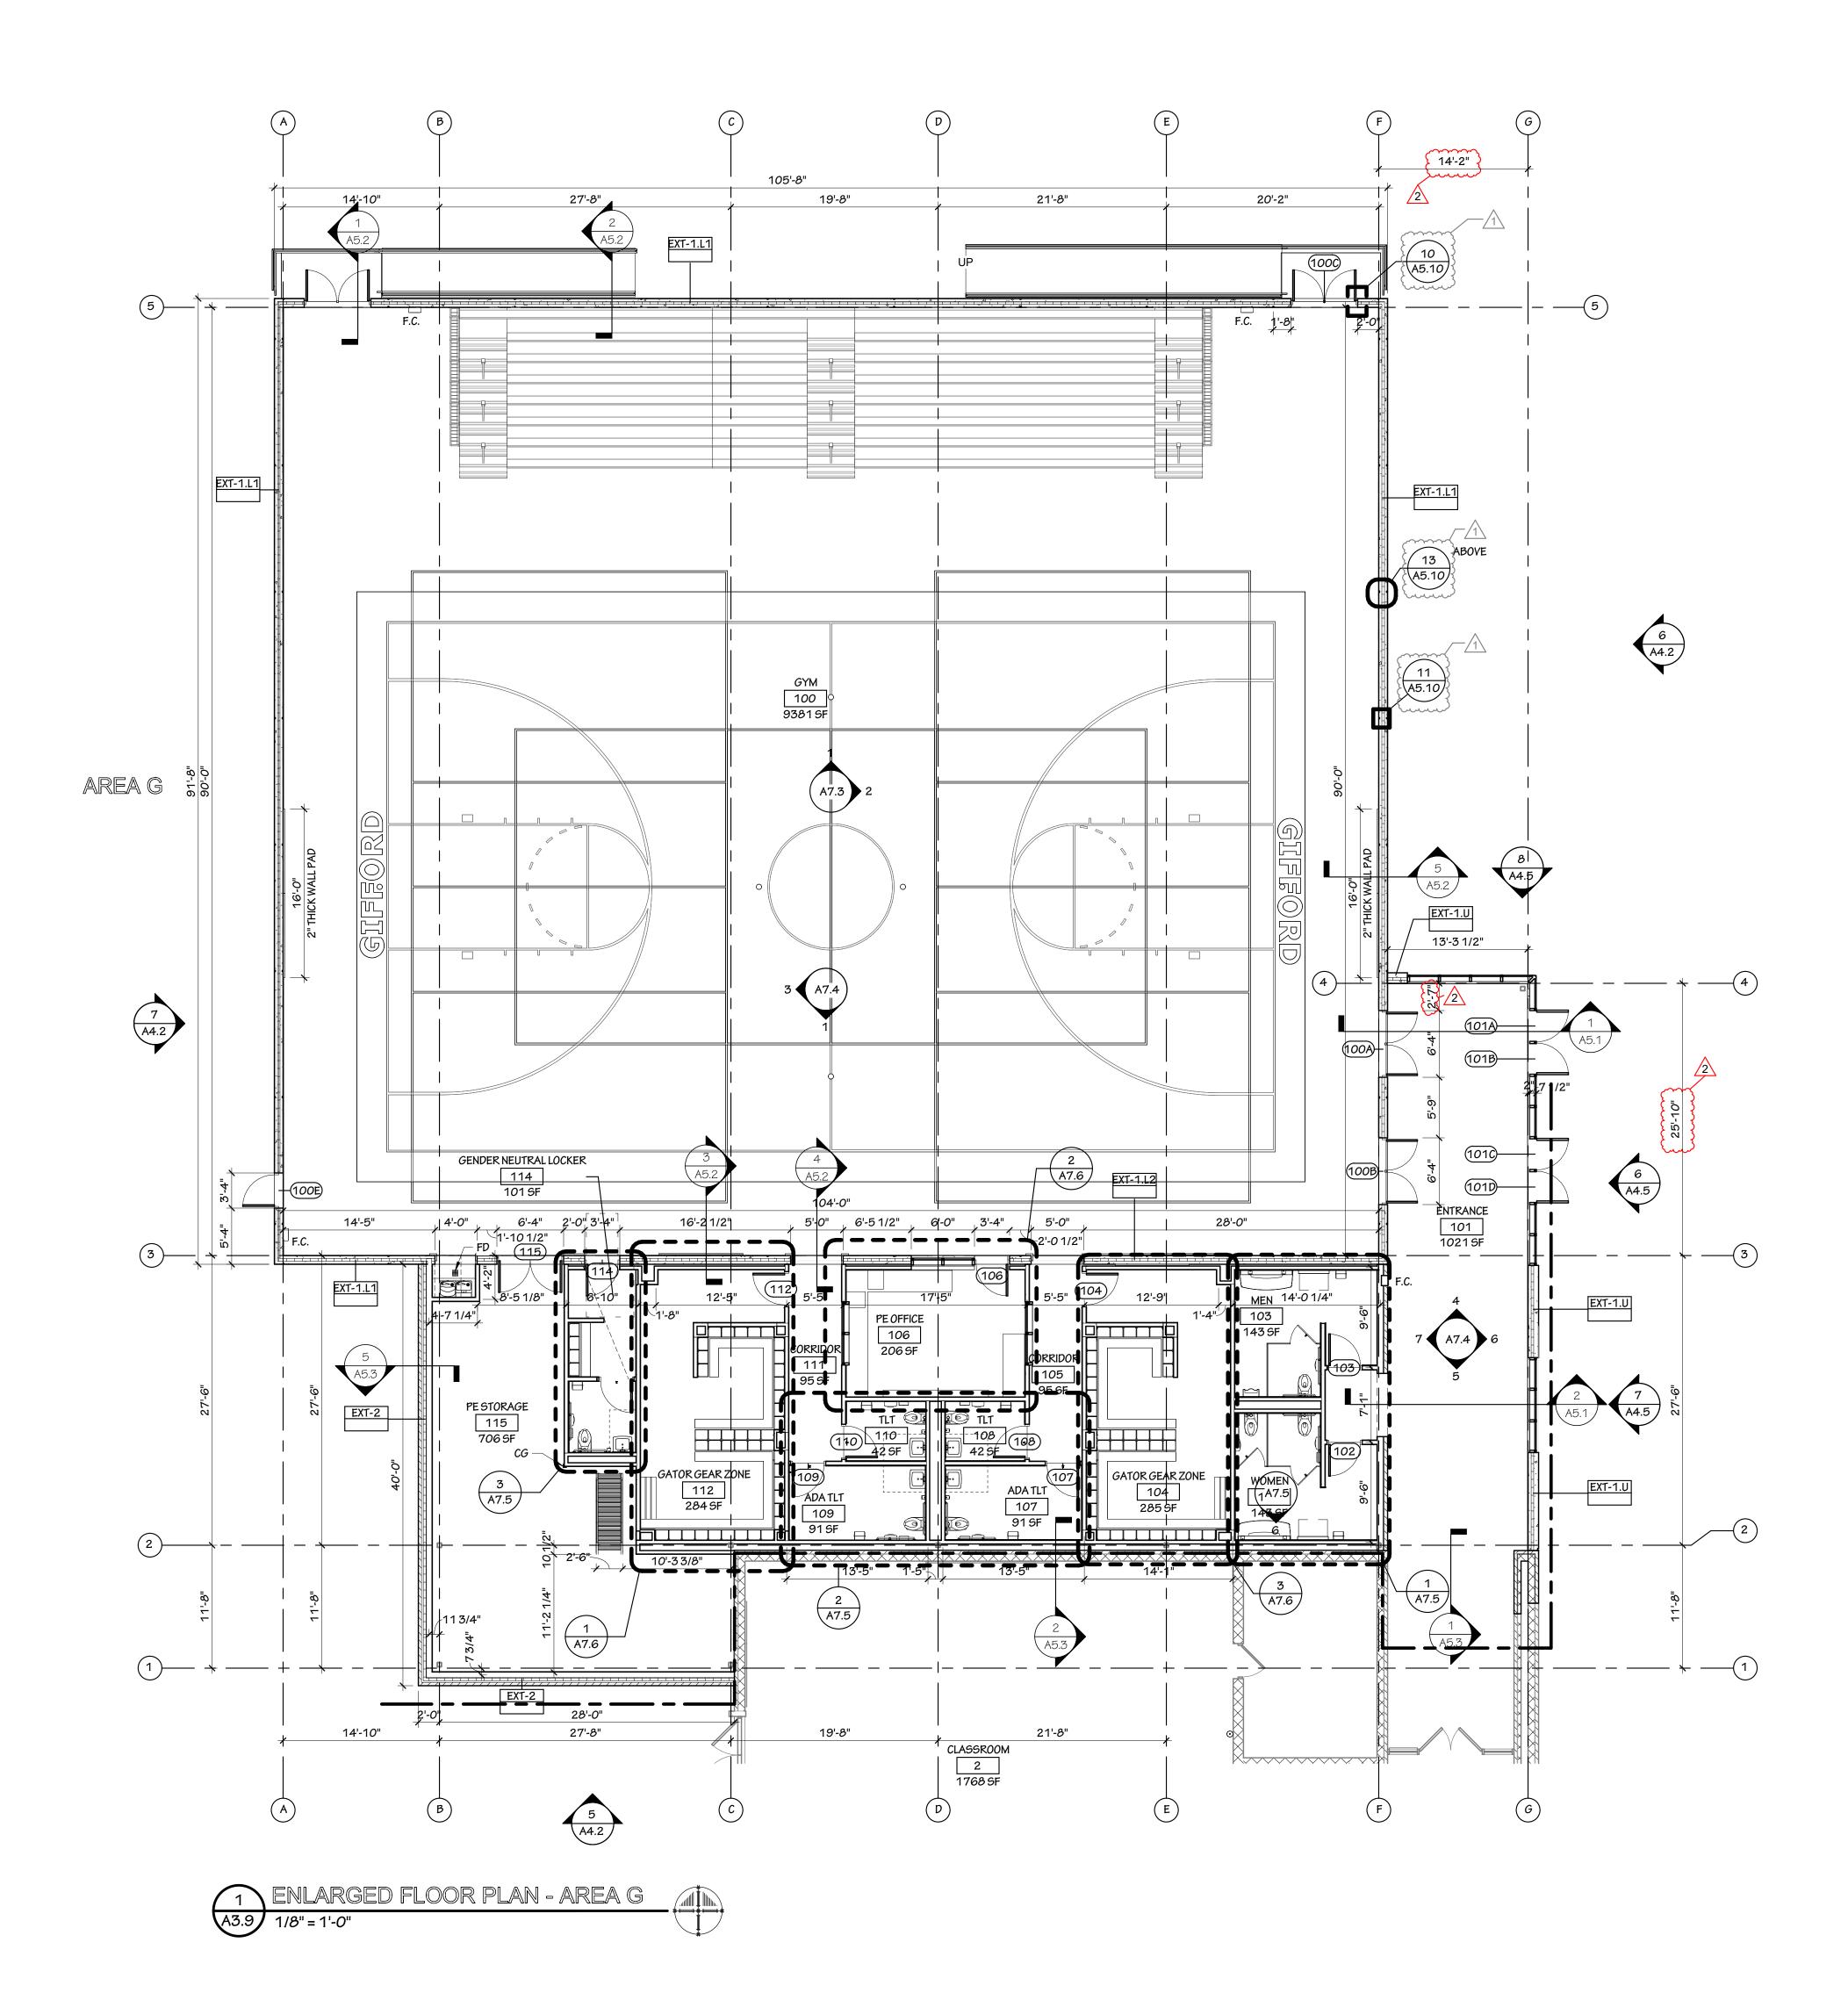

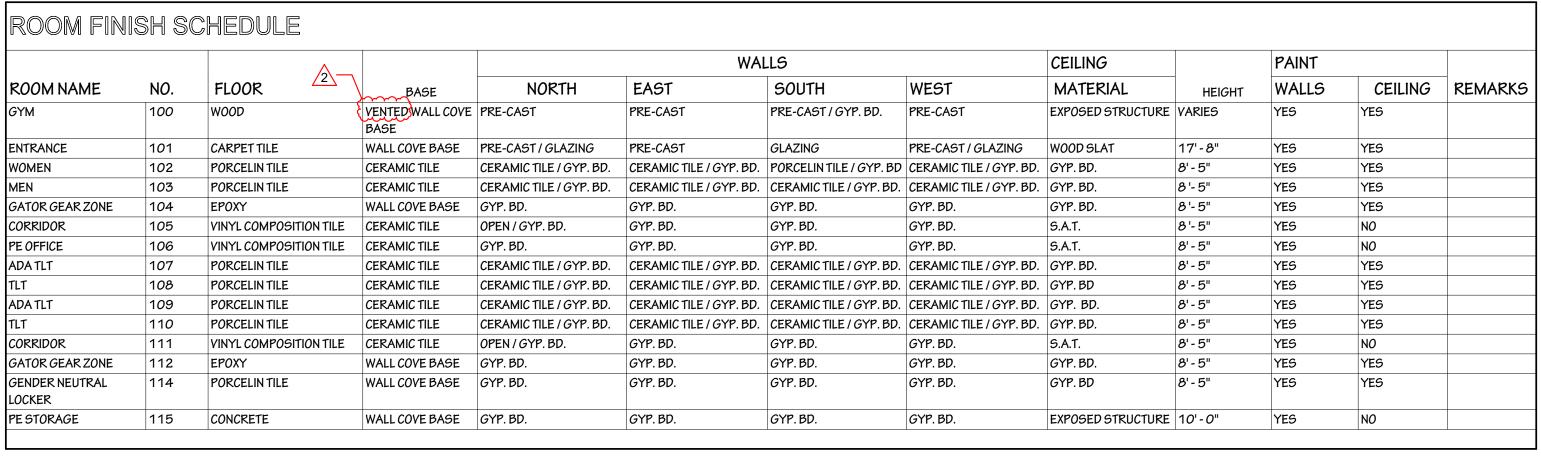

ROOM FINISH SCHEDULE NOTES: 1. PAINT WINDOW FRAMES. 2. PAINT GYPSUM SOFFIT.


WALL TYPES


6" METAL STUDS # 16" O.C.

OMIT INTERIOR BRICKS AND FINISH AND PAINT DRYWALL


 ALL WALLS TO BE BRACED. 2. ALL GYP.BD. TO BE 5/8" TYPE 'X' UNLESS NOTED OTHERWISE.


- 3. PROVIDE GALVANIZED STUD TRACK WITH 3' LEGS AT TOP OF ANY FRAMING TO UNDERSIDE OF DECK STRUCTURE TO ALLOW FOR 1' DEFLECTION MINIMUM AND 1' CLEAR BETWEEN TRACK AND ANY APPLIED WALL SURFACE - NO WELD OR
- MECHANICAL FASTENING BETWEEN STUD AND TRACK. 4. PROVIDE WALL BRACING BETWEEN TOPS OF WALLS AND TO STRUCTURE ABOVE AS REQUIRED. ALLOW FOR BUILDING WALL EXPANSION BETWEEN
- EXISTING MASONRY SHELL AND NEW CONSTRUCTION. 5. PROVIDE 5/8" TYPE 'X' MOISTURE RESISTANT GYP. BD. AT ALL WET WALLS AND WALL FACES WITHIN 72' OF PLUMBING FIXTURES.

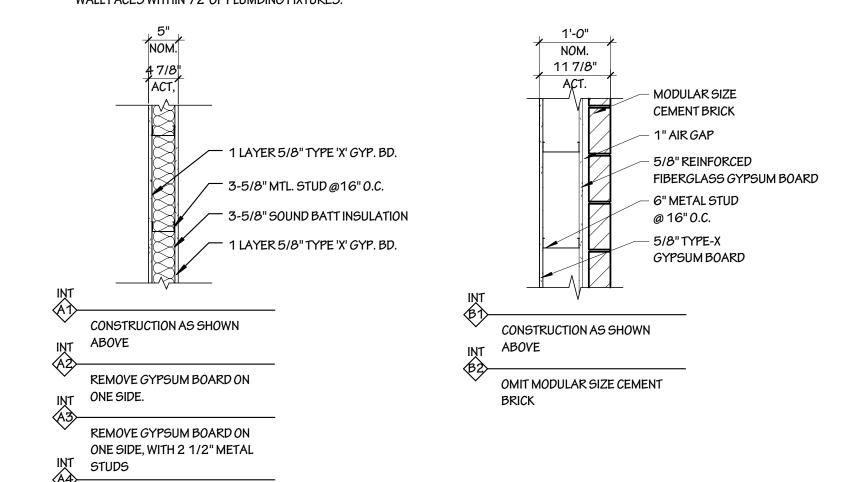


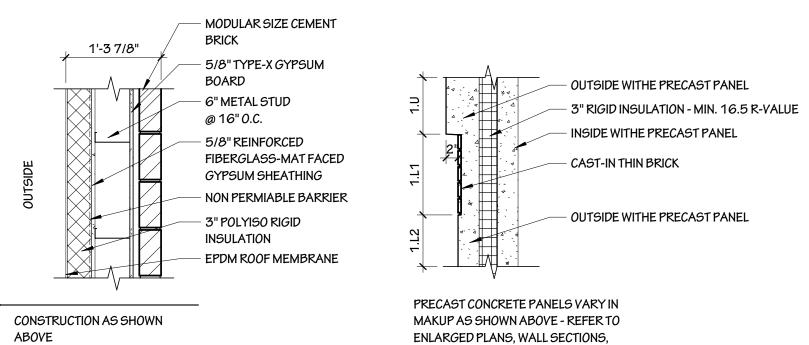


AND ELEVATIONS FOR THE EXTENTS XT OF EACH WALL MAKEUP TYPE CONSTRUCT AS SHOWN ABOVE CONSTRUCT AS SHOWN ABOVE CONSTRUCT AS SHOWN ABOVE

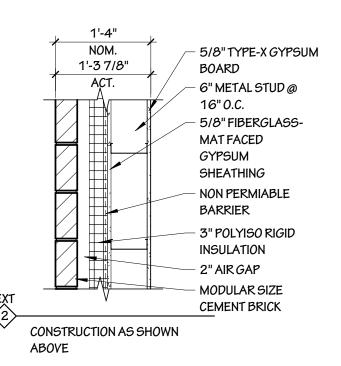

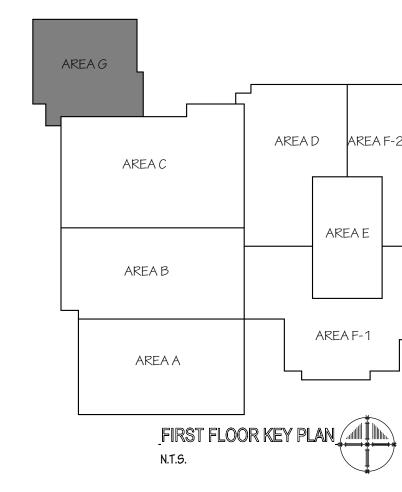

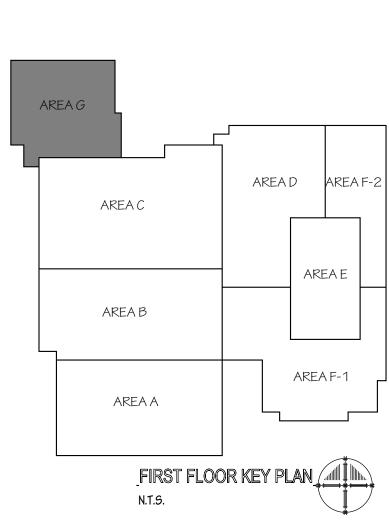

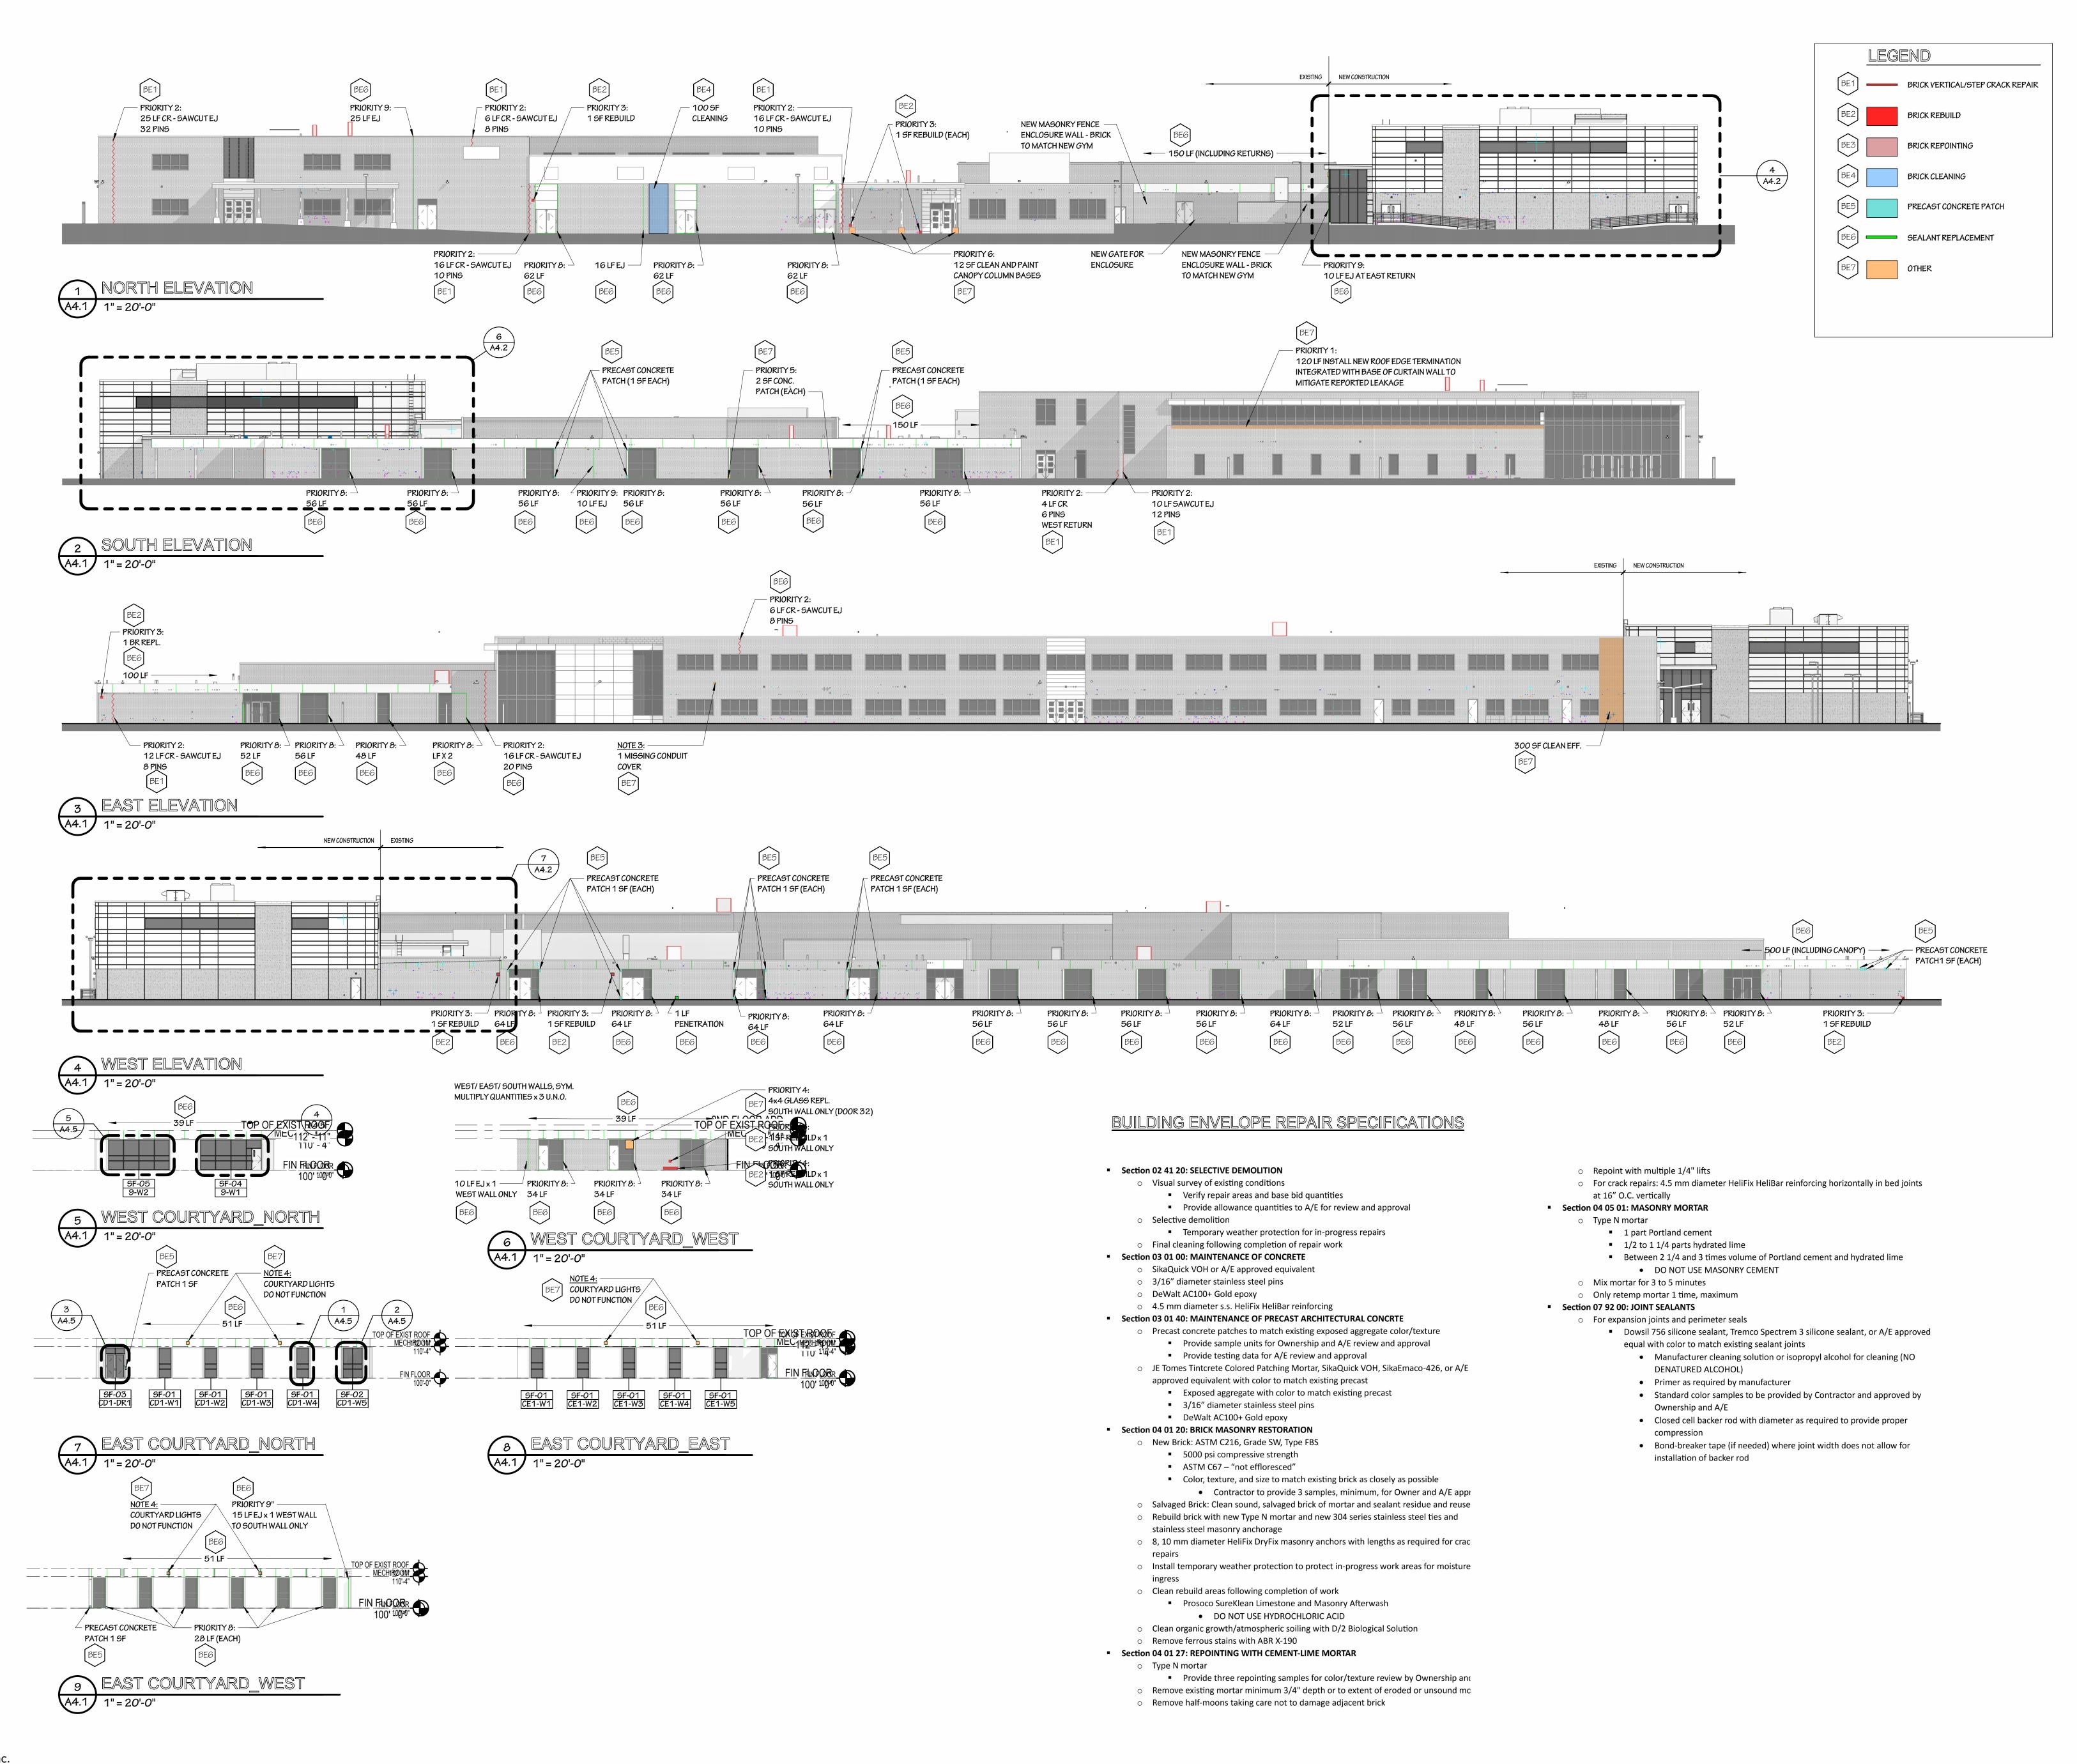



•

723.24.035

RAWN BY: CHECKED B'

01.09.2025

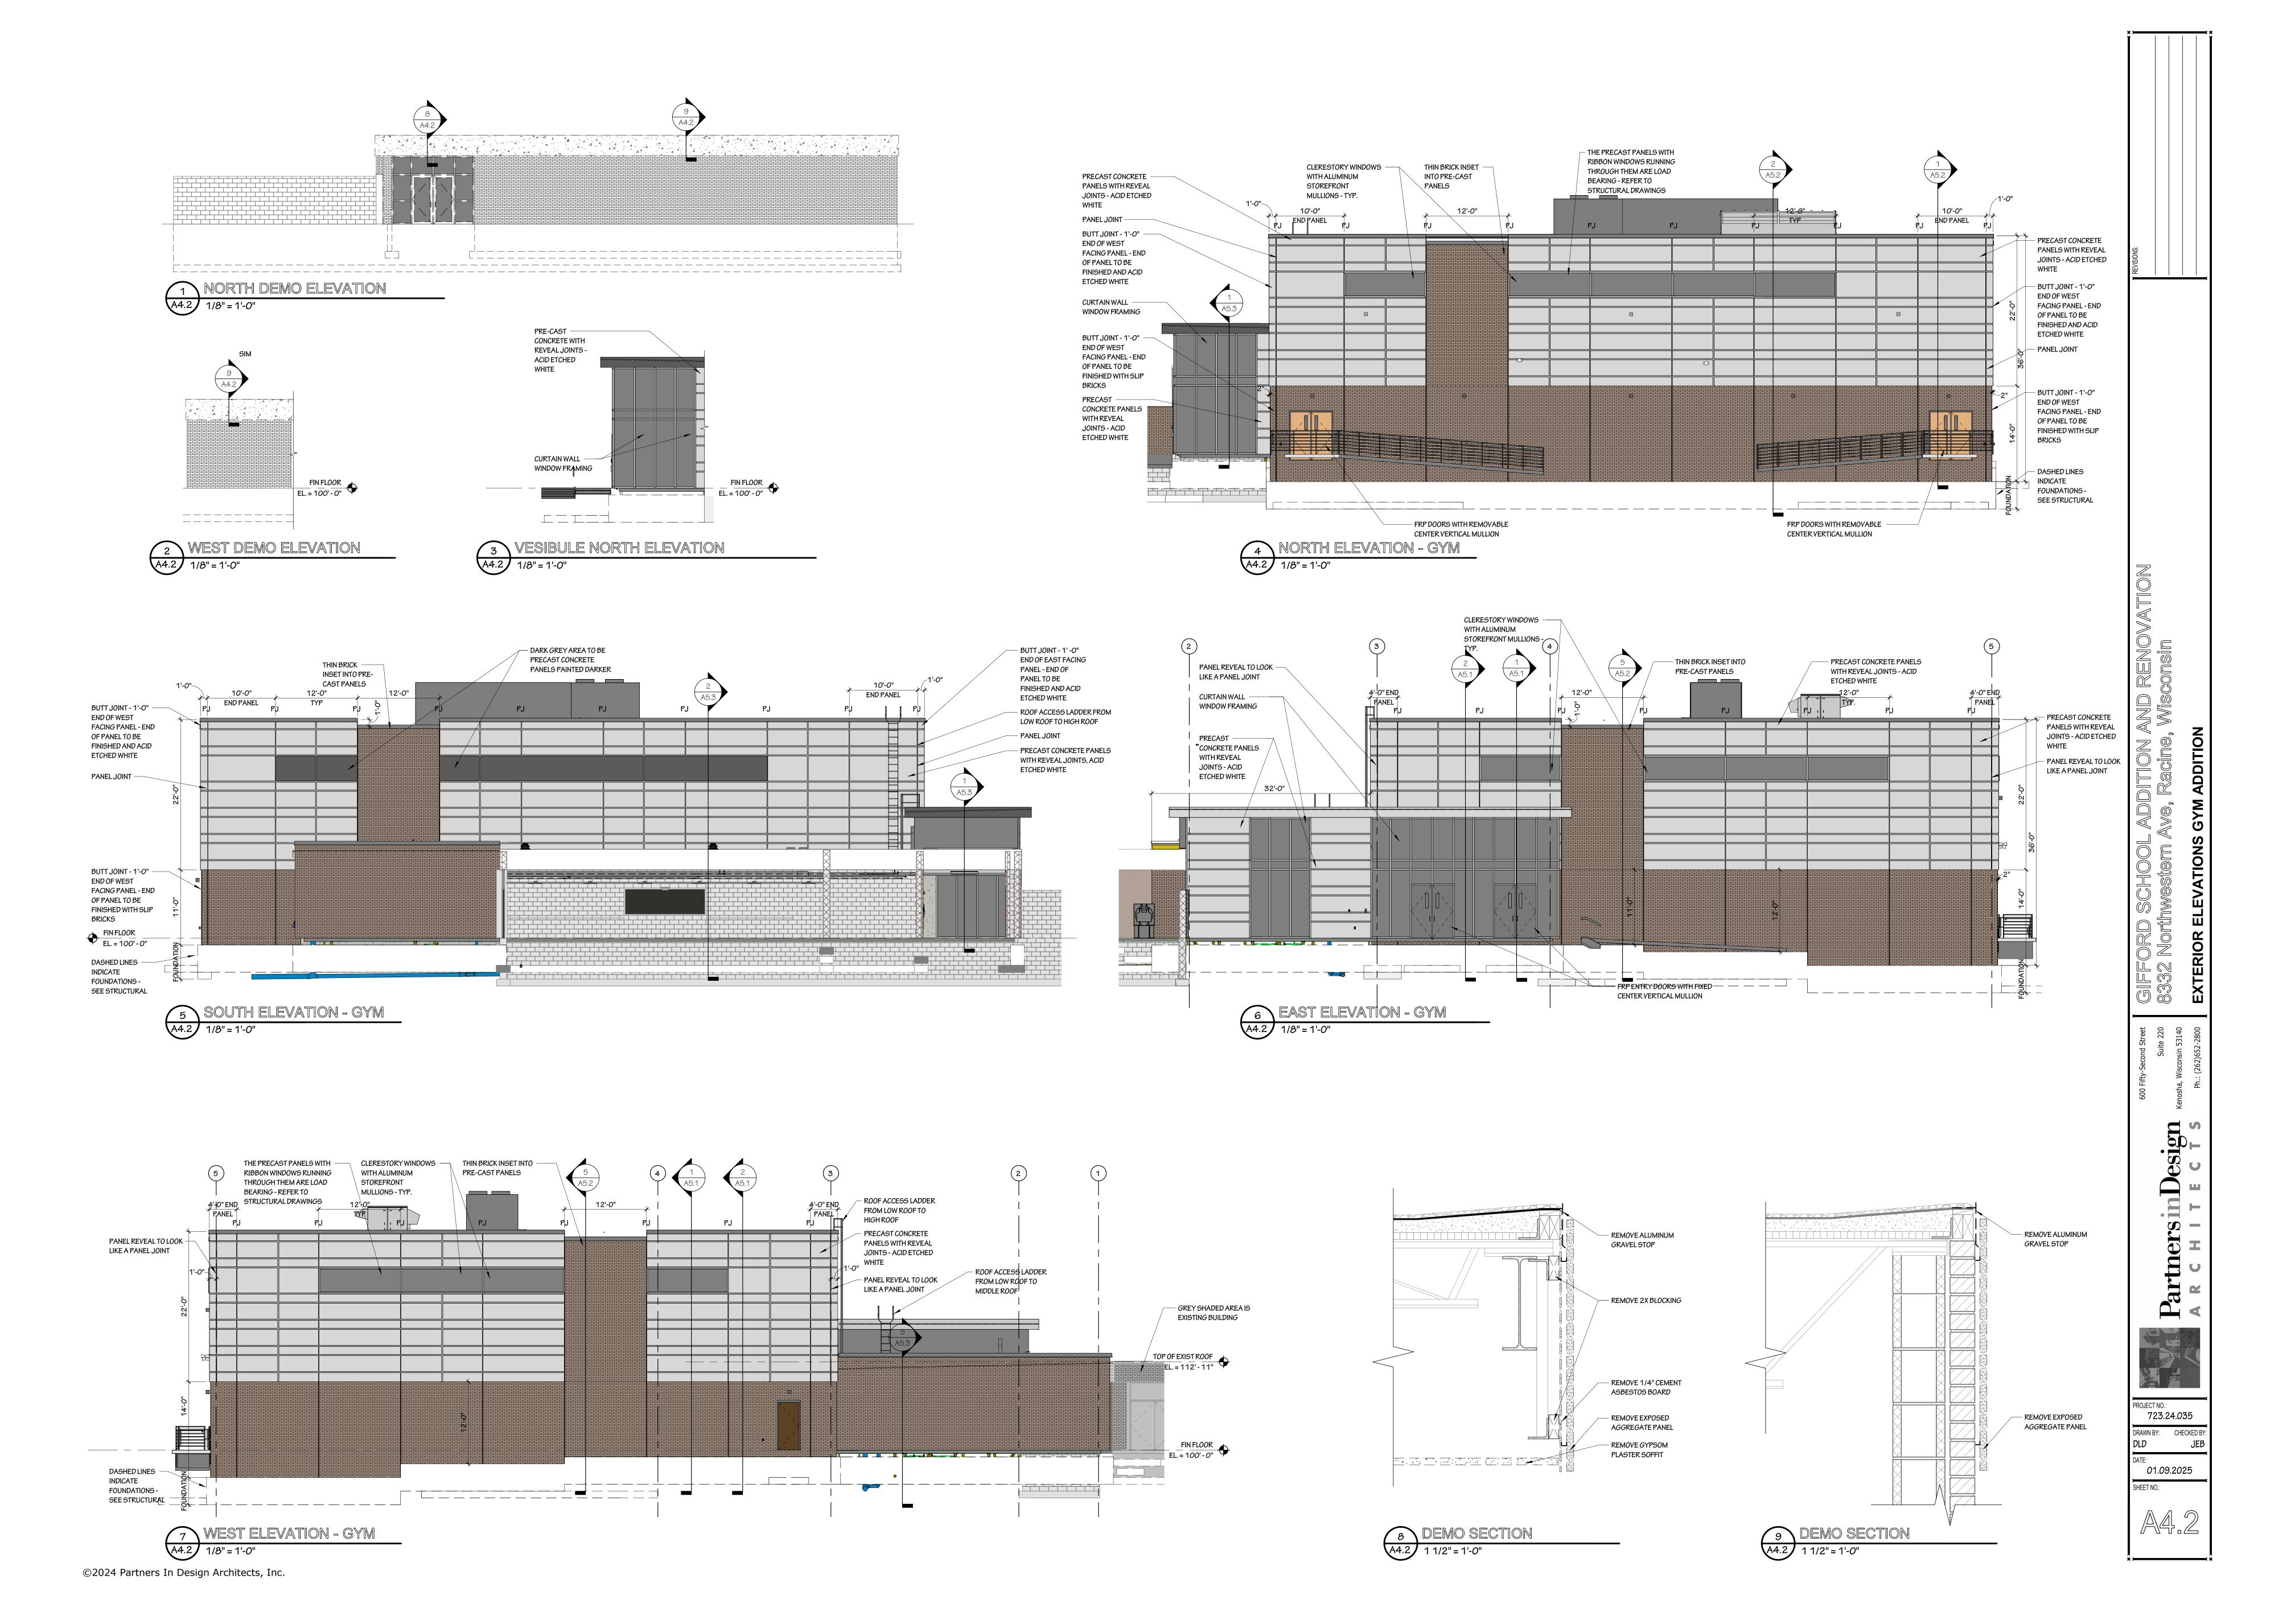

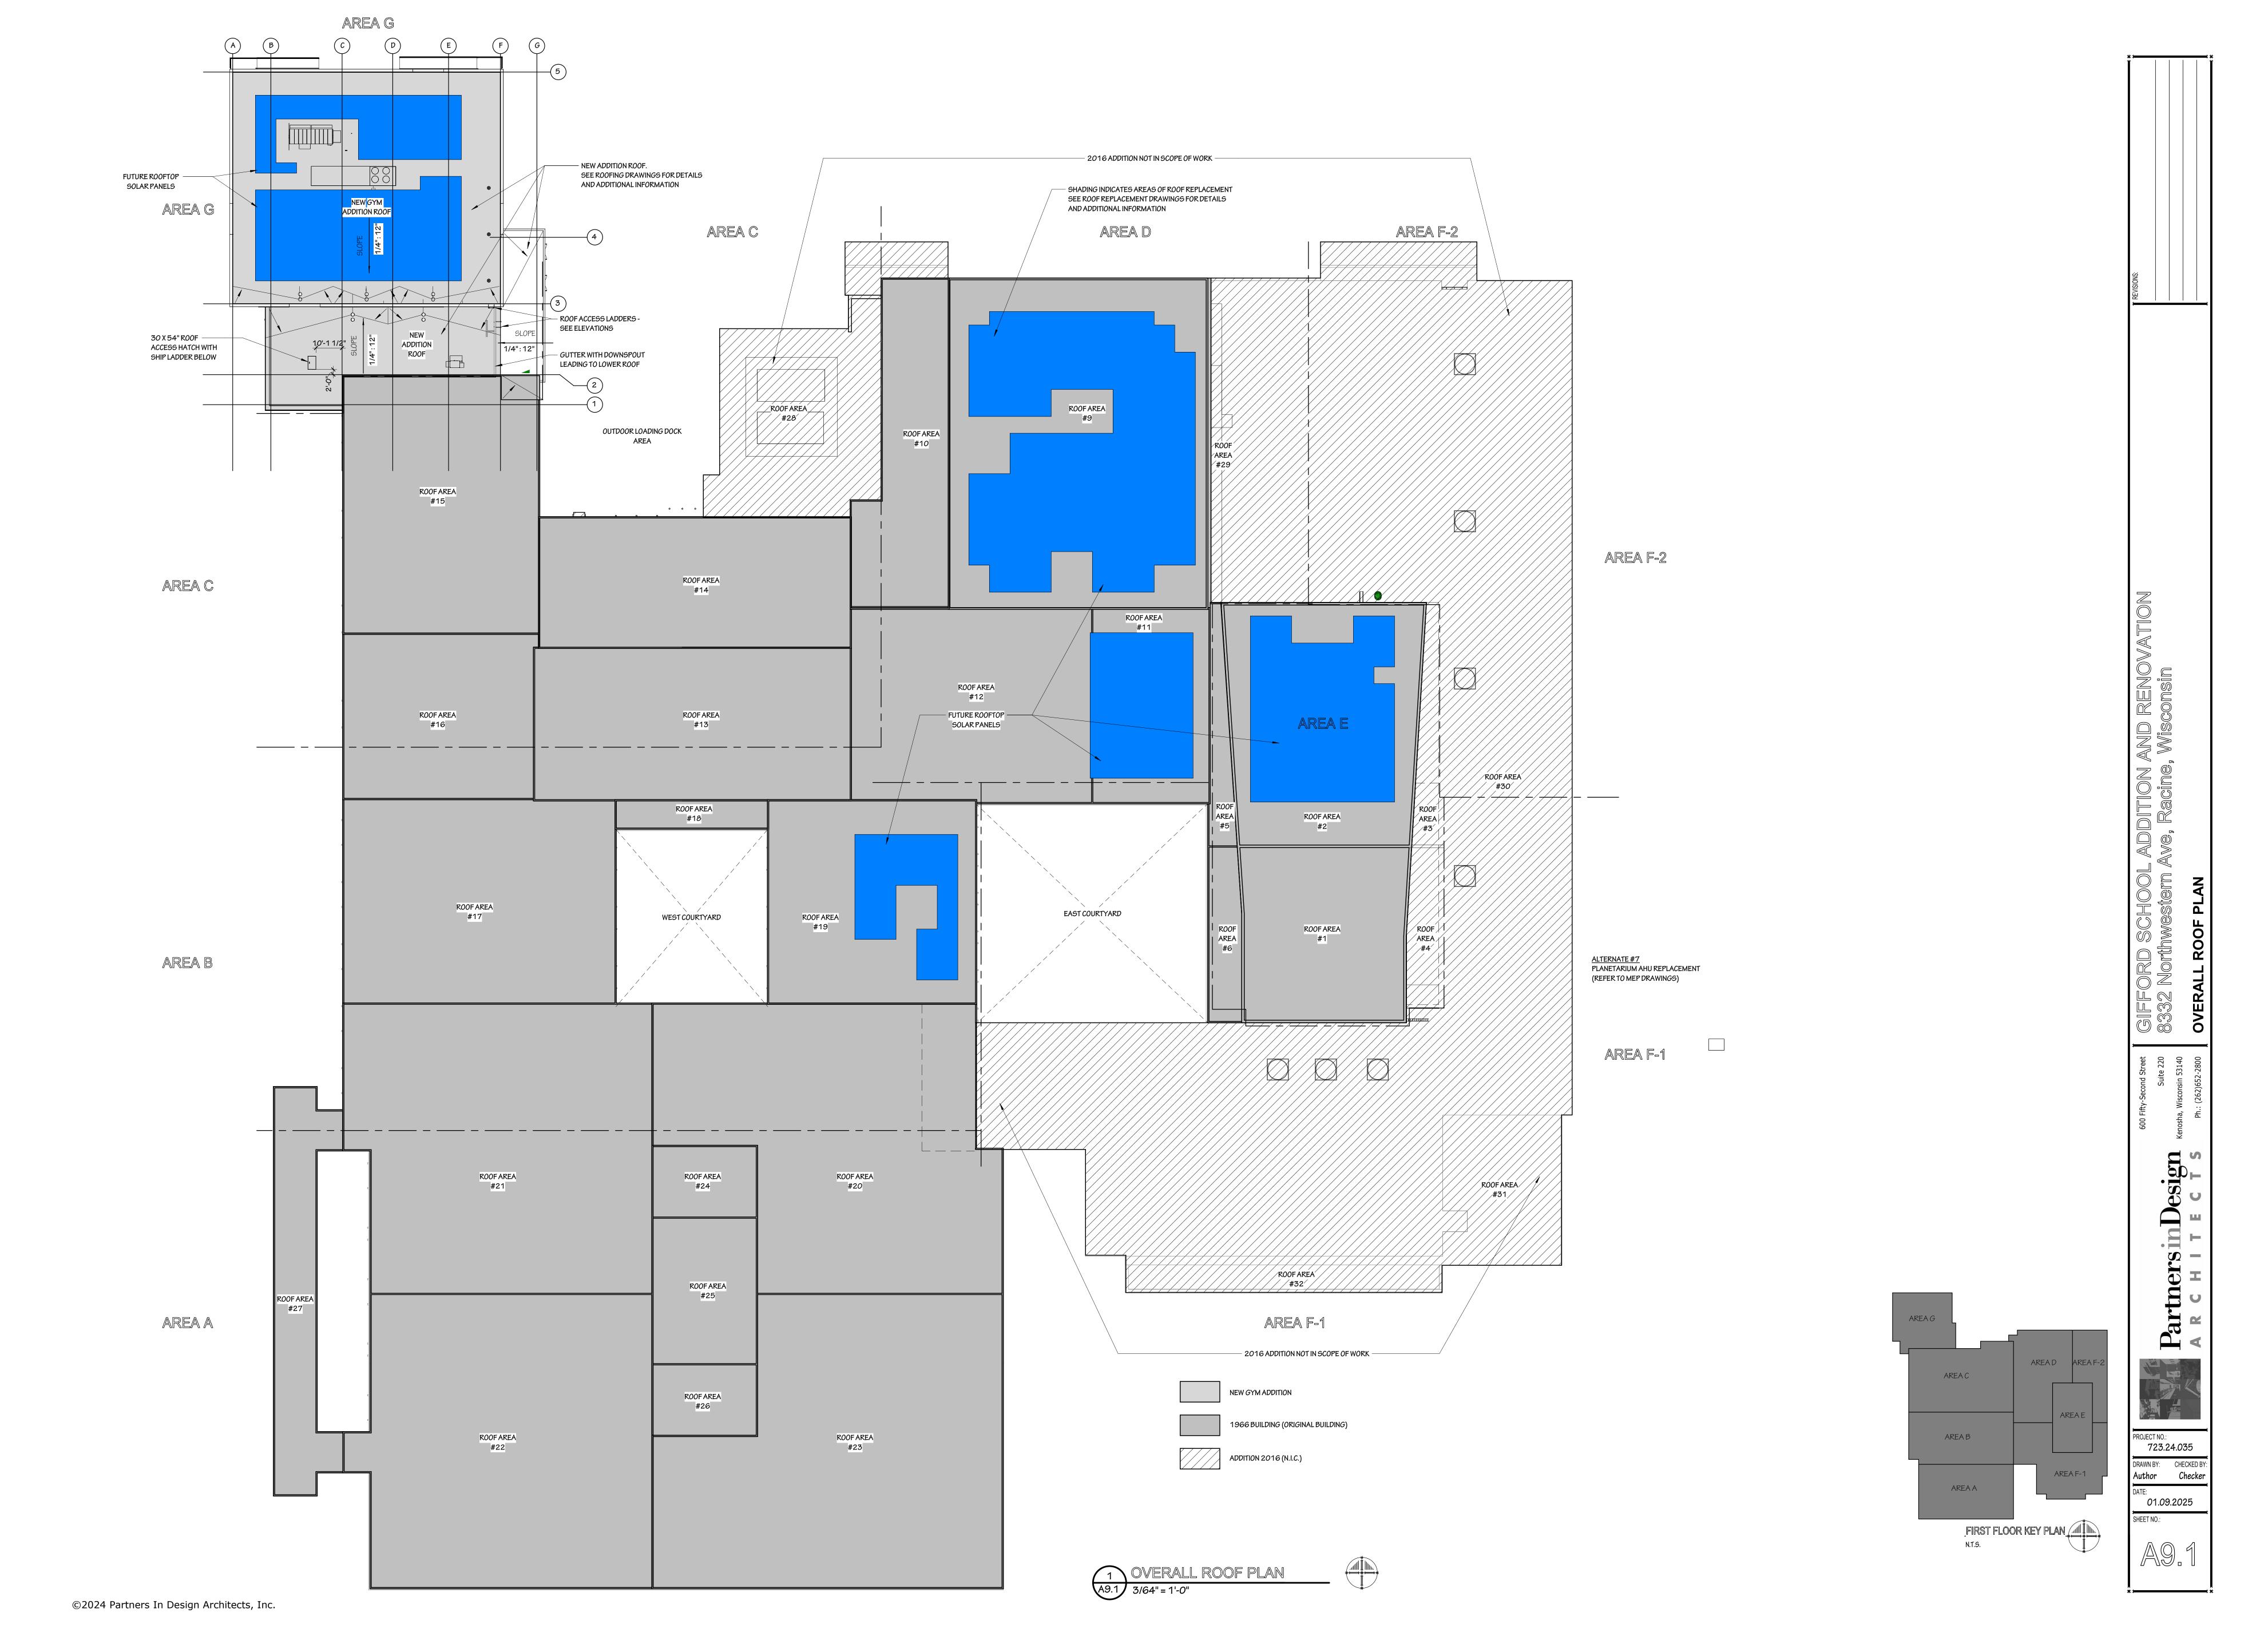



Date: 11/18/2024 Drawn By: KMO Checked By: Sheet Name:

LIGHTING SITE PLAN

Calculation Summary OVERALL SITE_GROUND 11.7 PROPERTY LINE 1.20 3.4 0.3

NEW DRIVEWAY

\$\frac{1}{2} \frac{1}{2} \frac to be EXISTING BUILDING to \$\frac{1}{2}\frac{1}{2 to be to to be set of set to be to bollot of the bollot of of of of ot of object of the bollot of \tag{bo} \ta to be to be post of the properties and the properties are the properties and the properties are the properties and the properties are the properti to be be derived by the second of the second to be to to to to to to to od od 10 bo 10 bo 00 od to be defined as a second of the second of t of all of be to be decided as the state of the state o and an analysis of an analysis of the second and the description of the descr to be be be to be and the transfer of the total and the transfer of the transfer to be and so to do so do to be \$\dots & \dots a do so at 0. The set of of of a first of a \$\bar{c}{0}\$ \tau_{0}\$ \ta \$\bar{a}\$ \bar{b}\$ \bar{a}\$ \bar{a}\$ \bar{a}\$ \bar{b}\$ \bar{a}\$ \b 80 80 80 80 80 80 80 80 80 80 80 80 0 0 0 0 0 0 0 0 0 0 0 0 0 0 0 0 0 0 ADDITION QDAs. 5.3 5.1 5.1 5.0 \$\infty \tau \frac{1}{10} ODA\$0 b3 b.1 b.1 b.0 to b0 b0 b0 b0 b0 MH: 17.600 29 00 00 00 00 00 00 00 \[\frac{1}{2} \fr MH₂17.600 i dio in to the contract of th to be \$\frac{1}{2}\text{bo} \text{bo} \tex X-MTR Location to to to \$\begin{align*}
\begin{align*}
\begi LIGHTING SITE PLAN - SOUTH LIGHTING SITE PLAN - NORTH Scale: 1 inch= 40 Ft. Scale: 1 inch= 40 Ft.

bo to to to to to to

The state of the s

MATCHLINE to be to

0.0 0.0 0.0 0.0 0.0 0.0 0.0

Luminaire Scl	nedule				
Symbol	Tag	Label	Description	Lum. Lumens	LLF
\rightarrow	EXOA	ARE-EDG-4MB10-E-UL-350-40_2_1	ARE-EDG-4MB10-E-UL-350-40K (350mA)	7940	0.900
			CONFIGURED FROM ARE-EDG-4MB-DA-12-E-		
(4)	ODA	LDN6 40_15 LO6AR LSS	LDN6 40_15 LO6AR LSS	1518	0.900
→	OWA	WDGE2 LED P3 40K 80CRI VF_1	WDGE2 LED P3 40K 80CRI VF	3133	0.900
+	OWB	WDGE2 LED P3 40K 80CRI TFTM_1	WDGE2 LED P3 40K 80CRI TFTM	3166	0.900
→	OWC	WDGE2 LED P4 40K 80CRI T1S	WDGE2 LED P4 40K 80CRI T1S	4100	0.900