CITY OF WASHBURN 119 Washington Avenue P.O. Box 638 Washburn, WI 54891



715-373-6160 715-373-6161 FAX 715-373-6148

CITY OF WASHBURN NOTICE OF PUBLIC HEARING

A Public Hearing will be held by the Plan Commission on, Thursday, May 16, 2024 at 5:30 P.M. at City Hall, 119 Washington Avenue, for public comment on the following issue:

Conditional Use Permit Application:

Request for Expansion of Indoor Boat Storage Building in the (M) Marina Zone – To construct at 5,250 square foot expansion of the existing structure located at 75 Marina Drive. Madeline Island Water Co., Inc., Petitioner

The property (Tax ID 32606) is zoned M - Marina. Residents unable to attend the public hearing may provide written comment to the Zoning Administrator prior to the hearing.

Scott J. Kluver Zoning Administrator

As required by ordinance, copy mailed to property owners within 150 feet of the subject property.

NOTICES MAILED FIRST CLASS MAIL 04/24/2024

AMERICAN HOTEL ASSOCIATION LLC 2052 85TH AVE DRESSER, WI 54009

WWS LLC 7490 NORTH ROAD EAU CLAIRE, W, 54701 **WASHBURN MARINA** PO BOX 482 WASHBURN, WI 54891

The City of Washburn is an equal opportunity provider, employer, and lender.

CITY OF WASHBURN CONDITIONAL USE PERMIT

A Conditional Use Permit is hereby granted, pursuant to Title 13, Chapter 1, Article 7, Division 3 of the City of Washburn Zoning Ordinance to Madeline Island Water Co. Inc. (hereinafter User), in respect to property currently zoned M- Marina, herein referred to as Subject Property, described as:

Street Address:

75 Marina Drive

Legal Description: PAR IN LOT 5 CSM V.3 P.240; V.638 P.22 & PAR LOT 5 CSM V.3

P.240 & PAR LOT 7 CSM V.3 P.243 V.420 P.50 BOTH LOCATED IN

GOVT LOTS 1 & 2

Tax ID:

32606

PIN:

04-291-2-48-04-05-1 05-001-10000

This Conditional Use Permit is granted for the purpose of permitting the User, and only the User, to engage in the permitted use set forth immediately below:

1. To expand and operate an indoor boat storage facility located at 75 Marina Drive, in the M - Marina in accordance with Section 13-1-8-452 of the City of Washburn Zoning Code.

This Conditional Use Permit is subject to the following special conditions:

- 1. This Conditional Use Permit is issued exclusively to the User, does not run with the land for which it is issued, and may not be sold, conveyed, assigned or otherwise transferred to any other person or entity. This permit will be effective once all conditions are complied with as specified in ordinance.
- 2. Issuance of a Conditional Use Permit does not indicate that the City of Washburn has certified the above referenced dwelling nor has it inspected the building, nor does it ensure that it meets local, state, federal, or professional requirements or standards related to the subject use.
- 3. The User must comply with Title 8, Chapter 3 of the City of Washburn ordinances regarding the placement and use of waste and recycling facilities.
- 4. All conditional uses referred to above may be carried out upon the Subject Property during times that are allowable by the City's noise ordinance (11-2-6).
- 5. This permit shall remain in effect so long as the permit holder complies with all conditions of this permit and applicable City of Washburn ordinances.

CUP Madeline Island Water Co. Inc Draft 050624 - Page 1

Statement on the nature of the approval:

In approving this Conditional Use Permit, the Plan Commission confirmed the size of the parcel was not an issue, the use is compatible, the location of the use on the property is not a concern, traffic safety should not be a problem, it is a suitable additional use, there are no negative impacts on the environment known of, concerns with impacts on the neighbors were discussed and it would not impede the normal development. The Common Council adopts these findings.

Appeal rights for applicant and other aggrieved persons:

Within 30 days of the decis	ion date, a written	appeal, including the 1	easons for the	appeal, must be
received by the City Clerk.	The appeal process	s will follow the proced	ure outlined in	13-1-7-23 of the
zoning ordinance.		•		

David Dahlquist, Madeline Island Water Co	o. Inc.	Date
Personally came before me this and Personally came before me this to me known to be the person with the same.	day of who executed for the	, 2024, the above-named David foregoing instrument and acknowledge
Notary Public, Bayfield County, Wisconsin		
My commission expires:		
Mary D. Motiff, Mayor City of Washburn		Date
Personally came before me this da Motiff, known to be the person who execute	y of ed for the foregoing in	, 2024, the above-named Mary D. astrument and acknowledge the same.
Notary Public, Bayfield County, Wisconsin		
My commission expires:		
CUP Madeline Island Water Co. Inc Draft	: 050624 - Page 2	

Scott J. Kluver, Zoning Administrator City of Washburn	Date
Personally came before me this day Kluver, known to be the person who executed	y of, 2024, the above-named Scott J. d for the foregoing instrument and acknowledge the same.
Notary Public, Bayfield County, Wisconsin	
My commission expires:	

CUP Madeline Island Water Co. Inc Draft 050624 - Page 3



Office Use Only

Conditional Use City of Washburn

Version: May 25, 2017

WASHBURN CITY HALL 119 Washington Avenue Washburn, Wi 54891

Overview: The City's zoning code identifies land uses that may be allowed in each of the zoning districts either by right or as a conditional use. By definition, a conditional use is a land use that may or may not be appropriate on a given percel depending on a wide range of factors that relate to the proposed use and the particular circumstances relating to the percel end surrounding properties. Conditional uses are therefore considered on a case-by-case basis. The Plan Commission conducts a public hearing to solicit input from the general public and other interested parties. When reviewing conditional use applications, the Plan Commission serves in an advisory capacity to the Common Council, which makes the final decision. The recommendation of the Plan Commission and the decision of the Common Council are based on the evidence and testimony received as part of the application and through the public hearing process.

Governing regulations: The procedures and standards governing the review of this application are found in Article 7 of the City's zoning code.

General instructions: Complete this application and aubmit one copy to the City Clerk at the mailing address shown above. Before you formally submit your application, you may may meet with the City Administrator to review your application before it is formally submitted to determine if it is complete and provides enough information to describe the circumstances related to this application. If you have any questions, do not healtiste to contact the City Administrator at (715) 373-6160 ext.4 or via e-mail at washburnadmin@citvofwashburn.org.

L	Date Received:	Received By:	Fae Paid:	
7	Applicant and agent information, Example	Information include the names of the agent, if any, a include surveyors, angineers, landscape architects	, that helped prepere this application including the suppl r, architects, planners, and attorneys.	emental
		Applicant .	Agent	
	Name	TORGETTURE THOME	aterco. Greine	in Coust
		C/o Northlank ALUMINO	n bosocts Tuc	
	City, state, zip code	5005 county ROAL	2.5	
	Daytime telephone	ST. LOUIS PORK, M	103-241X	
	E-mail address	952-924-8526		
2	. Type of application (DAUIDBALQUISTO N	oppic ware .com	
7		aviously approved conditional use		
3.		be the proposed conditional use or amendment in d		
r			THE RESERVE OF THE PARTY OF THE	
	Seasona	al Boat STORAGE		
	A 70 feet wide b storage	y 75 foot deep expansion to the rear (r	northwest side) of an existing boat	
_				

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4. Subject property information	
Physical address 75 MARINA DRIVE	
Tax key number(s) 32606	
Note: The tax key number can be found on the tax bill for the property or it may be obtained from the City Clerk	
is the subject property currently in violation of the City's zoning code as determined by the zoning administrator?	
∑ No	
☐ Yes	
If yes, please explain,	
Comment: Pursuant to Section 6-10 of the City's zoning code, the City may not issue a permit or other approval that would benefit a parcel of that is in violation of the zoning code, except to correct the violation or as may be required by state law.	f land
Are there any unpaid taxes, easessments, or other required payment that are specifically related to the subject property?	
DEC No	
☐ Yes	
Myss, please explain.	
Comment: Pursuant to Section 6-11 of the City's zoning code, the City may not issue a permit or other approval that would benefit a percei of	lamet 1
where taxes, assessments, or other required payments are definquent and due,	EENO (
Are there any buildings on the subject property?	
Yea	
Will the proposed conditional use be located in an existing building or a new building?	
Districting building	
CK Proposed building NA	
If the conditional use will be in an existing building, is that building classified as "conforming" or "honconforming?" A nonconforming building does a mask the dimensional requirements for the district in which it is located.	not
Conforming building	
☐ Nonconforming building	
if nonconforming, please explain,	
See information at end of application	
Has the City approved a variance or special exception for the subject property? No	
∑ Yes	
If yes, provide the year of issuance and a short description for each one.	
The fact of Bengine Birth & State heartibrou M. State Oug.	\neg
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	a information. The subject	property is located in the following zoning district(s), (ch	hande all Shadanand A				
□ R-1 □ R-2 □ R-6	g mermanen, me subject Rural residential Suburban residential Mixed residential Waterfront residential	C-1 Cottage commercial C-2 General commercial C-3 Downtown commercial	MUW Mixed-use waterfront L-1 Lakefront M Merina I Industrial				
6. Adjoin	ding land uses and zoning						
[Zoning classification	Gurrant uses					
North	MARIN A	MARINA STORAGE					
South	N)	ц					
East	11	1.					
West	11	, 1					
The Ma pro eas	The proposed use is an expansion of an existing boat storage facility. The surrounding uses are zoned Marina or Mixed Use Waterfront which are compatible with the current and propose building. The property to the north (northeast) is similar boat storage facility. The users to the south (southwest) and east (southeast) are marina use and/or boat storage. The property to the north (northwest) is owned.						
The p	The location of the proposed use on the subject property (e.g., proximity of the proposed use to other existing or potential land uses) 75' Foot existing To Existing Stords building and property line. The existing building. It will be placed 8.9 feet from the south property line and 40.8 feet from the north property line. The existing buildings to the north is approximately 10 feet north of the property line providing 50.8 feet of separation between the buildings. The building is 64.8 feet setback from the rear property line which is vacant property owned by the city. The property to the east is Marina property owned by the city and has a 50 foot Ingress and Egress easement, The property to the south (southwest) is currently open space/outdoor boat storage which has a 50 foot drainage and utility easement that will limit construction of building within 50 feet of the south property line. Effects of the proposed use on traffic safety and efficiency and padestrian circulation, both on-site and off-site						

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Prince Condominium Association ###-####

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6. ·	The suitability	of the	subject	property	for t	he	brobosed	USE
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IDEAL

Article 8-Land Use, Exhibit 81- Land-Use Matrix in heading 14-General Storage subpart 14.02 Indoor Boat Storage is allowed as a Conditional Use in the Marina zoning district.

6. Effects of the proposed use on the natural environment

None

The grading limits for the project disturbs 0.30 acres of the site. The building is being designed with foundation walls from finished floor to close to existing grade to minimize disturbance to the site and surrounding areas. The tree removal is limited to one 6" tree and some brush.

The impervious area of the site will increase by 0.12 acres. After the project there will be approximately 0.28 acres of impervious surface or approximately 41% of the site and 59% of the site remaining as open space.

7. Effects of the proposed use on surrounding properties, including operational considerations relating to hours of operation and creation of potential nulsances

ALGOCENTO OTHER SEASOND (DA STOUGLE GUILLINGS)

 Effects of the proposed use on the normal and orderly development and improvement of the surrounding property for uses permitted in the zoning district and adjoining districts

NOWY

9. Any other factor not listed above, but which relates to the public heelth, safety, or welfare

NOWY

Section 4 - Variance Conditions:

The required side yard setback is 10 feet. The southwest side of the existing building was constructed at approximately 8.8 feet from the property line. It is proposed to connect to the existing building corner (not jog it 1.2 feet) to maintain a uniform building. Therefore, the new building would require a 1.2 foot setback variance for the southwest side. On the adjoining property there a watermain and utility easement that would prevent an adjoining building being built within 50 feet of the southwest property line.

The required front setback is 25 feet. The existing building is setback 1.4 feet. There is an existing 50 foot Ingress and Egress easement in front of the building located on City of Washburn property. Therefore, the building has adequate access and meets the intent of the zoning code. The front of the existing building also aligns with the two other buildings to the northeast.

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8.	Project map. Attach a project map. It can consist of a single page of multiple pages depending on the complexity of the features that need to be depicted.				
	The following items need to be included as appropriate to the project. Background Project Information Project name Applicant name Preparation date Burvey information North errow and graphic scale Address of subject property or legal description Property boundaries Acreage of subject property Project Development information Easements/rights-of-ways (location, width, purpose, ownership) Common areas/conservancy areas (location, purpose, ownership) Setting Property boundaries within 150 feet of the subject property Land uses within 150 feet of the subject property Zoning district boundaries within 150 feet of the subject property Municipal boundaries within 150 feet of the subject property Municipal boundaries within 150 feet of the subject property Site Features (existing and proposed) Ground contours when any slope exceeds 10 percent Wetlands Woodjands Widlife habitst, including critical wildlife habitat Environmentally sensitive features Water resources (rivers, ponds, etc.) Floodplain boundaries Environmental and manmade development constraints and hazards including brownlisds, contaminated altes, unstable solls, high groundwater, bedrock, and high-pressure natural gas lines	Landscaping Features (existing and proposed) Fences, buffers, and berms Pervious and impervious surfaces by type Existing trees and other prominent vegetation Transportation Facilities (existing and proposed) Streets Driveways and road access onto public and private roads Sidewalks / trails Buildings and Outdoor Storage/Activity Areas footprint, use, atc.) Existing and proposed Existing within 150 feet of subject property Required Satbacks Yand setbacks Yand setbacks (front, alde, rear and shore) On-site septic systems On-site wells and off-site wells within 10 feet of the parimeter of the subject property			
10.	Attachments. List any attachments included with your application. Other Information. You may provide any other information you feel is rele	evant to the review of your application.			

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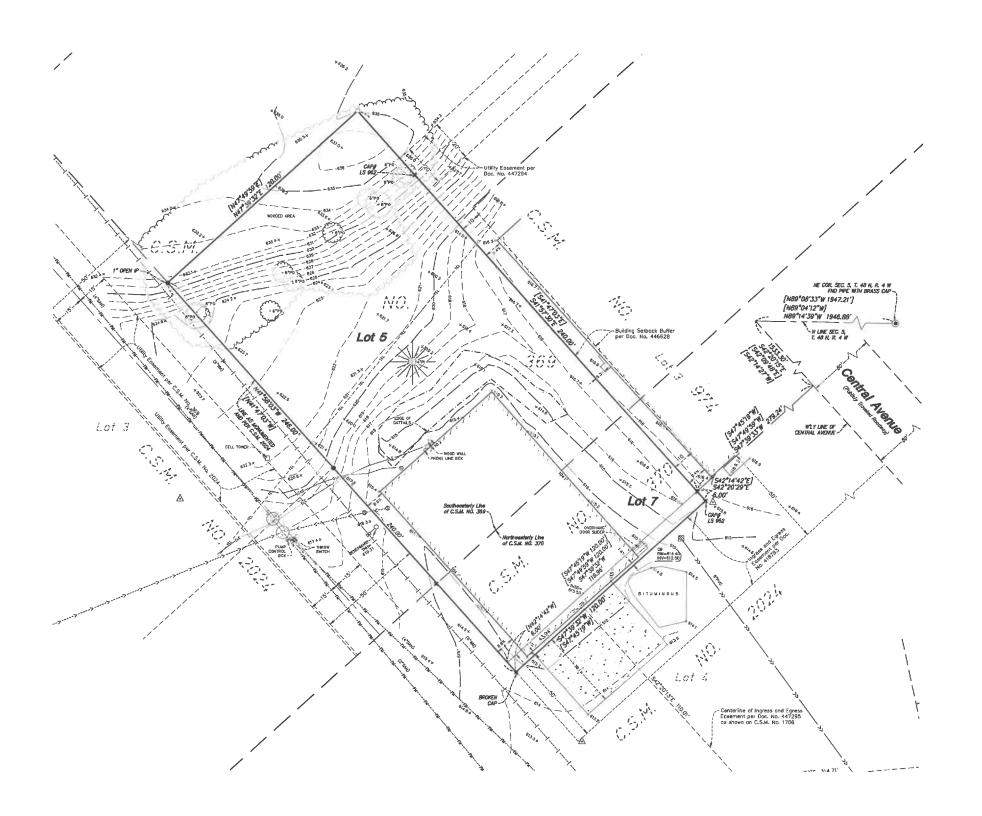
Prince Condominium Association ### #####

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11. Applicant certification

- . I certify that all of the information in this application, along with any attachments, ere true and correct to the best of my knowledge and belief.
- I understand that submission of this application authorizes dity officials, Plan Commission members, Common Council members, employees, and
 other designated agents to enter the property to conduct whatever site investigations are necessary to review this application. This does not
 authorize any such individual to enter any building on the subject property, unless such inspection is specifically related to the review of this
 application and the property owner gives his or har permission to do so.
- I understand that this application and any written materials relating to this application will become a permanent public record and that by aubmitting this application I ecknowledge that I have no right to confidentiality. Any person has the right to obtain copies of such written materials or view it online.
- I understand that the zoning administrator will review this application to determine if it contains all of the required information. If he or she determines that the application is incomplete, it will not be acheduled for review until it is deemed to be complete.

Property Symar Signature(s): 4-11-2024





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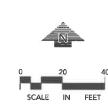
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Checked By	
Review Date	02/27/2
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C1-1 EXISTING CONDITIONS
C2-1 SITE AND UTILITY PLAN
C3-1 GRADING AND EROSION PLAN





SITE NOTES

- ALL PAVING, CONCRETE CLIRB, GUTTER AND SIDEWALK SHALL BE FURNISHED AND INSTALLED IN ACCORDANCE WITH THE DETAILS SHOWN PER THE DETAIL SHEET(S) AND APPLICABLE GOVERNING AGENCY REQUIREMENTS.
- ACCESSIBLE PARKING AND ACCESSIBLE ROUTES SHALL BE PROVIDED PER CURRENT ADA STANDARDS AND APPLICABLE GOVERNING AGENCY REQUIREMENTS.
- 3. ALL CURB DIMENSIONS SHOWN ARE TO THE FACE OF CURB UNLESS OTHERWISE NOTED.
- 4. ALL BUILDING DIMENSIONS ARE TO THE OUTSIDE FACE OF WALL UNLESS OTHERWISE NOTED.
- BITUMINOUS IMPREGNATED FIBER BOARD TO BE PLACED AT FULL DEPTH OF CONCRETE ADJACENT TO EXISTING STRUCTURES AND BEHIND CURB ADJACENT TO DRIVEWAYS AND SIDEWALKS.
- 6. SEE SITE ELECTRICAL PLAN FOR SITE LIGHTING.
- REFER TO THE GEOTECHNICAL REPORT PREPARED BY BRAUN INTERTEC, DATED JANUARY 12TH, 2024 FOR AN EXISTING SUBSURFACE SITE CONDITION ANALYSIS AND CONSTRUCTION RECOMMENDATIONS INCLUDING BUT NOT LIMITED TO PAVEMENTS AND EXTERIOR SLABS.

SITE DATA

CURRENT ZONING: MARINA (M)
PROPOSED ZONING: MARINA (M)

 PROPERTY AREA (GROSS):
 0.68 ± AC

 RIGHT OF WAY AREA:
 0.68 ± AC


 MIN. FRONT LOT SETBACK:
 25 FT

 MIN. SIDE LOT SETBACK:
 10 FT

 MIN. BACK LOT SETBACK:
 25 FT

DISTURBED AREA: ± AC
EXISTING IMPERVIOUS AREA: 0.17 ± AC (25%)*
PROPOSED IMPERVIOUS AREA: 0.28 ± AC (41%)*

*IMPERVIOUS AREAS BASED ON DISTURBED AREA ONLY

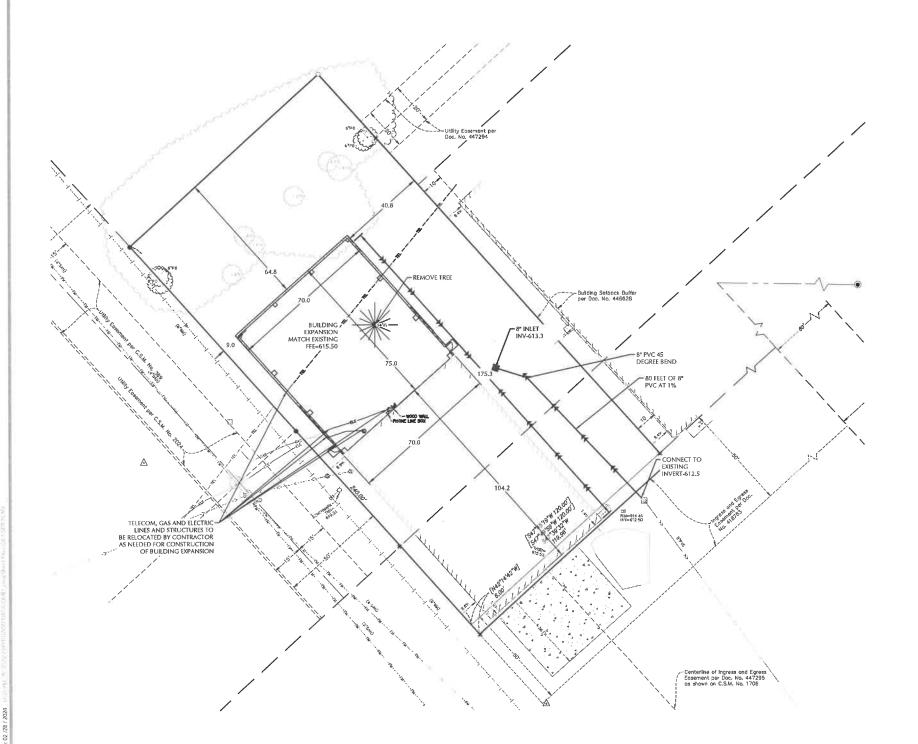





Loucks

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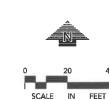
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Project Lead	JAS
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Checked By	JAS
Review Date	02/27/2024
	SHEET INDEX

C1-1 EXISTING CONDITIONS C2-1 SITE AND UTILITY PLAN C3-1 GRADING AND EROSION PLAN





GRADING, DRAINAGE & EROSION CONTROL NOTES

- SPOT ELEVATIONS REPRESENT FINISHED SURFACE GRADES, GUTTER/FLOW LINE, FACE OF BUILDING, OR EDGE
 OF PAVEMENT UNLESS OTHERWISE NOTED.
- ALL ACCESSIBLE ROUTES SHALL BE CONSTRUCTED WITH A CROSS SLOPE NOT EXCEEDING 2% AND A RUNNING SLOPE NOT EXCEEDING 5%.
- AT TURNING POINTS ALONG THE ACCESSIBLE ROUTE THE PAVEMENT SHALL NOT EXCEED 2% IN ANY DIRECTION FOR AN AREA 60° IN DIAMETER.
- ALL PUBLIC SIDÉWALKS SHALL BE CONSTRUCTED WITH A CROSS SLOPE NOT EXCEEDING 2% AND A RUNNING SLOPE NOT EXCEEDING 5%.
- CATCH BASINS AND MANHOLES IN PAVED AREAS SHALL BE SUMPED 0.04 FEET. ALL CATCH BASINS IN GUTTERS SHALL BE SUMPED 0.16 FEET. RIM ELEVATIONS SHOWN ON PLANS DO NOT REFLECT SUMPED
- EXISTING SOILS ARE ASSUMED TO BE COARSE-GRAINED SOILS (GW, GP, GM, GC, SW, SP, SM, SC) PER THE UNIFIED SOIL CLASSIFICATION. CONTRACTOR TO NOTIFY ENGINEER IF EXISTING CONDITIONS DIFFER FROM ASSUMED SOIL CONDITIONS.
- GRADING, INCLUDING BUT NOT LIMITED TO EXCAVATION AND BACKFILL, OF THE INFILTRATION AREA(S)
 SHALL BE ACCOMPLISHED USING LOW-IMPACT EARTH-MOVING EQUIPMENT TO PREVENT COMPACTION OF
 THE UNDERLYING SOILS. SMALL TRACKED DOZERS AND BOBCATS WITH RUNNER TRACKS ARE
 RECOMMENDED. NO WHERLED MACHINES SHALL BE USED.
- SOIL BENEATH THE INFILTRATION AREA(S) SHALL BE RIPPED WITH A TOOTHED BUCKET TO REMOVE SOIL INTERFACE PRIOR TO BACKFILL.
- 10. A FLOOD TEST OR DOUBLE RING INFILTROMETER TEST SHALL BE COMPLETED FOR THE INFILTRATION SYSTEM TO VERIFY INFILTRATION RATES ARE WITHIN THE ACCEPTABLE RANGE OF X.X IN/HR TO X.X IN/HR.
- 11. CITY AND WATERSHED SHALL BE NOTIFIED AT LEAST 24 HOURS PRIOR TO CONSTRUCTION OF STORMWATER RMPS
- 12. ALL DISTURBED UNPAYED AREAS ARE TO RECEIVE MINIMUM OF 4 INCHES OF TOP SOIL AND SEED/MULCH OR SOD. THESE AREAS SHALL BE WATERED/MAINTAINED BY THE CONTRACTOR UNTIL VECETATION IS ESTABLISHED. REFER TO THE LANDSCAPE PLANS, DETAILS AND SPECIFICATIONS FOR FINAL SITE STABILIZATION.

- 13. FOR SITE RETAINING WALLS "TW" EQUALS SURFACE GRADE AT TOP FACE OF WALL (NOT TOP OF WALL), "GW" EQUALS SURFACE GRADE AT WALL GRADE TRANSITION, AND "BW" EQUALS SURFACE GRADE AT BOTTOM FACE OF WALL NOT BOTTOM OF BURIED WALL COURSES).
- 14. FOR SITE STAIRS, "TS" EQUALS SURFACE ELEVATION AT TOP OF STAIRS AND "BS" EQUALS SURFACE ELEVATION AT BOTTOM OF STAIRS. REFER TO SITE PLAN FOR NUMBER OF RISERS AND RISER HEIGHT.
- 15. STREETS MUST BE CLEANED AND SWEPT WHENEVER TRACKING OF SEDIMENTS OCCURS AND BEFORE SITES ARE LEFT IDLE FOR WEEKENDS AND HOLIDAYS. A REGULAR SWEEPING SCHEDULE MUST BE ESTABLISHED.
- 16. DUST MUST BE ADEQUATELY CONTROLLED.
- 17. SEE SWPPP FOR ADDITIONAL EROSION CONTROL NOTES AND REQUIREMENTS.
- 18. SEE UTILITY PLAN FOR WATERMAIN, STORM SEWER, AND SANITARY SEWER INFORMATION.
- 19. SEE SITE PLAN FOR CURB AND BITUMINOUS TAPER LOCATIONS.
- 20. REFERENCE ARCHITECTURAL AND STRUCTURAL DRAWINGS FOR BUILDING ELEVATIONS.
- 21. THE CONTRACTOR ALONG WITH THE OWNER SHALL OBTAIN ALL NECESSARY PERMITS AND APPROVALS FROM GOVERNING AUTHORITIES, INCLUDING ANY CITY PERMITS AND THE NPDES PERMIT.
- 22. INSTALL EROSION CONTROL AND TREE PROTECTION MEASURES BEFORE BEGINNING SITE GRADING ACTIVITIES. SOME EROSION CONTROLS SUCH AS BALE CHECKS AND TEMPORARY SILT PONDS MAY BE INSTALLED AS GRADING OCCURS IN SPECIFIC AREA. MAINTAIN EROSION CONTROLS THROUGHOUT THE GRADING PROCESS AND REMOVE WHEN TURF HAS BEEN ESTABLISHED.
- 23. PER NATIONAL POLLUTANT DISCHARGE ELIMINATION SYSTEM/STATE DISPOSAL SYSTEM (NPDES/SDS)
 REQUIREMENTS, THE WASHOUT AND CLEANOUT OF STUCCO, PAINT, CONCRETE, FORM RIELEAS CILS,
 CURNING COMPOUNDS, AND OTHER CONSTRUCTION MATERIALS SHALL BE PROPERLY CONTAINED AND
 DISPOSED OF. THE CONTRACTOR SHALL BE RESPONSIBLE FOR PROVIDING AND USING APPROVED METHODS
 OF CONTRINMENT SUCH AS PRE-ABBICATED WASHOUT CONTAINERS, CONCRETE WASHOUT TOTE, READY
 MIX TRUCKS WITH SELF-CONTAINED CHUTE CLEANOUT, ETC.
- 24. CONTRACTOR SHALL PROVIDE AS-BUILT INFORMATION OF GRADING ACTIVITIES AS NEEDED PER APPLICABLE PERMIT REQUIREMENTS AND/OR DEVELOPMENT AGREEMENTS.

GENERAL LANDSCAPING NOTES

CONTRACTOR SHALL VISIT SITE PRIOR TO SUBMITTING BID. HE SHALL INSPECT SITE AND BECOME FAMILIAR WITH EXISTING CONDITIONS RELATING TO THE NATURE AND SCOPE OF WORK.

VERIFY LAYOUT AND ANY DIMENSIONS SHOWN AND BRING TO THE ATTENTION OF THE LANDSCAPE ARCHITECT ANY DISCREPANCIES WHICH MAY COMPROMISE THE DESIGN AND / OR INTENT OF THE PROJECT'S LAYOUT.


ASSURE COMPLIANCE WITH ALL APPLICABLE CODES AND REGULATIONS GOVERNING THE WORK OR MATERIALS SUPPLIED.

CONTRACTOR SHALL PROTECT ALL EXISTING ROADS, CURBS / GUTTERS, TRAILS, TREES, LAWNS AND SITE ELEMENTS DURING PLANTING OPERATIONS. ANY DAMAGE TO SAME SHALL BE REPAIRED AT NO COST TO THE OWNER.

CONTRACTOR SHALL VERIFY ALIGNMENT AND LOCATION OF ALL UNDERGROUND AND ABOVE GRADE UTILITIES, CONTRACTOR TO PROVIDE THE NECESSARY PROTECTION FOR THE UTILITIES BEFORE CONSTRUCTION / MATERIAL INSTALLATION BEGINS. CONTRACTOR TO NOTIFY GENERAL CONTRACTOR OF ANY CONCERNS PRIOR TO INSTALLATION OF PLANTINGS.

EXISTING CONTOURS, TRAILS, VEGETATION, CURB / GUTTER AND OTHER EXISTING ELEMENTS BASED UPON INFORMATION SUPPLIED TO IANDSCAPE ARCHITECT BY OTHERS. CONTRACTOR SHALL VERIFY ANY AND ALL DISCREPANCIES PRIOR TO CONSTRUCTION AND NOTIFY LANDSCAPE ARCHITECT OF ANY AND ALL DISCREPANCIES PRIOR TO CONSTRUCTION AND NOTIFY LANDSCAPE ARCHITECT OF

THE ALIGNMENT AND GRADES OF THE PROPOSED WALKS, TRAILS AND / OR ROADWAYS ARE SUBJECT TO FIELD ADJUSTMENT REQUIRED TO CONFORM TO LOCALIZED TOPOGRAPHIC CONDITIONS AND TO MINIMIZE TREE REMOVAL AND GRADING. ANY CHANGE IN ALIGNMENT MUST BE APPROVED BY

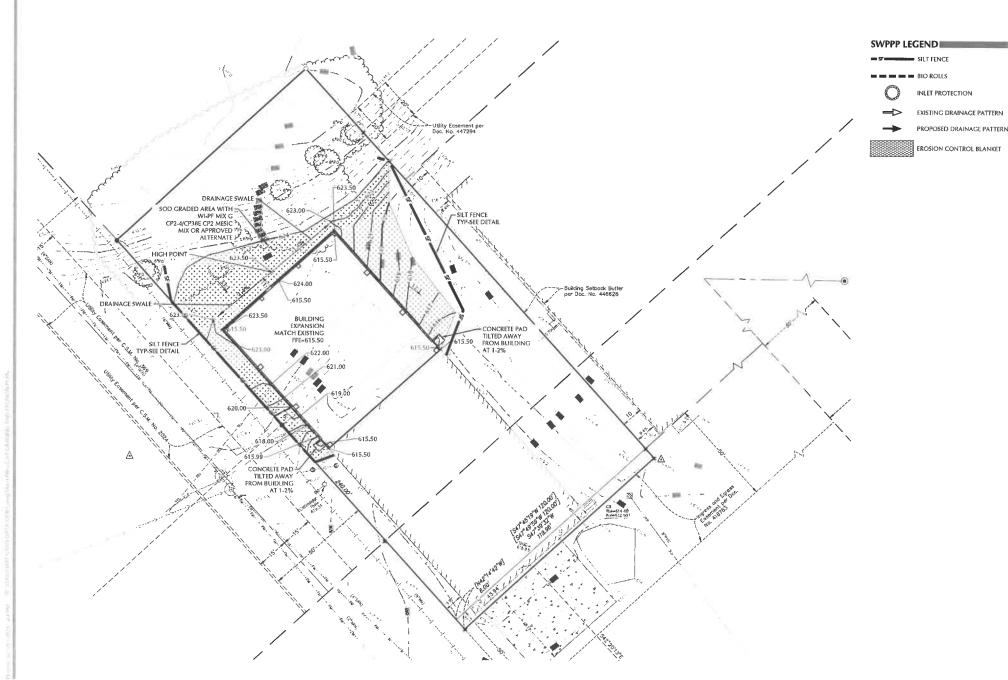

WASHBURN MARINA BUILDING EXPANSION





CIVIL ENGINEERI LAND SLEVENT LANDSCAPE ARCHITECTU ENVIRONZENT

> Maple Color 1/1/15/26 163 47/4 50

CADD QUALIFICATION

206	MELITAL/REVISION
02/07/2024	OWNER REV
02/28/2024	CITY SUBMIT



 Loucks Project No.
 23491

 Project Lead
 JAS


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 IWF

 Checked By
 JAS

 Review Date
 02/27/2024

 SHEET INDEX

C1-1 EXISTING CONDITIONS
C2-1 SITE AND UTILITY PLAN
C3-1 GRADING AND EROSION PLAN

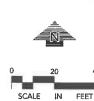




BOAT STORAGE BUILDING MADELINE ISLAND WATER COMPANY

ABBREVIATIONS: PLUS OR MINUS

WASHBURN, WI

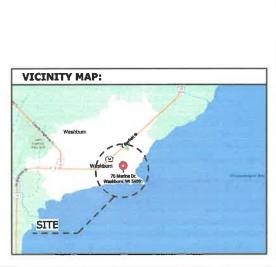

±	PLUS OR MINUS ABOVE FINISHED FLOOR	INT	INTERIOR INVERT
AFF ACT	ACOUSTICAL CEILING TILE	JAN	JANITOR
ADD ADJ	ADDITIONAL ADJUSTABLE, ADJACENT	JIT JST	JOINT
AC AHU	AIR CONDITIONING AIR HANDLING UNIT	LAM	LAMINATE
ALT	ALTERNATE	LVL	LAMINATED VENEER LUMBER LAVATORY
ALUM ANOD	ALUMINUM ANODIZED	L	LENGTH LIGHTING
AP APPROX	ACCESS PANEL APPROXIMATE	LF	LINEAL FEET
ARCH	ARCHITECT(URAL)	LOC	LOCATION, LOCATE POUND
AVG BSMT	AVERAGE BASEMENT	LBS	POUNDS
BRG	BEARING	MFR MAS	MANUFACTURER MASONRY
BIT BLKG	BITUMINOUS BLOCKING	MO MATL	MASONRY OPENING MATERIAL
BD BO	BOARD BOTTOM OF	MAX MECH	MAXIMUM MECHANICAL
BLDG	BUILDING BUILT-UP ROOF	MEMB	MEMBRANE
BUR CUH	CABINET UNIT HEATER	MTL MEZZ	METAL MEZZANINE
CPT CIP	CARPET CAST IN PLACE	MIN	MINIMUM MISCELLANEOUS
CLG	CEILING	MTD	MOUNTED
CMTBD	CEMENT BOARD CENTER	NOM NIC	NOMINAL NOT IN CONTRACT
CT CLR	CERAMIC TILE CLEAR	NTS	NOT TO SCALE
COL	COLUMN	N/A OC	NOT APPLICABLE ON CENTER
CONC	CONCRETE MASONRY UNIT	OPG OPP	OPENING OPPOSITE
CONST	CONSTRUCTION	OH	OVERHEAD
CTRL	CONTROL	OSCI	OWNER SUPPLIED, CONTRACTOR INSTALLED
COORD	CONTROL JOINT COORDINATION	0501	OWNER SUPPLIED, OWNER INSTALLED
CG CTOP	CORNER GUARD COUNTERTOP	Р	PAINT
DEMO	DEMOLISH, DEMOLITION	PKG	PARKING PARTITION
DIA	DETAIL DIAMETER	PATT	PATTERN
DIM DN	DIMENSION DOWN	PL PLAM	PLATE PLASTIC LAMINATE
DWG	DRAWING	PVC PT	POLYVINYL CHLORIDE PORCELAIN TILE
DF EA	DRINKING FOUNTAIN EACH	PIV	POST INDICATOR VALVE
EW	EACH WAY	PRV	POWER ROOF VENTILATOR PRECAST CONCRETE
EWC	ELECTRIC WATER COOLER ELECTRIC(AL)	PREFIN PROP	PREFINISHED PROPERTY
EP EL	ELECTRICAL PANEL ELEVATION	QTY	QUANTITY
ELEV EMER	ELEVATOR	QT R	QUARRY TILE
ENG	EMERGENCY ENGINEER	RWL	RADIUS, RISER RAIN WATER LEADER
EQ EQUIP	EQUAL EQUIPMENT	REF	REFERENCE, REFRIGERATOR REFLECTED CEILING PLAN
EPDM	ETHYLENE PROPYLENE DIENE MONOMER	REINF REQD	REINFORCED REQUIRED
EF	EXHAUST FAN	REV	REVERSE(D), REVISED
EXIST	EXISTING EXPANSION JOINT	RD RM	ROOF DRAIN ROOM
EXT	EXTERIOR EXTERIOR INSULATION	RO RB	ROUGH OPENING RUBBER BASE
1	FINISH SYSTEM	RT	RUBBER TILE
FAB	FABRICATE FACE OF CONCRETE	SAN	SANITARY SCHEDULE
FOF	FACE OF FINISH	SLNT	SEALANT
FOM	FACE OF MASONRY FACE OF STUDS	SHWR	SHEET VINYL SHOWER
FT FRP	FEET OR FOOT FIBER REINFORCED	SIM	SIMILAR SOLID CORE
	PLASTIC PANEL	SS	SOLID SURFACE
FIN FFE	FINISH FINISHED FLOOR	STC	SOUND TRANSMISSION CLASS
FA	ELEVATION FIRE ALARM	SPEC	SPECIFICATION(S) SQUARE
FE FEC	FIRE EXTINGUISHER FIRE EXTINGUISHER	SF	SQUARE FEET STAINLESS STEEL
1 -	CABINET	STD	STANDARD
FIXT FF&E	FIXTURE FIXTURES, FURNISHINGS,	STL	STEEL STRUCTURAL
FLOR	EQUIPMENT FLUORESCENT	SUSP	SUSPENDED TERRAZZO
FLR	FLOOR DRAIN	Т	TREAD
FTG FTG	FOOTING	TOC TOF	TOP OF CONCRETE TOP OF FOOTING
FURN	FOUNDATION FURNITURE	TOM	TOP OF MASONRY TOP OF STEEL
GALV	GALVANIZED	TOW	TOP OF WALL
GA GC	GAGE GENERAL CONTRACTOR	T&G TEMP	TONGUE AND GROOVE TEMPERED, TEMPORARY
GL GLAZ	GLASS GLAZING	TOPO TYP	TOPOGRAPHY TYPICAL
GFI	GROUND FAULT INTERRUPTER	UNO	UNLESS NOTED OTHERWISE
GBD HC	GYPSUM BOARD HOLLOW CORE	VERT VIF	VERTICAL VERIFY IN FIELD
HDWR	HARDWARE	VB	VINYL BASE
HVAC	HEATING, VENTILATION & AIR CONDITIONING	VCT	VINYL COMPOSITION TILE WAINSCOT
HT HM	HEIGHT HOLLOW METAL	WC	WATER CLOSET
HORZ	HORIZONTAL	WH	WATER HEATER WEIGHT
HB HR	HOSE BIB HOUR	WWF WDW	WELDED WIRE FABRIC WINDOW
HYD IN	HYDRANT	W/	WITH
INCL	INCH(ES) INCLUDE(D), INCLUDING	W/O WD	WITHOUT WOOD
ID INSL	IDENTIFICATION INSULATE, INSULATION	WRB	WATER RESISTIVE BARRIER

ROSTER:	
OWNER:	MADELINE ISLAND WATER COMPANY BOAT STORAGE BUILDING 75 MARINA DRIVE WASHBURN, WI 54891 ATTN: DAVID DALQUIST DAVIDDALQUIST@NORDICWARE.COM
GENERAL CONTRACTOR:	GREINER CONSTRUCTION 121 S. 8TH STREET, SUITE 1200 MINNEAPOLIS, MN 55402 ATM: TRAVIS SUTHERLAND 753-213-2885 TSUTHERLAND @GREINERCONSTRUCTION.COM
ARCHITECT:	KOMA 2051 KILLEBREW DRIVE, SUITE 680 BLOOMINGTON, MN 55425 651-451-4127 PHONE WWW.KOMAINC.COM ATTN: STEVE IASRIA STARIA STARIAGNOMAINC.COM
STRUCTURAL ENGINEER:	KOMA 2051 KILLEBREW DRIVE, SUITE 680 BLOOMINGTON, MN 55425 651-451-4123 PHONE WWW.KOMARIC.COM ATTN: MIKE LISOWSKI

EARTH OR FILL

CONCRETE

MORTAR

BITUMINOUS

GYPSUM BOARD

STEEL STUD

STRUCTURAL WOOD

BATT INSULATION

SHEET NAME TLE SHEET DDE DATA PLAN	_
ODE DATA PLAN	
EMOLITION FLOOR PLAN	
OOR PLAN	
OF PLAN	
FLECTED CEILING PLAN	
TERIOR ELEVATIONS	
JILDING SECTIONS	
TAILS	
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	OOR PLAN OOF PLAN EFLECTED CELLING PLAN CIERTOR REEVATIONS JULIDING SECTIONS ETAILS ENERAL STRUCTURAL NOTES PECIAL INSPECTIONS JUNDATION PLAN DUNDATION PLAN DUNDATI

DRAWING SYMBOLS:

1 SIM	DETAIL NUMBER SHEET WHERE SECTION IS LOCATED
SIM	


















- WORK POINT.

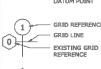

P? WALL TYPE





- CENTERLINE SYMBOL

GENERAL NOTES:

- 1. THE FOLLOWING GENERAL NOTES SHALL APPLY TO DRAWINGS AND GOVERN
- 2. THE CONSTRUCTION DOCUMENTS CONSIST OF DRAWINGS
- THE WORK DELINEATED IN THESE DRAWINGS SHALL CONFORM TO CODES, STANDARDS, AND REGULATIONS THAT HAVE JURISDICTION IN THE STATE OF WISCONSIN AND THE CITY OF WASHBURN.
- . THE GENERAL CONTRACTOR AND ALL SUB CONTRACTORS SHALL COMPLY WITH THE APPROPRIATE MUNICIPAL AND REGULATORY AGENCIES, SHALL BE RESPONSIBLE FOR FILING FOR AND SECURING NECESSARY PERMITS AND APPROVALS FOR ALL TRADES, AND SHALL COMPLY WITH THE INSTRUCTIONS OF THE CONSTRUCTION DOCUMENTS.
- 5. COMPARE FIELD CONDITIONS WITH ARCHITECTURAL DRAWINGS. ANY DISCREPANCIES SHALL BE DIRECTED TO THE ARCHITECT FOR CLARIFICATION PRIOR TO FABRICATION AND/OR CONSTRUCTION. SUBMIT ALL NECESSARY SHOP DRAWINGS PRIOR TO FABRICATION FOR APPROVAL BY ARCHITECT. NO INFORMATION OR DETAILS ON THESE SHEETS MAY BE USED ON OTHER PROJECTS WITHOUT THE PERMISSION OF THE ARCHITECT.
- 5. THE FOLLOWING SHALL APPLY TO THE DRAWINGS AND GOVERN IN CASE OF AMBIGUITIES, DISCREPANCIES, OR IRREGULARTIES IN THE CONSTRUCTION DOCUMENTS, MANUFACTURES'S INSTRUCTIONS, SITE CONDITIONS, OR APPLICABLE CODES AND STANDARDS; REQUEST CLARIFICATION FROM THE ARCHITECT BEFORE PROCEEDING. THE COST OF WORK DONE AS A RESULT OF PROCEEDING WITHOUT OBTAINING CLARIFICATION WILL BE BORNE SOLELY BY THE CONTRACTOR.
- 8. UNLESS OTHERWISE SHOWN OR NOTED, TYPICAL DETAILS SHALL BE USED WHERE APPLICABLE.
- SAFETY MEASURES: THE CONTRACTOR SHALL BE SOLELY AND COMPLETELY RESPONSIBLE FOR THE CONDITIONS OF THE JOB SITE, INCLUDING SAFETY OF THE PERSONS AND PROPERTY AND FOR INDEPENDENT ENGINEERING REVIEWS OF THESE CONDITIONS. THE ARCHITECT'S OR ENGINEERS JOB SITE REVIEW IS NOT INTENDED TO INCLUDE REVIEW OF THE ADEQUACY OF THE CONTRACTOR'S SAFETY MEASURES.
- 10. ALL WORK IS THE RESPONSIBILITY OF THE GENERAL CONTRACTOR UNLESS
- 11. WITHIN THESE PLANS, "OWNER" MEANS THE DESIGNATED REPRESENTATIVE(S) OF MADELINE ISLAND WATER COMPANY BOAT STORAGE.
- 12. THE TERM "CONTRACTOR" AND "G.C." REFER TO THE OWNER'S GENERAL CONTRACTOR AND THE GENERAL CONTRACTOR'S SUB-CONTRACTORS, IT IS THE GENERAL CONTRACTOR'S RESPONSIBILITY TO DETERMINE THE DIVISION OF WORK AMONG SUB-CONTRACTORS.

- 15. SIMILAR MATERIALS INDICATED ON DIFFERENT PLANS, SECTIONS AND DETAILS, AND ANNOTATED ON ONE OR MORE PLANS, SECTIONS OR DETAILS SHALL BE CONSIDERED ANNOTATED, NOTED OR LABELED COMPLETELY ON ALL PLANS, SECTIONS & DETAILS.
- 16. CONTRACTORS ARE TO VERIFY SITE INFORMATION BEFORE STARTING CONSTRUCTION. EXISTING SITE CONDITIONS SHOWN ON THE DRAWINGS MAY NOT REPRESENT ALL EXISTING SITE CONDITIONS, CONTRACTORS SHALL VERIFY EXISTING CONDITIONS AND NOTIFY THE ARCHITECT IN WRITING OF ANY DISCREPANCIES WITH THE DRAWINGS.
- THE LOCATION AND SIZE OF EXISTING UTILITIES ARE SHOWN IN AN APPROXIMATE LOCATION ONLY FOR CONVENIENCE, VERIFY EXISTING UTILITIES PRIOR TO CONSTRUCTION START.
- 18. REGARDING CONTRACTOR'S USE OF PREMISES, TIME RESTRICTIONS FOR PERFORMING WORK ARE TO BE VERIFIED WITH LANDLORD AND ALL UTILITY OUTAGES AND SHUTDOWNS SHALL BE COORDINATED WITH THE LANDLORD.





BOAT STORAGE BUILDING MADELINE ISLAND WATER C 75 MARINA DRIVE WASHBURN, WI 54891


PROJECT: 24021 DRAWN BY: MMC CHECKED BY STI DATE: 4/5/2024 REVISIONS:

SHEET

TITLE

PERMIT SET

Α1

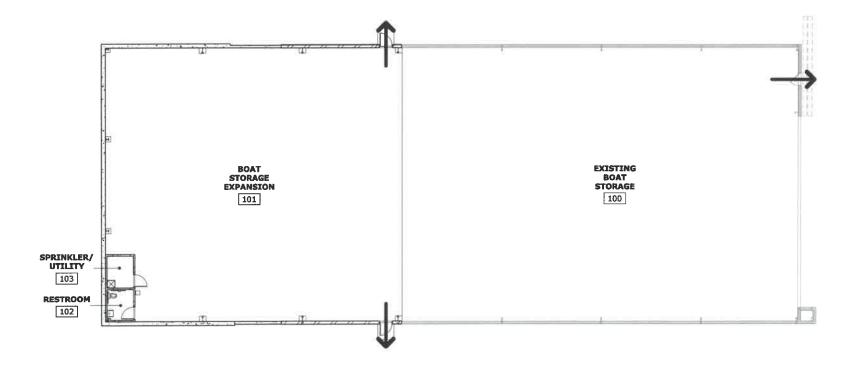

1 CODE DATA PLAN
3/32" = 1'-0"

PROJECT CODE DATA:

NOTE: THIS CODE ANALYSIS DOES NOT DELINEATE DETAILED REQUIREMENTS FOR THE MECHANICAL, PLUMBING AND ELECTRICAL SYSTEMS.

CODE CRITERIA

WISCONSIN SPS 362 (BASED ON 2015 INTERNATIONAL BUILDING CODE)

BUILDING

USE AND OCCUPANCY CLASSIFICATION (SECTION 302)
GROUP S-1: BOAT STORAGE

- ALLOWABLE AREA, HEIGHT & NUMBER OF STORIES
 (SECTION 504 & 506, TABLE 504,3/504.4/506,2)

 ALLOWABLE AREA PER STORY (WITH SPRINKLER INCREASE) = 36,000 SF
 PROVIDED AREA PER STORY = 12,336 SF
 MAX FEET ABOVE GRADE PLANE (WITH SPRINKLER INCREASE) = 60' (ACTUAL = 40')
 MAX STORIES ABOVE GRADE PLANE (WITH SPRINKLER INCREASE) = 2 (ACTUAL = 1 STORIES ABOVE GRADE)

TYPE OF CONSTRUCTION (SECTION 602) • TYPE V-B; SPRINKLERED

FIRE-RESISTANCE RATING REQUIREMENTS FOR BUILDING ELEMENTS (HOURS);

	TYPE V-B	
STRUCTURAL FRAME INCLUDING COLUMNS, GIRDERS AND TRUSSES	0	
BEARING WALLS EXTERIOR INTERIOR	0 0	
NON-BEARING WALLS AND PARTITIONS EXTERIOR INTERIOR	0	
FLOOR CONSTRUCTION INCLUDING SUPPORTING BEAMS AND JOISTS	0	
ROOF CONSTRUCTION INCLUDING SUPPORTING BEAMS AND JOISTS	0	

- AUTOMATIC SPRINKLER SYSTEMS (SECTION 903)

 SPRINKLERS SHALL BE INSTALLED THROUGHOUT IN ACCORDANCE WITH NFPA 13 (SECTION 903.3.1.1)

 ALL CONCEALED SPACES ENCLOSED WHOLLY OR PARTLY BY EXPOSED COMBUSTIBLE CONSTRUCTION SHALL BE PROTECTED BY SPRINKLERS

 CONTRACTOR TO PROVIDE AND INSTALL PORTABLE FIRE EXTINGUISHERS AS REQUIRED BY THE LOCAL FIRE MARSHAL CONTRACTOR TO PORTOURD AND TYPE WITH THE LOCAL FIRE MARSHAL

• TOTAL NUMBER OF OCCUPANTS FOR THE BUILDING = 25 (12,366/500SF/OCC)

MEANS OF EGRESS SIZING (SECTION 1005) STAIR CAPACITY: 0.3 INCH PER OCCUPANT OTHER EGRESS COMPONENTS: 0.2 INCH PER OCCUPANT

EXIT AND EXIT ACCESS DOORWAYS (SECTION 1006) EXITS REQUIRED = 2 EXIT(S), 64" OF EXIT WIDTH EXITS PROVIDED = 3 EXIT(S), 96" OF EXIT WIDTH

EXIT SIGNS (SECTION 1013)

EXITS AND EXIT ACCESS DOORS SHALL BE MARKED BY AN APPROVED EXIT SIGN READILY VISIBLE FROM ANY DIRECTION OF EGRESS TRAVEL ACCESS TO EXITS SHALL BE MARKED BY READILY VISIBLE EXIT SIGNS IN CASES WHERE THE EXIT OR THE PATH OF EGRESS TRAVEL IS NOT IMMEDIATELY VISIBLE TO THE OCCUPANTS. EXIT SIGN PLACEMENT SHALL BE SUCH THAT NO POINT IN AN EXIT ACCESS CORRIDOR IS MORE THAN 100 FEET FROM THE NEAREST VISIBLE EXIT SIGN, EXCEPT:

EXIT SIGNS ARE NOT REQUIRED IN ROOMS OR AREAS WHICH REQUIRE ONE EXIT OR EXIT ACCESS

PLUMBING FIXTURES (CHAPTER 29)
BUILDING OCCUPANT LOAD WAS USED AS THE CALCULATION FOR THE TOTAL PLUMBING DESIGN OCCUPANT LOAD.

MINIMUM NUMBER OF REQUIRED PLUMBING FIXTURES (TABLE 2902.1; SECTION 2902)

OCCUPANCY		CY WATER CLOSE		OSETS	LAVATORIES		SHOWER		DF		SS	
USE	LOAD	RATIO	MALE	FEMALE	RATIO	MALE	FEMALE		#	RATIO	#	
S-1	25	1/100	0.25	0.25	1/100	0.25	0,25	-	-	1/1,000	0.03	1
TOT	ALS		0,25	0,25		0.25	0,25		-		0.03	1

BASED ON THE LIMITED USE OF THIS BUILDING, A SINGLE USER RESTROOM IS BEING PROVIDED

WC = WATER CLOSET	LAV = LAVATORY	URL = URINAL
DF = DRINKING FOUNTAIN	SS = SERVICE SINK	SHWR = SHOWER








PLAN DATA CODE

BOAT STORAGE BUILDING
MADELINE ISLAND WATER COMPANY
75 MARINA DRIVE
WASHBURN, WI 54891 PROJECT: 24021 DRAWN BY: MMC CHECKED BY: STI DATE: 4/5/2024 REVISIONS:

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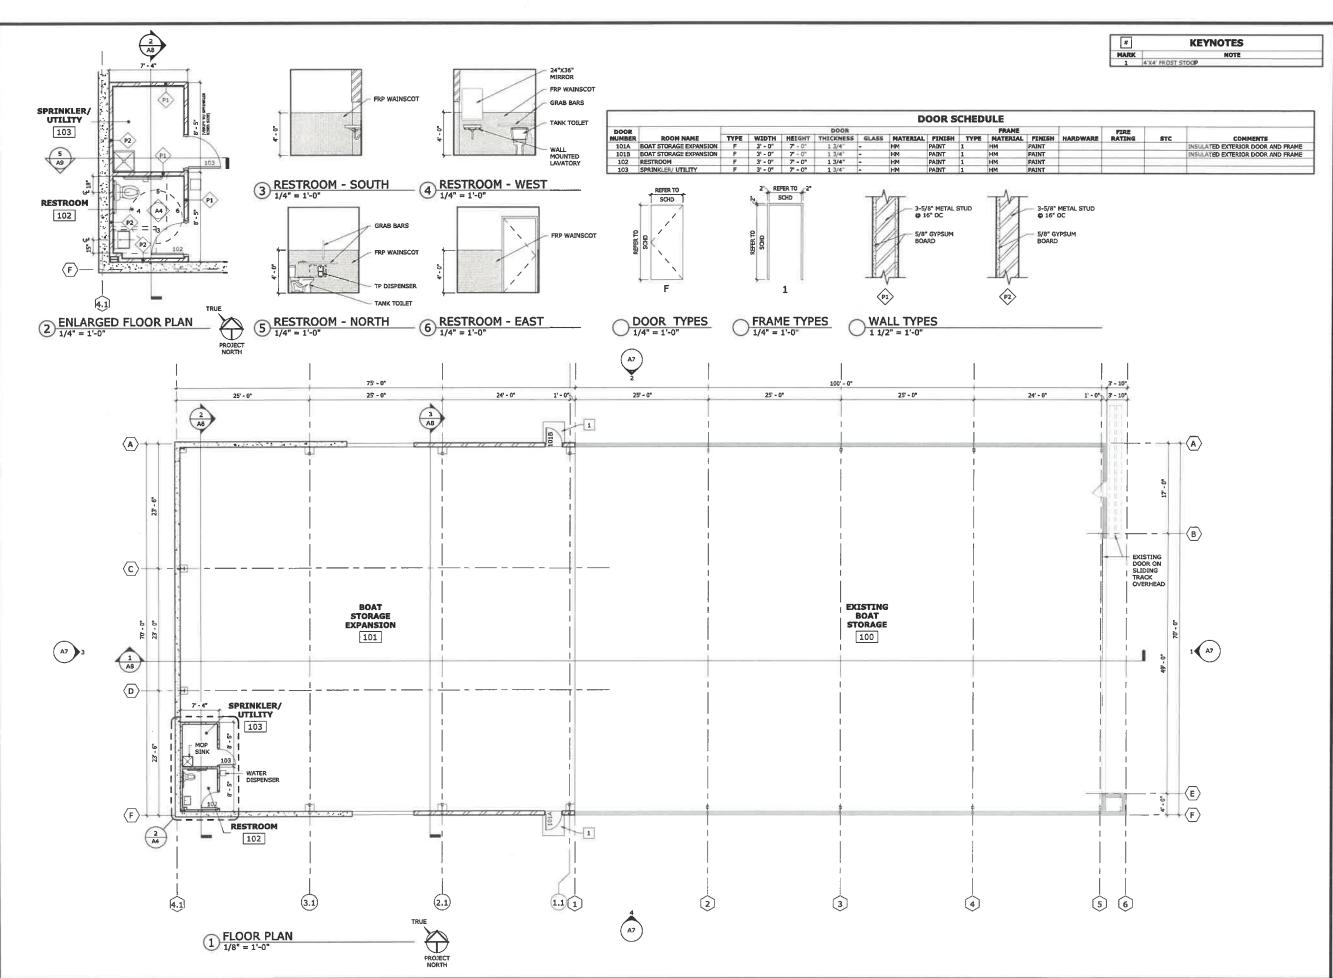

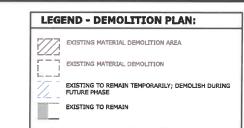
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DEMOLITION FLOOR PLAN

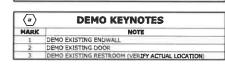BOAT STORAGE BUILDING
MADELINE ISLAND WATER COMPANY
75 MARINA DRIVE
WASHBURN, WI 54891 PROJECT: 24021 DRAWN BY: MMC STI CHECKED BY: DATE: 4/5/2024 REVISIONS:
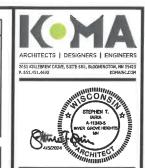
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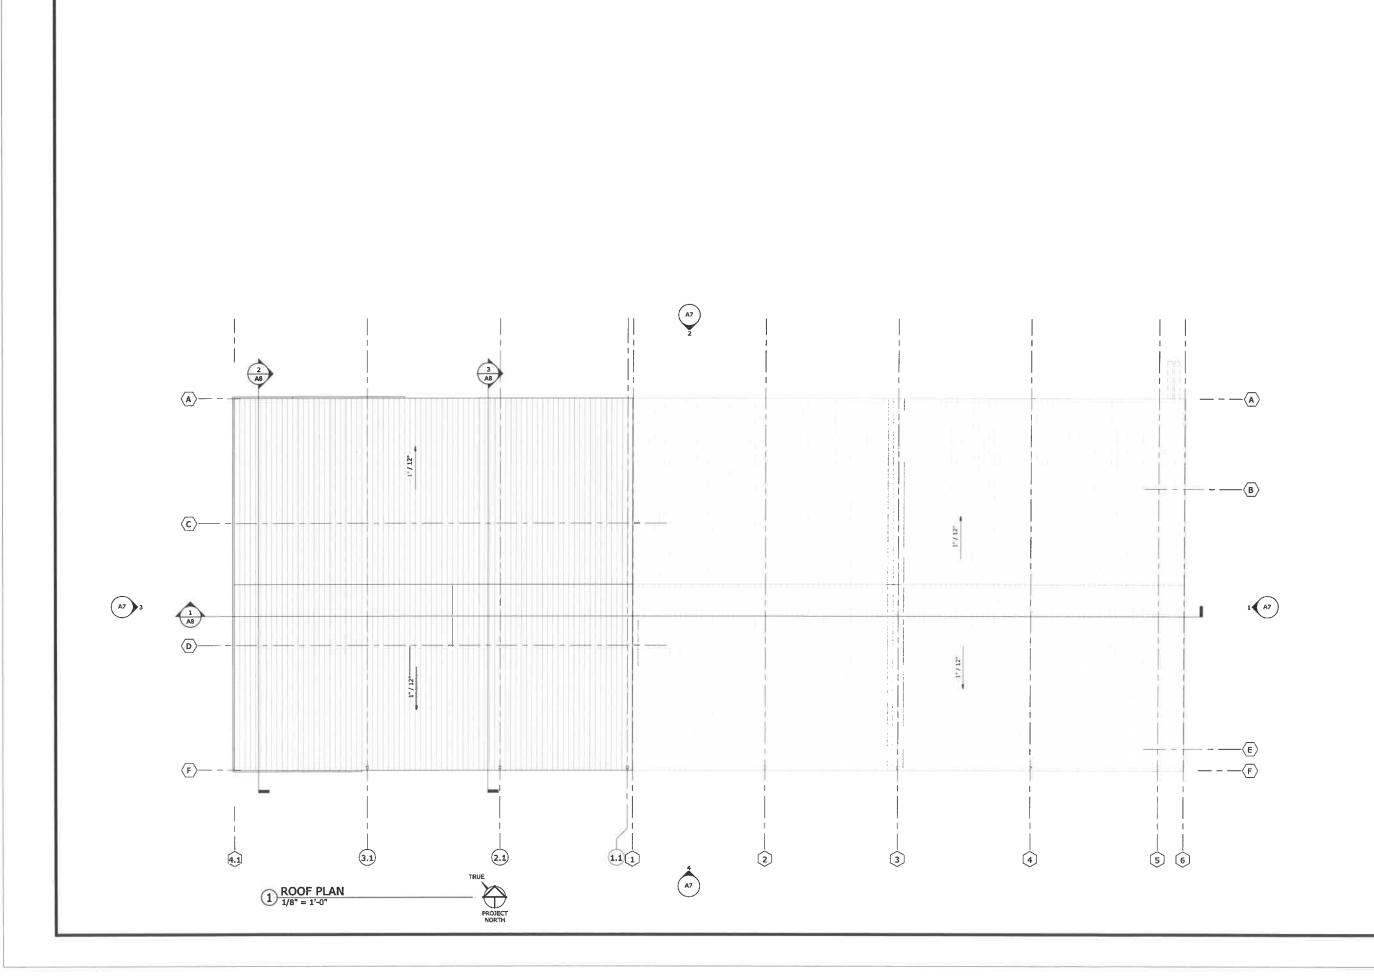




FLOOR PLAN

BOAT STORAGE BUILDING
MADELINE ISLAND WATER COMPANY
75 MAKINA DRIVE
WASHBURN, WI 54891 PROJECT: 24021 DRAWN BY: MMC CHECKED BY: STI DATE: 4/5/2024 REVISIONS:

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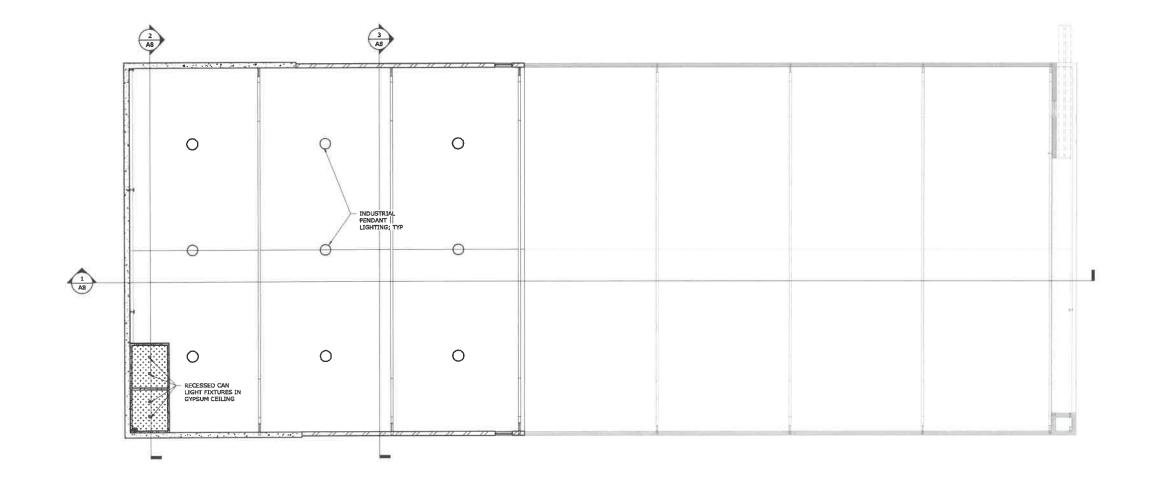




ROOF PLAN

BOAT STORAGE BUILDING MADELINE ISLAND WATER COMPANY 75 MARINA DRIVE WASHBURN, WI 54891 PROJECT: DRAWN BY: CHECKED BY: 24021 MMC STI 4/5/2024 DATE: REVISIONS:

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PROJECT NORTH

1/8" = 1'-0"





REFLECTED CEILING PLAN

BOAT STORAGE BUILDING MADELINE ISLAND WATER COMPANY 75 MARINA DRIVE WASHBURN, WI 54891

PROJECT: 24021
DRAWN BY: MMC
CHECKED BY: STI
DATE: 4/5/2024
REVISIONS:

PERMIT SET

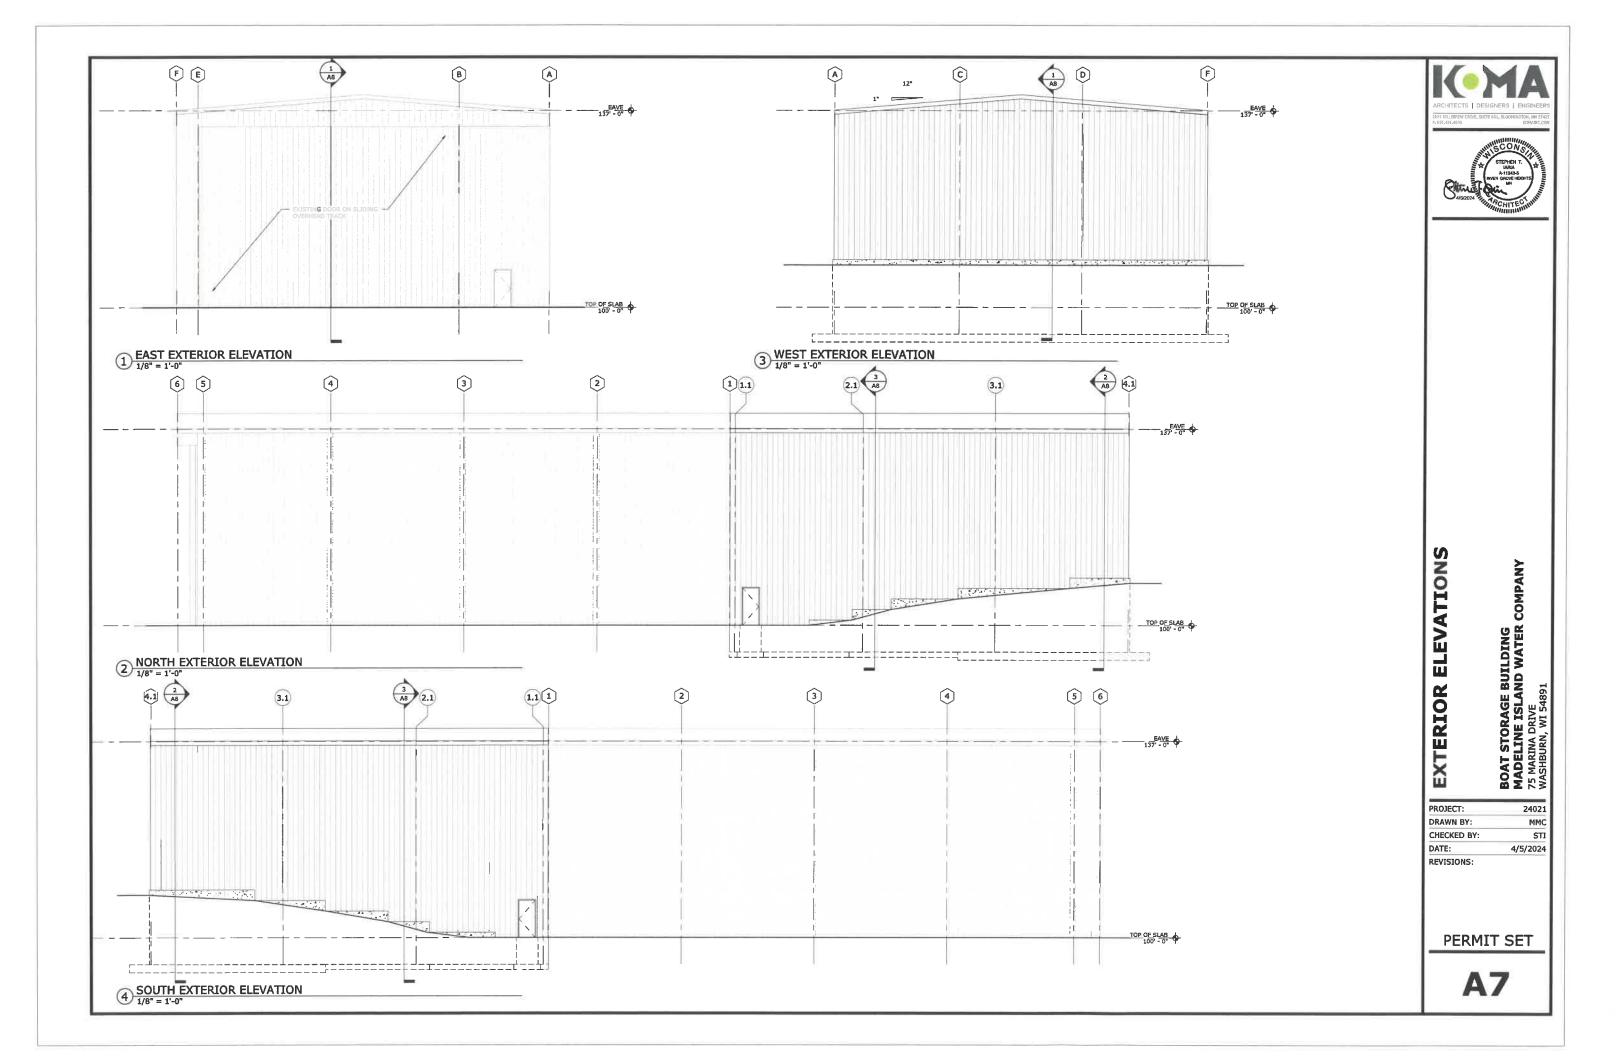

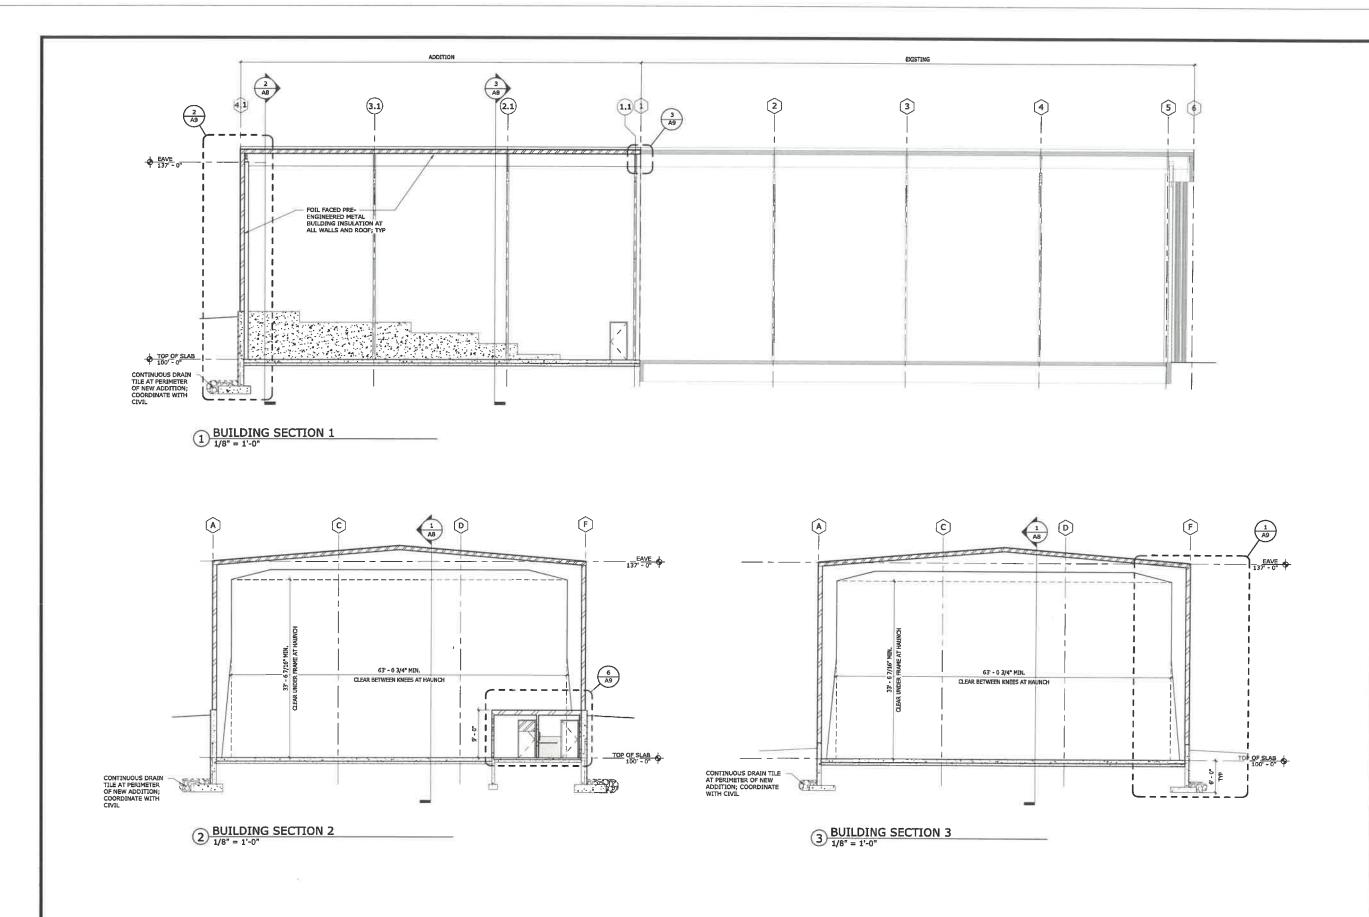




BUILDING SECTIONS

BOAT STORAGE BUILDING
MADELINE ISLAND WATER COMPANY
75 MARINA DRIVE
WASHBURN, WI 54891 PROJECT: 24021 MMC STI DRAWN BY: CHECKED BY: DATE: 4/5/2024 REVISIONS:

PERMIT SET

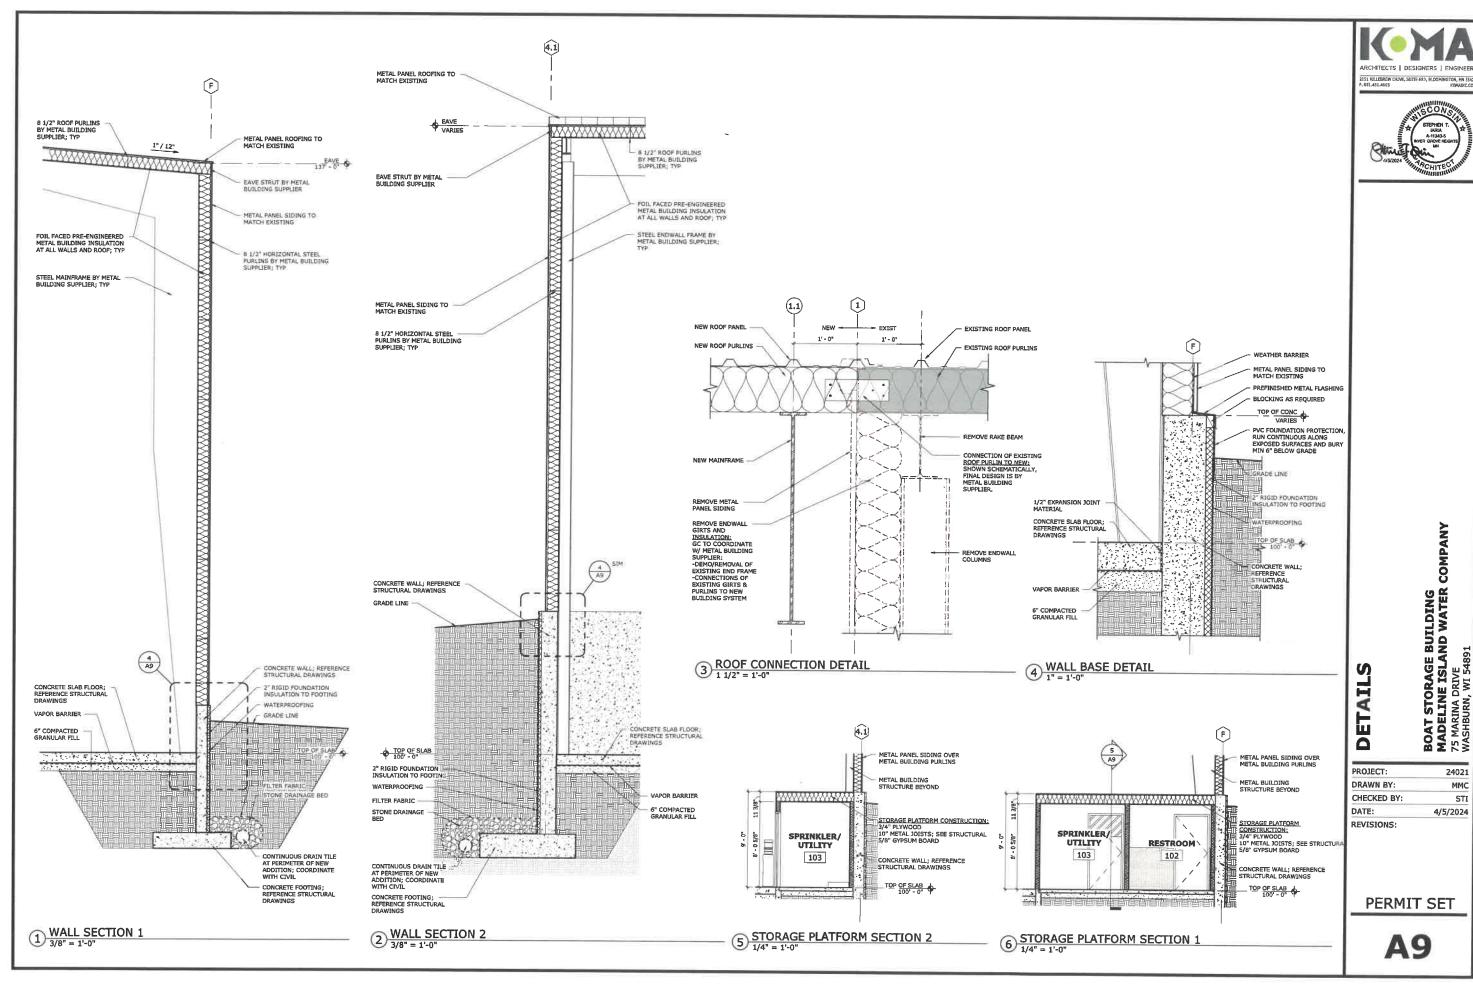



STRUCTURAL NOTES:

SPECIAL INSPECTIONS AS REQUIRED BY THE ABOVE REFERENCED CODES AND THE LOCAL BUILDING CODE OFFICIAL.

DESIGN LOADS:		
ROOF LOAD:	DEAD LOAD:	WEIGHT OF METAL BUILDING & COLLATERAL TO BE DETERMINED BY METAL BUILDING SUPPLIER 20 PSF
SNOW LOAD:		$\begin{array}{l} P_0 = 60 \text{ PSF} \\ II \\ II = 1.0 \\ C_0 = 1.0 \\ C \approx 1.2 \text{ (UN-HEATED)} \\ P_1 = 50.4 \text{ PSF} \\ \text{PER ASCE 7-16, TO BE} \\ \text{DETERMINED BY THE} \\ \text{METAL BUILDING SUPPLIER} \end{array}$
FLOOR LOAD:	DEAD LOAD (MISC): LIVE LOAD (LIGHT STORAGE):	15 PSF 125 PSF
WIND LOAD:	BASIC WIND SPEED: EXPOSURE GROUP: INTERNAL PRESSURE COEFFICIENT:	V = 115 MPH C ±GCpi = 0.18
SEISMIC LOAD:	SEISMIC DESIGN CATEGORY: SITE CLASS: FORCE RESISTING SYSTEM: ANALYSIS PROCEDURE: RISK CATEGORY: IMPORTANCE FACTOR: ACC SHORT PERIOD: ACC ONE-SEC PERIOD: MAX RESPONSE SHORT PERIOD: MAX RESPONSE ONE-SEC PERIOD:	

HANDRAILS & GUARDRAILS: CONCENTRATED LOAD: 200# COMPONENT LOAD: 50 PS

THE DESIGN AND CERTIFICATION OF THE PRE-ENGINEERED BUILDING MEMBERS AND CONNECTIONS SHALL BE BY A PROFESSIONAL ENGINEER REGISTERED IN THE STATE OF WISCONSIN.

ALL CONNECTIONS OF THE PRE-ENGINEERED BUILDING MEMBERS TO OTHER MEMBERS SHALL BE DESIGNED & SUPPLIED BY THE PRE-ENGINEERED BUILDING

PRELIMINARY PRE-ENGINEERED BUILDING DESIGN REACTIONS WERE AVAILABLE AT THE TIME OF THE DESIGN OF THE FOUNDATION SYSTEM. FINAL CERTIFIED REACTIONS SHALL BE PROVIDED TO THE BORISHER OF RECORD FOR VERIFICATION PRIOR TO SHOP DRAWING APPROVAL & CONSTRUCTION.

DESIGN MATERIAL:

REINFORCING STEEL:	DEFÖRMED BARS WELDED WIRE FABRIC	ASTM A615 GRADE 60 ASTM A185			
STRUCTURAL STEEL:	WIDE FLANGE SHAPES OTHER SHAPES, PLATES STRUCTURAL TUBES STRUCTURAL PIPES ANCHOR RODS	ASTM A992-98 ASTM A36, GRADE 36 ASTM A500, GRADE B ASTM A53, GRADE B ASTM F1554, GRADE 30			
CONCRETE:	f'c = 4000 PSI (ALL OTHI	00 PSI @ 28 DAYS (FOOTINGS) 00 PSI (ALL OTHER) EIGHT CONCRETE WEIGHT= 110 PCF			

DESIGN DEFLECTION CRITERIA:

OOF	LIVE LOAD TOTAL LOAD	= L/240 = L/180
LOOR	LIVE LOAD TOTAL LOAD	= L/360 = L/240

FUTURE EXPANSION

THIS PROJECT IS NOT DESIGNED FOR FUTURE EXPANSI

THESE NOTES SHALL BE USED IN CONJUNCTION WITH THE PLANS AND ANY DISCREPANCIES SHALL BE BROUGHT TO THE ATTENTION OF THE STRUCTURAL ENGINEER. SHOULD ANY OF THE DETAILED INSTRUCTIONS SHOWN ON THE PLANS CONFLICT WITH THESE STRUCTURAL NOTES, SPECIFICATIONS OR WITH EACH OTHER, THE STRUCTES PROVISION SHALL GOVERN.

THE CONTRACTOR MUST CHECK ALL DIMENSIONS, FRAMING CONDITIONS, AND SITE CONDITIONS BEFORE STARTING WORK. ENGINEER SHALL BE NOTIFIED IMMEDIATELY OF ANY DISCREPANCIES OR POSSIBLE DEFICIENCIES.

MATERIALS, EQUIPMENT AND PRODUCTS OTHER THAN THOSE DESCRIBED BELOW OR INDICATED ON THE DRAWINGS MAY BE CONSIDERED FOR USE, PROVIDED PRIOR APPROVAL IS OBTAINED FROM THE OWNER, ENGINEER AND THE GOVERNING AUTUADITY.

TYPICAL DETAILS SHALL APPLY WHERE NO SPECIFIC DETAILS OR SECTIONS ARE

OBSERVATION VISITS TO THE JOB SITE BY THE ENGINEER DO NOT INCLUDE INSPECTION OF CONSTRUCTION METHODS OR SAFETY CONDITIONS AT THE WORK SITE. THESE VISITS SHALL NOT BE CONSIDERED AS CONTINUOUS AND DETAILED INSPECTION.

VERIFY ALL OPENINGS THROUGH CONSTRUCTION WITH HEATING AND VENTILATION CONTRACTOR, PLUMBING CONTRACTOR, AND ELECTRICAL CONTRACTOR FOR SIZE AND LOCATION.

ALL NON-BEARING PARTITIONS ARE TO BE CONSTRUCTED TO ALLOW LIVE LOAD DEFLECTION OF THE STRUCTURAL MEMBERS ABOVE. SEE THE DESIGN DEFLECTION CRITERIA NOTE ABOVE FOR THE EXTENT OF DEFLECTION.

THE STRUCTURAL DESIGN IS BASED ON THE OWNER ACCEPTED RECOMMENDATIONS CONTAINED IN THE GEOTECHNICAL REPORT PREPARED BY:

BRAUN PROJECT B2311206 JOSEPH C. BUTLER, PE

REFER TO THE GEOTECHNICAL REPORT AND COORDINATE WITH GEOTECHNICAL ENGINEER FOR OWNER ACCEPTED SITE PREPARATIONS.

CONCRETE SLAS ON GRADE DESIGN IS BASED ON A SUBGRADE MODULUS OF 250 PCI ACHIEVED BY PLACING 6" OF COMPACTED GRUSHED AGGREGATE BASE IMMEDIATELY BELOW THE SLAVE REPORT FOR PREPARATION & COMPACTION RECOMMENDATIONS.

FOOTINGS SHALL BEAR ON COMPETENT NATURAL UNDISTURBED SOIL OR ENGINEERED FILL.

REFER TO THE GEOTECHNICAL REPORT SECTION C.2.e (TABLE 5) FOR FILL MATERIAL CLASSIFICATIONS, SOIL TYPE, GRADATION, LOCATION TO BE USED, & ADDITIONAL REFER TO THE GEOTECHNICAL REPORT SECTION C.2.e (TABLE 6) FOR SOIL COMPACTION

ALL FILL SHALL BE A GRANULAR MATERIAL AND COMPACTED TO GEOTECHNICAL RECOMMENDED PROCTOR DENSITY (ASTM 698).

FOOTINGS HAVE BEEN DESIGNED FOR A MAXIMUM SOIL BEARING PRESSURE OF 3000 PS

IF SOIL AT BOTTOM OF FOOTING IS OF QUESTIONABLE BEARING VALUE, NOTIFY THE ARCHITECT / ENGINEERS OFFICE AT ONCE.

CANTILEVERED RETAINING WALLS HAVE BEEN DESIGNED USING 38 PCF LATERAL EARTH PRESSURE. IN LIEU OF A SOILS REPORT, IT WILL BE THE RESPONSIBILITY OF THERS TO VERIFY THIS VALUE.

DRAINAGE SHALL BE INSTALLED BEHIND STRUCTURES WITH UNBALANCED BACKFILL LEVELS ON OPPOSITE SIDES (RETAINING WALLS) TO PREVENT HYDROSTATIC LOADING BEHIND THE WALL,

ALL OPEN AIR AND UNHEATED FOUNDATIONS SHALL HAVE A MINIMUM OF $6^\prime\text{--}0^\prime^\prime$ OF FROST PROTECTION.

THE TOP OF FOOTING ELEVATION FOR ALL FOOTINGS SHALL BE STEPPED BELOW ANY UNDERGROUND UTILITIES THAT ARE ENTERING OR ARE ADJACENT TO THE BUILDING. THE CONTRACTOR SHALL COORDINATE FOOTING ELEVATIONS WITH UTILITIES PRIOR TO

CODE FOR REINFORCED CONCRETE IS THE ACI 318-14.

PROVIDE SUITABLE SUPPORT OF ALL REINFORCING TO PREVENT DISPLACEMENT DURING THE POURING OF CONCRETE.

ALUMINUM CONDUIT, ALUMINUM PIPING, OR ALUMINUM ACCESSORIES ARE NOT PERMITTED IN CONCRETE SLABS OR CONCRETE WALLS.

CONCRETE SHALL BE MAINTAINED ABOVE 50 DEGREES F. AND IN A MOIST CONDITION FOR AT LEAST 7 DAYS,

PROVIDE CORNER BARS TO MATCH HORIZONTAL REINFORCING IN ALL WALLS & FOOTINGS

- ALL CONCRETE WALL OPENINGS TO HAVE:

 AT EACH CORNER OF THE OPENING; MINIMUM (2) #5x4'-0" DIAGONAL BARS.

 AT EACH SIDE OF THE OPENING; MINIMUM (2) #5 OR AT LEAST ONE-HALF OF THE TOTAL AREA OF INTERRUPTED VERTICAL WALL REINFORCEMENT.

 AT THE TOP & BOTTOM OF THE OPENING; MINIMUM (2) #5 OR AT LEAST ONE-HALF OF THE TOTAL AREA OF INTERRUPTED HORIZONTAL WALL REINFORCEMENT.

ALL EXTERIOR CONCRETE TO HAVE 5 - 6% ENTRAINED AIR BY VOLUME.

. EXPANSION BOLTS PLACED IN EXISTING CONCRETE ARE TO BE 3/4" DIA. HILTI KWIK BOLT 3 ITI 5" EMBEDMENT UND AND ARE TO BE INSTALLED IN ACCORDANCE WITH THE NUTACTURERS RECOMMENDATIONS.

ALL DOWELS PLACED IN EXISTING CONCRETE ARE TO BE SET IN HILTI HIT HY-200-R V3 EPOXY. ALL EPOXY IS TO BE INSTALLED IN ACCORDANCE WITH THE MANUFACTURERS RECOMMENDATIONS INCLUDING SPECIAL INSPECTION.

CONCRETE WITH FIBERMESH REINFORCING SHALL CONTAIN ONLY 100 PERCENT VIRGIN POLYPROPYLENE FIBERS CONTAINING NO REPROCESSED OLEFIN MATERIALS AND SPECIFICALLY MANUFACTURED TO AN OPTIMUM GRADATION FOR USE AS CONCRETE SECONDARY REINFORCEMENT, MINIMUM FIBER APPLICATION RATE SHALL EQUAL 0.1% BY VOLUME, 1.5 POUND PER CUBIC YARD.

CONCRETE COVER (UNO ON PLANS) PER ACI 318 & ACI 117:

LOCATION MINIMUM COVER FOOTINGS AND GRADE BEAMS CAST AGAINST 3"

SEAS SIT SIGNED (MINNEY)	FROM TOP O
INTERIOR SLABS	3/4"
WALLS INTERIOR FACE	3/4"
WALLS EXTERIOR FACE - #5 & SMALLER	1 1/2"
WALLS EVTEDIOD FACE - #6 8 LADGED	2#

WHERE CONTINUOUS BARS ARE CALLED FOR, THAY SHALL RUN CONTINUOUSLY AROUND CORNERS AND BE LAPPED AT NECESSARY SPLICES OR HOOKED AT DISCONTINUOUS ENDS. LAP LENGTHS SHALL BE AS INDICATED IN THE SPLICE AND DEVELOPMENT TABLE BELOW. TABLE IS FOR 3,000 PSI CONCRETE

TOP BARS			OTHER BARS			
BAR SIZE	LAP	ANCHORAGE	BAR SIZE	LAP	ANCHORAGE	
#3	28"	22"	#3	22"	17"	
#4	37"	29"	#4	29"	22"	
#5	47"	36"	#5	36"	28"	
#6	56"	43"	#6	43"	33"	
#7	81"	63"	#7	63"	48"	
#8	93"	72"	#8	72"	55"	

COLD FORMED METAL FRAMING

LIGHT GAUGE FRAMING SHALL BE DESIGNED & CONSTRUCTED IN ACCORDANCE WITH IBC CHAPTER 22, SECTION 2205 SPECIFICATION FOR THE DESIGN OF COLD FORMED STEEL STRUCTURAL MEMBERS, EDITION IN EFFECT AT THE TIME OF PERMIT SUBMITTAL.

ALL STUDS, JOIST AND HEADERS SHALL BE INSTALLED AS PER THE MANUFACTURERS RECOMMENDATIONS, INCLUDING AND BRIDGING, BLOCKING AND WEBS STIFFENERS.

ALL HORIZONTAL SPANNING ELEMENTS (JOISTS, HEADERS, BOX BEAMS, ETC...) SHALL BE CONSTRUCTED OF UNPUNCHED MEMBERS, UNLESS NOTED OTHERWISE ON PLAN.

STUD DESIGNATION AND RELATED ACCESSORIES ON THE DRAWINGS ARE PER THE STEEL STUD MANUFACTURER ASSOCIATION (SSMA). MANUFACTURER SHALL FURNISH ELEMENTS OF EQUAL OR GREATER SECTION PROPERTIES, MATERIAL, STRENGTHS AND STIFFNESS.

THE STUD DESIGNATIONS ARE PER SSMA RECOMMENDATIONS:

EXAMPLE: 600S162-54
'600' INDICATES 6.00 INCH MEMBER DEPTH
'S' INDICATES STUD ('T' INDICATES TRACK) 162' INDICATES 1-5/8 INCH FLANGE 54' INDICATES MATERIAL THICKNESS IN MILS (33MILS=20GA.; 43MILS=18GA.; 54MILS=16GA.; 68MILS=14GA.; 97MILS=12GA.)

Fy = 33,000 psi (STUDS - 18 GA. & THINNER), Fy = 50,000 psi (STUDS - 16 GA. & THICKER), Fy = 33,000 psi (TRACK).

PROVIDE DOUBLE STUDS AT ALL WINDOW JAMBS (UNO), STITCH WELD STUDS TOGETHER AT 12 INCHES ON CENTER.

SCREW ALL STEEL SECTIONS AT WINDOW HEADS & SILLS TO JAMB STUDS WITH A MINIMUM OF ONE SCREW IN EACH FLANGE.

ANCHOR EACH STUD TO RUNNERS WITH FOUR #10 SCREWS, TWO TOP AND BOTTOM, WITH ONE SCREW IN EACH

ALIGN RUNNER TRACK ACCURATELY & SECURE TO BASE & HEAD WITH FASTENERS AS SHOWN IN THE MANUFACTURER'S STANDARD SPECIFICATION, OR AS SHOWN ON THE DRAWINGS, WHICHEVER GOVERNS. MAXIMUM SPACING OF FASTENERS TO BE 24 INCHES ON CENTER.

SELF-DRILLING OR SELF-TAPPING TYPE S-12 SCREWS MAY BE USED IN LIEU OF WELDING FOR ASSEMBLING STEEL STUD WALLS. ONE SCREW MAY BE SUBSTITUTED FOR EACH WELD.

ALL STUDS, JOISTS AND ACCESSORIES SHALL BE FORMED FROM STEEL HAVING A G-60 GALVANIZED COATING.

ALL WELDING IS TO BE DONE PER MANUFACTURERS RECOMMENDATIONS ON ROD TYPE AMPERAGE

EACH PANEL OF CONSTRUCTION SHEATHING SHALL BE IDENTIFIED WITH THE APPROPRIATE GRADE-TRADE MARK OF THE AMERICAN PLYWOOD ASSOCIATION

PROVIDE 1/8" SPACE AT EDGES AND ENDS OF EACH SHEET OR AS REQUIRED BY THE MANUFACTURER.

FLOORS (T.8. G): 48/24 (23/32") APA RATED SHEATHING EXPOSURE I ROOF SHEATHING TO BE ATTACHED WITH 0.131" DIAMETER NALLS AT 6" (0., EDGE, 12" O.C. FIELD. PROVIDE 6" O.C. NALLING TO ALL MEMBERS IN LINE WITH SHEAR WALLS. SEE PLANS FOR LOCATIONS OF SPECIAL SHEATHING & NAILING

FLOOR SHEATHING TO BE ATTACHED WITH #6 SCREWS AT 6" O.C. EDGE, 12" O.C. FIELD. EQUIVALENT SCREWS MAY BE

EDGE FASTENERS SHOULD BE PLACED 3/8" FROM PANEL EDGES AND ENDS OR AS REQUIRED BY THE MANUFACTURER

ALL SHEATHING SCREWS TO HAVE A MINIMUM HEAD DIAMETER OF 0.292" IN ACCORDANCE WITH SAE J78. THE SCREWS SHALL HAVE SUFFICIENT LENGTH TO PENETRATE THROUGH THE STEEL STUDS BY AT LEAST THREE EXPOSED THREADS.

SPLICE ALL SHEATHING ON A COMMON MEMBER SO AS TO PROPERLY TRANSFER SHEAR FORCES.

GYPSUM WALL BOARD SHEATHING

THIS PROJECT IS DESIGNED UTILIZING ALL EXTERIOR AND INTERIOR WALLS AS GYPSUM BOARD SHEAR WALLS,

SHEAR WALL MATERIAL TO BE 5/8" FIRE RESISTANT GYPSUM WALL BOARD. SPECIAL WATER RESISTANT GYPSUM BOARD AND GYPSUM SHEATHING TO BE USED AT EXTERIOR SURFACES, SHOWERS AND WATER CLOSETS AS REQUIRED BY CODE.

PROVIDE SOLID GYPSUM WALL BOARD SHEATHING AT EACH SIDE OF ALL INTERIOR AND EXTERIOR WALL SURFACES. ATTACH TO ALL SUPPORTING FRAMING WITH 0.092" DIAMETER COOLER OR WALLBOARD NAILS. EQUIVALENT SCREWS

ATTACH TO ALL SUPPORTING FRAMING WITH MINIMUM #6 SCREW IN ACCORDANCE WITH ASTM C954. THE SCREWS SHALL HAVE SUFFICIENT LENGTH TO PENETRATE THROUGH THE STEEL STUDS BY AT LEAST THREE EXPOSED THREADS, ATTACH TO ALL FRAMING A 7^{*} Q.C.

SPLICE ALL GYPSUM BOARD SHEATHING ON A COMMON MEMBER SO AS TO PROPERLY TRANSFER SHEAR FORCES

AT INTERIOR GYPSUM BOARD WALL SHEATHING, LAP AND NAIL SHEATHING TO THE FLOOR AND ROOF MEMBERS SO AS TO TRANSFER SHEAR FROM LEVEL TO LEVEL. ALL SILL PLATES AT INTERIOR SHEATHING TO BE NAILED TO THE FRAMING BELOW WITH 0.131* DIAMETER NAILS. THE SPACING OF THE NAILS ARE TO MATCH THE ATTACHMENT SPACING IN THE SHEATHING BELOW.

NEW WORK IN CONSUNCTION WITH EXISTING CONSTRUCTION:

THE CONTRACTOR SHALL FIELD VERIFY ALL SIZES, DIMENSIONS, ELEVATIONS, LOCATIONS, ETC. OF ELEMENTS OF THE EXISTING CONSTRUCTION WHICH ARE RELATIVE TO THE NEW CONSTRUCTION.

ALL DIMENSIONS INVOLVING NEW WORK TYING INTO OR GOVERNED BY EXISTING CONSTRUCTION SHALL BE FIELD VERIFIED BY THE CONTRACTOR AND FURNISHED TO THE SUBCONTRACTOR PRIOR TO FABRICATION OF ANY WORK.

THE ENGINEER HAS MADE ASSUMPTIONS CONCERNING THE SOUNDNESS OF THE EXISTING BUILDING. THESE ASSUMPTIONS INCLUDE THAT THE BUILDING WAS DESIGNED AND CONSTRUCTED IN CONFORMANCE WITH SOUND DESIGN AND CONSTRUCTION PRACTICES. THE CONTRACTOR SHALL TAKE SPECIAL PRECAUTION CONCERNING THE PRESERVATION OF THE EXISTING BUILDING DURING DEMOLITION AND NEW CONSTRUCTION WORK.

THE CONTRACTOR SHALL NOTIFY THE ARCHITECT/ENGINEER IMMEDIATELY OF ANY DISCREPANCIES BETWEEN CONSTRUCTION DOCUMENTS AND ACTUAL FIELD CONDITIONS.


SHOP DRAWINGS, DESIGN CRITERIA AND DESIGN CALCULATIONS (IF REQUIRED) SHALL BE FURNISHED FOR THE FOLLOWING STRUCTURAL COMPONENTS:


ALL PRE-FABRICATED STRUCTURAL ELEMENTS

SHOP DRAWINGS SHALL BE SUBMITTED TO THE ENGINEER AND BUILDING DEPT. FOR REVIEW PRIOR TO FABRICATION

SHOP DRAWINGS ARE AN AID FOR FIELD PLACEMENT AND ARE SUPERCEDED BY THE STRUCTURAL DRAWINGS, ANY REVIEW OF THE SHOP DRAWINGS BY THIS OFFICE IS ONLY FOR GENERAL CONFORMANCE TO THE STRUCTURAL REQUIREMENTS AND IN NO WAY GUARANTEES THE ACCURACY OR COMPLETENESS OF THE INFORMATION THEREON. IT SHALL BE THE CONTRACTOR'S RESPONSIBILITY TO INSURE THAT ALL THE CONSTRUCTION IS IN FULL COMPLIANCE WITH THE LATEST SET OF STRUCTURAL DRAWINGS.

PRIOR TO SUBMITTAL, THE CONTRACTOR SHALL REVIEW THE SHOP DRAWINGS AND MAKE ANY CORRECTIONS REQUIRED. THE CONTRACTOR SHALL STAMP AND SIGN THE DRAWINGS AS EVIDENCE THAT THEY HAVE REVIEWED

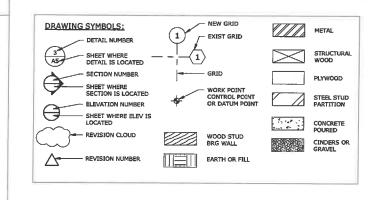

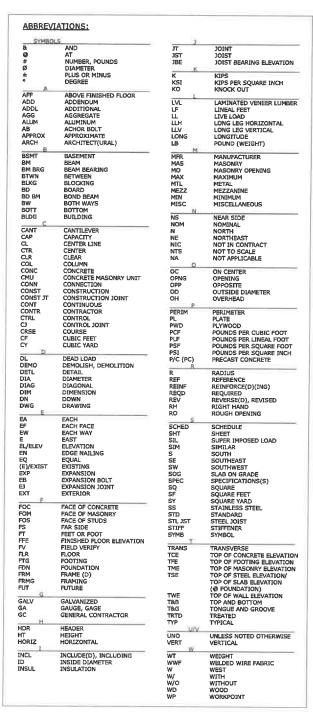



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STORAGE BUILDING LINE ISLAND WATER BOAT S MADEL 75 MARII WASHBU

COMPANY

PROJECT 24021 DRAWN BY: CAF CAF CHECKED BY DATE: 4/5/2024 REVISIONS:

PERMIT SET

VE	RIFICATION & INSPECTION	TYPE OF INSPECTOR	REPORT	ASSIGNE
IN	SPECTION OF FABRICATORS (SECTION 1704.2)	11,55,55,701	- Integrated	11803
	WHERE FABRICATION OF STRUCTURAL LOAD-BEARING MEMBERS AND ASSEMBLIES IS BEING PERFORMED ON THE PREMISES OF A FABRICATOR'S SHOP, SPECIAL INSPECTION OF THE FABRICATED ITEMS SHALL BE REQUIRED BY THIS SECTION AND AS REQUIRED ELSEWHERE IN THIS CODE, INCLUDING PREFABRICATED WOOD STRUCTURAL ELEMENTS AND ASSEMBLIES, SEE SECTION FOR REQUIREMENTS AND EXCEPTIONS.	TECHNICAL	PERIODIC	TA
STI	RUCTURAL STEEL (SECTION 1705.1)			
1.a.	PRIOR TO WELDING: SEE TABLE N5.4-1 IN AISC 360	TECHNICAL	SEE TABLE	TA
1.b.	DURING WELDING: SEE TABLE N5.4-2 IN AISC 360	TECHNICAL	SEE TABLE	TA
1.c.	AFTER WELDING: SEE TABLE N5.4-3 IN AISC 360	TECHNICAL	SEE TABLE	TA
2.a.	PRIOR TO BOLTING: SEE TABLE N5.6-1 IN AISC 360	TECHNICAL	SEE TABLE	TA
2.b.	DURING BOLTING: SEE TABLE N5.6-2 IN AISC 360	TECHNICAL	SEE TABLE	TA
2.c.	AFTER BOLTING: SEE TABLE N5.6-3 IN AISC 360	TECHNICAL	SEE TABLE	TA
3.	STEEL ELEMENTS OF COMPOSITE CONSTRUCTION: PRIOR TO CONCRETE PLACEMENT; SEE TABLE N6,1 IN AISC 360	TECHNICAL	SEE TABLE	TA
COP	ICRETE CONSTRUCTION (SECTION 1705.3)			
1.	INSPECTION OF REINFORCING STEEL, INCLUDING PRESTRESSING TENDONS, AND PLACEMENT	TECHNICAL	PERIODIC	TA
3,	INSPECTION OF ANCHORS CAST IN CONCRETE WHERE ALLOWABLE LOADS HAVE BEEN INCREASED OR WHERE STRENGTH DESIGN IS USED	TECHNICAL	PERIODIC	TA
4.	INSPECTION OF ANCHORS POST-INSTALLED IN HARDENED CONCRETE MEMBERS	TECHNICAL	PERIODIC	TA
5.	VERIFYING USE OF REQUIRED DESIGN MIX	TECHNICAL	PERIODIC	TA
6.	AT THE TIME FRESH CONCRETE IS SAMPLED TO FABRICATE SPECIMENS FOR STRENGTH TESTS, PERFORM SLUMP AND AIR CONTENT TESTS, AND DETERMINE THE TEMPERATURE OF THE CONCRETE	TECHNICAL	CONTINUOUS	TA
7.	INSPECTION OF CONCRETE AND SHOTCRETE PLACEMENT FOR PROPER APPLICATION TECHNIQUES	TECHNICAL	CONTINUOUS	TA
в.	INSPECTION FOR MAINTENANCE OF SPECIFIED CURING TEMPERATURE AND TECHNIQUES	TECHNICAL	PERIODIC	TA
11.	VERIFICATION OF IN-SITU CONCRETE STRENGTH, PRIOR TO STRESSING OF TENDONS IN POST-TENSIONED CONCRETE AND PRIOR TO REMOVAL OF SHORES AND FORMS FROM BEAMS AND STRUCTURAL SLABS	TECHNICAL	PERIODIC	TA
12.	INSPECT FORMWORK FOR SHAPE, LOCATION AND DIMENSIONS OF THE CONCRETE MEMBER BEING FORMED	TECHNICAL	PERIODIC	TA
SOII	S (SECTION 1705.6)			
١.	VERIFY MATERIALS BELOW SHALLOW FOOTINGS ARE ADEQUATE TO ACHIEVE THE DESIGN BEARING CAPACITY,	TECHNICAL	PERIODIC	TA
2,	VERIFY EXCAVATIONS ARE EXTENDED TO PROPER DEPTH AND HAVE REACHED PROPER MATERIAL.	TECHNICAL	PERIODIC	TA
3.	PERFORM CLASSIFICATION AND TESTING OF COMPACTED FILL MATERIALS	TECHNICAL	PERIODIC	TA
	VERIFY USE OF PROPER MATERIALS, DENSITIES AND LIFT THICKNESSES DURING PLACEMENT AND COMPACTION OF COMPACTED FILL	TECHNICAL	CONTINUOUS	TA
5.	PRIOR TO PLACEMENT OF COMPACTED FILL, OBSERVE SUBGRADE AND VERIFY THAT THE SITE HAS BEEN PREPARED PROPERLY	TECHNICAL	PERIODIC	TA
LEGE		F = FABRICA	TOR	
	SI-T = SPECIAL INSPECTOR-TECHNICAL SI-S = SPECIAL INSPECTOR-STRUCTURAL	TA = TESTING	G AGENCY	

NOTE: THE GENERAL CONTRACTOR IS RESPONSIBLE FOR THE COORDINATION OF ALL INSPECTIONS BY THE LOCAL BUILDING DEPARTMENT, SPECIAL INSPECTIONS AND STRUCTURAL OBSERVATIONS. ARRANGEMENTS FOR THESE SITE VISITS ARE TO BE MADE WITH ADEQUATE ADVANCE NOTICE TO ENSURE THAT ALL INSPECTIONS AND OBSERVATIONS ARE PERFORMED IN ACCORDANCE WITH THE BUILDING CODE REQUIREMENTS.






SPECIAL INSPECTIONS

BOAT STORAGE BUILDING
MADELINE ISLAND WATER COMPANY
75 MARINA DRIVE
WASHBURN, WI 54891 PROJECT: 24021 DRAWN BY: CAF CHECKED BY: CAF DATE: 4/5/2024 REVISIONS:

PERMIT SET

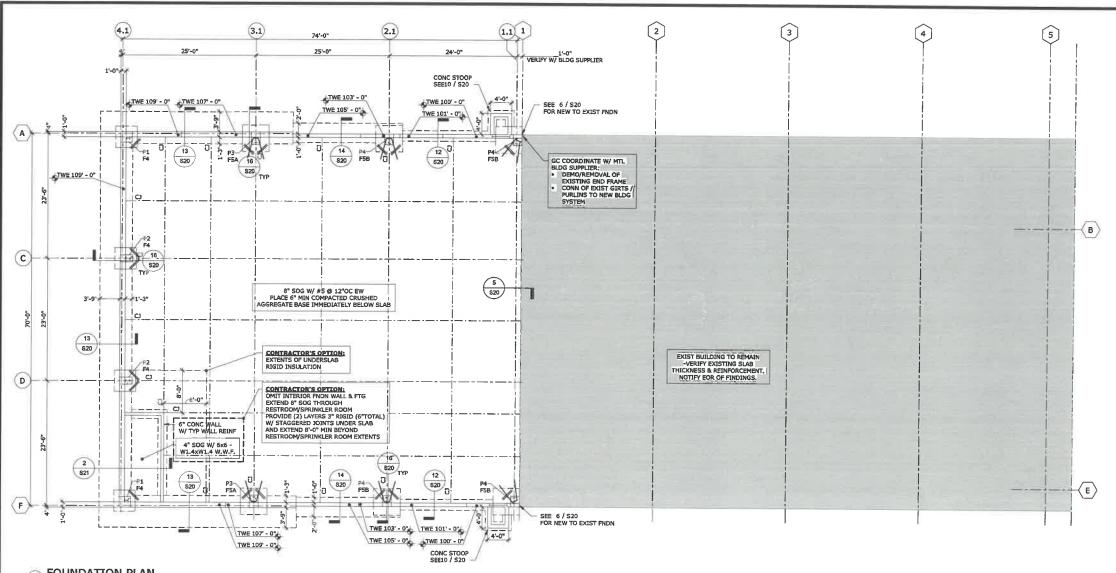

FOUNDATION LEGENS PIER TYPE MARK SEE SCHEDULE FOOTING MARK SEE SCHEDULE TFE XX'-XX TOP OF FOOTING ELEVATION TPE XX'-XX TOP OF PIER ELEVATION TLE XX'-XX TOP OF LEDGE TWE XX'-XX TOP OF WALL ELEVATION TFE XX'-XX TOP OF FOOTING ELEVATION CONTROL JOINT SEE 1/S20 PIPE THROUGH WAL SLAB STEP

ARCHITECTS | DESIGNERS | ENGINEERS JEST RULLINGW ONDER, SUITE SIGN, BLOOMINGTON, NI STATES P. 6551-4561 THE POPERIOR SIGN PARKS BEIDENIED ON PERSONAL SIGNAL SIGNA

FOUNDATION PLAN
1/8" = 1'-0"

PLAN NOTE:

- 1. SEE 1 / S20 FOR TYPICAL SLAB CONTROL JOINT DETAIL.
- 2. SEE 2 / S20 FOR TYPICAL SLAB CONSTRUCTION JOINT DETAIL.
- SEE 7 / S20 R 9 / S20 FOR TYPICAL CORNER REINFORCING AT WALLS AND FOOTINGS.
- 4. SEE11 / S20 FOR TYPICAL REINFORCING AT WALL INTERSECTIONS.
 5. SEE 3 / S20 FOR TYPICAL WALL CONSTRUCTION JOINT DETAIL.
- 6. SEE 4 / S20 FOR TYPICAL WALL CONTROL JOINT DETAIL.
- SEE 8 / S20 FOR TYPICAL RE-ENTRANT CORNER SLAB REINFORCEMENT AT PIERS.
- 8. ON PLAN INDICATES HAIRPIN TIE, SEE PLAN & DETAILS FOR SIZE & LENGTH.
- 9. TYPICAL TOP OF FOOTING ELEVATION (TFE) = 95'-0" UNO ON PLAN.
- 10. TOP OF CONCRETE ELEVATION (TCE) = 100'-0" UNO (DATUM
- 11. TYPICAL TOP OF PIER ELEVATION (TPE) = 100'-0" UNO ON PLAN.
- 12. TYPICAL FOUNDATION WALL SHALL BE 8" CONCRETE REINFORCED WITH #4 @ 12"OC EACH WAY, UNO ON PLAN.
- 13. TYPICAL FOUNDATION WALL FOOTING SHALL BE 2'-0"W x 1'-0"D REINFORCED WITH (2) #5 BOTTOM CONTINUOUS UNG ON PLAN.
- CONTRACTOR TO VERIFY TOP OF WALL ELEVATIONS AND STEP LOCATIONS WITH FINAL GRADES.
- 15. SEE ARCH FOR CONCRETE SLAB FLOOR FINISH INFORMATION.

PIER SCHEDULE					
MARK	SIZE	REINFORCING	REMARKS		
P1	24×26	(12) #6 VERT BARS W/ STD HOOK INTO FTG	SEE PLAN FOR PIER DETAILS		
P2	16×28	(10) #6 VERT BARS W/ STD HOOK INTO FTG	SEE PLAN FOR PIER DETAILS		
P3	20 x 28	(10) #6 VERT BARS W/ STD HOOK INTO FTG	SEE PLAN FOR PIER DETAILS		
P4	20 x 24	(10) #5 VERT BARS W/ STD HOOK INTO FTG	SEE PLAN FOR PIER DETAILS		

PIER SCHEDULE NOTES:

1. SEE 17 / S20 FOR TYPICAL PIER REINFORCEMENT LAYOUT DETAILS.

FOOTING SCHEDULE				
MARK	SIZE	REINFORCING		
F4	4'-0"x4'-0"x1'-6"	*		
F5A	5'-0"x5'-0"x1'-6"	*		
F5B	5'-0"x5'-0"×1'-0"	(6) #6 BOTT EA WAY		


* EXTEND WALL FOOTING REINFORCEMENT INTO SPREAD FOOTING


FOUNDATION PLAN

PROJECT: 24021
DRAWN BY: CAF
CHECKED BY: CAF
DATE: 4/5/2024
REVISIONS:

BOAT STORAGE BUILDING MADELINE ISLAND WATER COMPANY 75 MARINA DRIVE WASHBURN, WI 54891

PERMIT SET

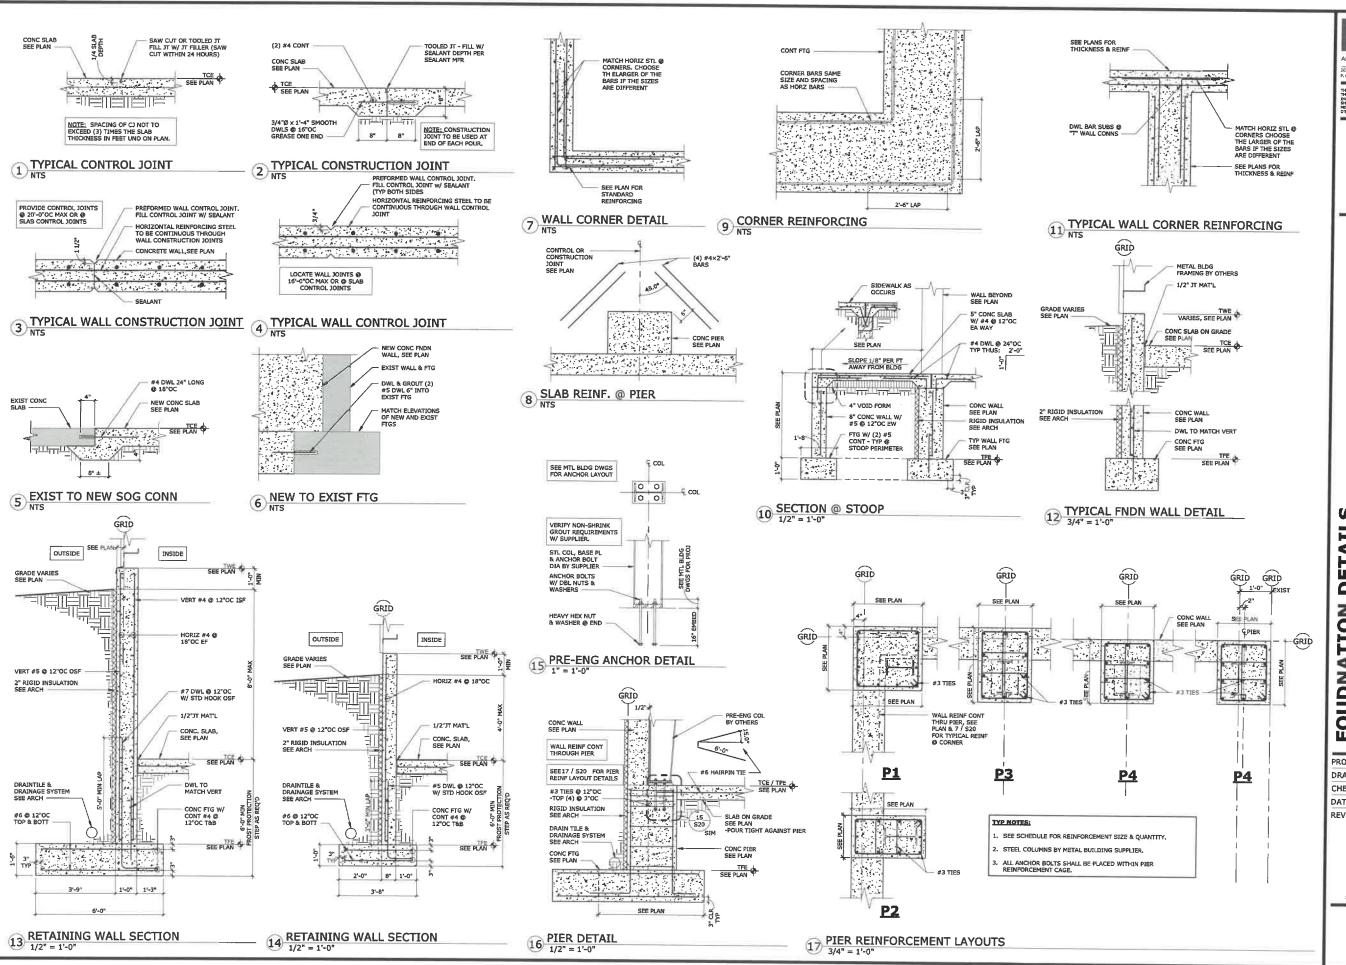


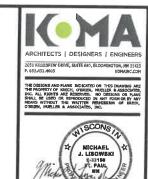

DETAIL **FOUDNATION**

BOAT STORAGE BUILDING MADELINE ISLAND WATER 75 MARINA DRIVE WASHBURN, WI 54891 PROJECT: 24021 DRAWN BY: CAF CHECKED BY: CAF DATE: 4/5/2024 REVISIONS:


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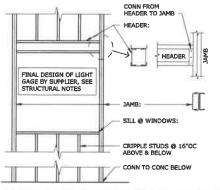
1/2" = 1'-0"

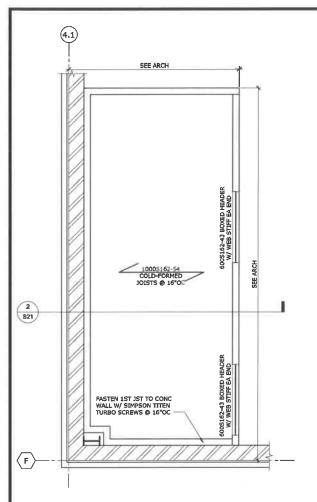PLAN NOTES:


- 1. INDICATES FLOOR DIRECTION. THE FLOOR CONSTRUCTION SHALL BE FIRE TREATED 49/24 (23/32") APA RATED WOOD SHEATHING. ATTACH SHEATHING TO FLOOR JOISTS W/ #6 TYPE S BUGLEHEAD SCREWS @ 6"CC EDGE, 12"CC FIELD, TYP. SHEATHING SCREWS SHALL HAVE A MINIMUM 0,292"Ø HEAD W/ SUFICIENT LENGTH TO PENETRATE THROUGH THE STEEL BY AT LEAST (3) EXPOSED THREADS.
- 2. TYPICAL METAL STUD WALL SHALL BE 362S162-43 @ 16"OC.
- TYPICAL JAMB AT WALL OPENINGS SHALL CONSIST OF (2) 16GA (1 5/8" FLANGE) METAL STUD TRIMMERS & (1) 16GA (1 5/8" FLANGE) METAL KING STUD, STUD DEPTH SHALL MATCH WALL STUD DEPTH.
- 4. SEE DETAIL 3 / S21 FOR FRAMING @ PUNCHED OPENINGS & 4 / S21 FOR LATERAL BRACING.
- 5. SEE DETAIL 5 / S21 FOR BOXED HEADER FRAMING @ JAMB.
- 6. SEE DETAIL 6 / S21 FOR TYPICAL JOIST BLOCKIGN DETAIL.
- SEE ARCHITECTURAL DRAWING FOR THE SIZE AND LOCATION OF ALL WALL OPENINGS.
- ALL METAL POSTS & TRIMMERS TO BE CONTINUOUS TO FOUNDAITON BELOW.
- COORDINATE ALL OPENINGS WITH ARCHITECTURAL AND MECHANINCAL DRAWINGS.




2 SECTION 3/4" = 1'-0"

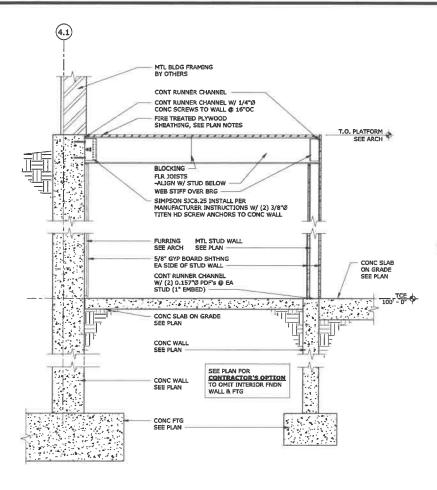


3 LIGHT GAGE FRAMING @ PUNCHED OPENING 3/8" = 1'-0"

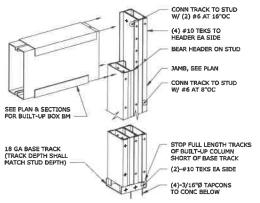

5) LIGHT GAGE FRAMING DETAIL
1 1/2" = 1'-0"

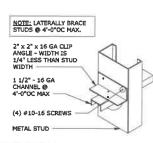

TYPICAL LATERAL BRACING

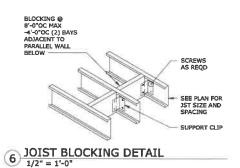

BOAT STORAGE BUILDING MADELINE ISLAND WATER COMPANY 75 MARINA DRIVE WASHBURN, WI 54891

ARCHITECTS | DESIGNERS | ENGINEER

651 KILLEBREW DRIVE, SUITE 680, BLOOMINGTON, MR 554

PROJECT: 24021
DRAWN BY: CAF
CHECKED BY: CAF
DATE: 4/5/2024
REVISIONS:

PERMIT SET

S21

FRAMING PLAN & DETAILS