

August 14, 2020

Mr. Tim Schwecke
Town of Eagle
820 E. Main Street
Eagle, WI 53119

**RE: Dollar General Store
Preliminary Plan Review for Dollar General
Eagle, Wisconsin**

Dear Mr. Schwecke,

We are in response to multiple sets of review comments provided by the Town of Eagle regarding the proposed Dollar General Store located at the northeast corner of County Highway NN and Godfrey Lane. Received correspondence include:

- **Engineering Review Memo** by Lynch and Associates; dated **August 4th, 2020**
- **Staff Report** on the Proposed Site Plan and Plan of Operations; dated July 30, 2020
- **Staff Report** on the Proposed Certified Survey Map; dated **July 30, 2020**

In addition to the correspondence received above, Kimley-Horn has also provided responses to the site plan, landscape plan, and architectural comments discussed at the Plan Commission Meeting on August 3, 2020. Below is a summary of the actions taken in response to these comments.

Engineering Review Memo by Lynch and Associates; dated August 4th, 2020

1. The legend indicates the areas of the standard asphalt and heavy-duty asphalt. Please provide the corresponding pavement cross sections. Also, provide details for the sidewalk.
Response: Pavement sections for asphalt and sidewalk have been included on sheet C7.0.
2. Verify the building FFE. The plan elevation and cross section elevation are different.
Response: The FFE is 921.50, which has been corrected on the Plan and Cross Section on Sheet C5.0.
3. The top of curb and flowline elevations appear to be reversed along the front edge of the walk.
Response: Top of curb and flowline elevations have been revised to show correct values. See Sheet C5.0.
4. Label proposed pipe with pipe diameter, pipe type, and length on C2.0.
Response: Sanitary and storm pipes have been labeled accordingly, see Sheet C6.0.
5. The sidewalk along the building is less than 1% in slope and the slope should be increased to provide better drainage away from the building.
Response: The proposed sidewalk grades along the building have been revised to increase the slope to a value greater than 1%, but less than 2.0%. See sheet C5.0.
6. The drainage away from the rear of the building does not meet requirements of SPS 321.12.
Response: The drainage away from the rear of the building has been increased above 0.5" per 12" (4.167%) for at least the first 10 feet. See Sheet C5.0.

7. Add soil boring locations to the pond.
Response: A geotechnical report performed by Terracon Consultants, Inc. dated August 5, 2020 has been included with this resubmittal.
8. It appears that fill is being placed on the septic area. Will it be a mound system or conventional?
Response: The septic field will be a conventional system. The grading has been revised to avoid fill in the septic area (<6" with no compaction).
9. The pond discharge pipe in the CTH NN right of way is lower than the ditch grades shown to the east and west. It appears the ditch run off could backflow into the pond.
Response: Based on the field survey, the ditch flows from West to East. The detention pond normal water elevation is 916.50, the outlet to the ditch is 916.40, and then ditch flows east as shown by the 916.30 spot located at the southeast corner. The detention pond normal water level was set 0.1' above the ditch to avoid additional fill on site.
10. Any work in the CTH NN right of way will require a permit from Waukesha County. Please provide a copy of the permit once it has been received.
Response: Comment noted. The Site Plan and CSM has been sent to Waukesha County for review. Future correspondence will be sent to the Town.
11. Provide an erosion control plan with accompanying details.
Response: The Erosion Control Plan and Details are included in sheet C4.0 and C4.1 of the Final Engineering Plans.
12. Add water service size and roof drain size along with the sizing calculations.
Response: The water service has been sized as a 1.5-inch Type-K Copper line and has been labeled on the Utility Plan, See Sheet C6.0. The roof drains are sized at 6-inches, sizing calculations have been provided in the Drainage Report attached with this resubmittal.
13. The invert for D1 in the structure table differs from the invert labeled on C2.0..
Response: The outfall invert for structure D1 has been revised for consistency on the Utility Plan and Grading Plan.
14. Note 12 in the utility notes state light poles are shown. Please add light pole locations to the site plan.
Response: Light poles and their locations have been added to the Site Plan (C3.0) and Utility plan (C6.0).
15. Notes 17, 19, and 20 reference Kenosha Water Utility. Please revise the reference.
Response: Notes 17, 19 and 20 have been removed from the Utility Notes.
16. Provide details for the pond outlet structure, manholes, inlets and rip rap.
Response: Construction details for utility structures and rip rap have been provided on sheet C7.0 and C7.1 of the Final Engineering Plans

Staff Report on the Proposed Site Plan and Plan of Operations; dated July 30, 2020

1. The property owner must reimburse the Town for any and all fees paid by the Town for technical assistance in reviewing and enforcing this approval. Such payments shall be paid upon request of the Town. The Town Clerk's office shall provide owner/applicant with itemized invoices.
Response: Comment Noted.

2. The applicant must submit details for the dumpster enclosure, meeting code requirements, to the Town Planner for review and approval.
Response: Per discussion at Plan Commission, the Dumpster Enclosure will be enhanced to masonry, which is noted on the Site Plan, Sheet C3.0. Dumpster Enclosure details will be submitted with the building permit application.
3. The applicant must provide documentation to the Town Planner to ensure that all light fixtures are full-cut off.
Response: Standard Dollar General light specifications have been provided for the Town Planner's Review.
4. The property owner obtains a zoning permit for the approved building within 6 months of this date.
Response: Comment Noted.
5. The property owner obtains a building permit for the approved building within 9 months of this date and completes the authorized work within one year of obtaining the permit.
Response: Comment Noted.
6. The property owner obtains all other approvals as may be required to construct the building as planned (e.g., fire department review).
Response: Comment Noted.

Staff Report on the Proposed Certified Survey Map; dated July 30, 2020

1. Include a vision triangle at the intersection of CTH NN.
Response: Per coordination with Waukesha County, the Vision Triangle will be measure 150 ft along the centerline of Highway NN and 100 ft along the centerline of Godfrey Lane. The Vision Triangle has been added to the Site Plan, Landscape Plan, and CSM.
2. Include a no-access restriction on CTH NN.
Response: The restriction has been added to the CSM.
3. Add a signature block for the Village of Eagle because the subject property is located within the Village's extraterritorial review authority (i.e., 1.5 miles).
Response: The Village of Eagle signature block has been added to the CSM.

Plan Commission Comments; August 3, 2020

Building Elevations

1. Provide Masonry building materials on the east elevation.
Response: All four elevations of the building are now masonry – see revised elevations.
2. Provide pilasters on the east elevation to break up the façade.
Response: Vertical elements and pilasters have been provided on the revised building elevations.
3. Provide a parapet wall on the east elevation.
Response: A parapet wall has been provided on the east elevation. – See revised elevations.
4. Provide 8" deep by 12" wide pilasters per Town Code.
Response: The necessary depth and width of pilasters has been provided – See Site Plan.

5. Move the entry door on the west elevation to encourage parking on the west side of the building.
Response: The entry door has been moved to the west elevation – See Site Plan.

Site Plan/Landscape Plan

1. The Dumpster enclosure needs to be masonry given its visibility from the street.
Response: A masonry dumpster has been proposed. See Site Plan. Materials to match the proposed architectural elevations.
2. Provide a ‘vision triangle’ at the corner and adjust the Pylon Sign accordingly. (distance to be confirmed with County)
Response: The vision triangle dimensions have been confirmed with Waukesha County and shown on the site plan accordingly.
3. Provide additional plantings with pine trees on the West Elevation.
Response: The landscape plan has been revised accordingly – See Sheet L1.0.
4. Provide additional screening for the parking lot along County NN.
Response: The landscape plan has been revised accordingly – See Sheet L1.0.


Photometrics

1. Provide cut sheets of the light poles and light pole fixtures.
Response: Cut sheets have been provided with this submittal.
2. Provide “cut offs/shields” to limit light pollution.
Response: Cut sheets have been provided with this submittal for the Town’s review.
3. Dim/Turn off lights after hours of operation, for safety and light pollution.
Response: A dimmer switch will be provided as part of the lighting plan.

We trust these responses and the description of changes above adequately address your comments. If you have any questions or require any additional information, please contact me at 630-487-5563.


Sincerely,

Joseph Mayer
Kimley-Horn and Associates, Inc.
Phone: 630-487-5563
Email: Joe.mayer@kimley-horn.com

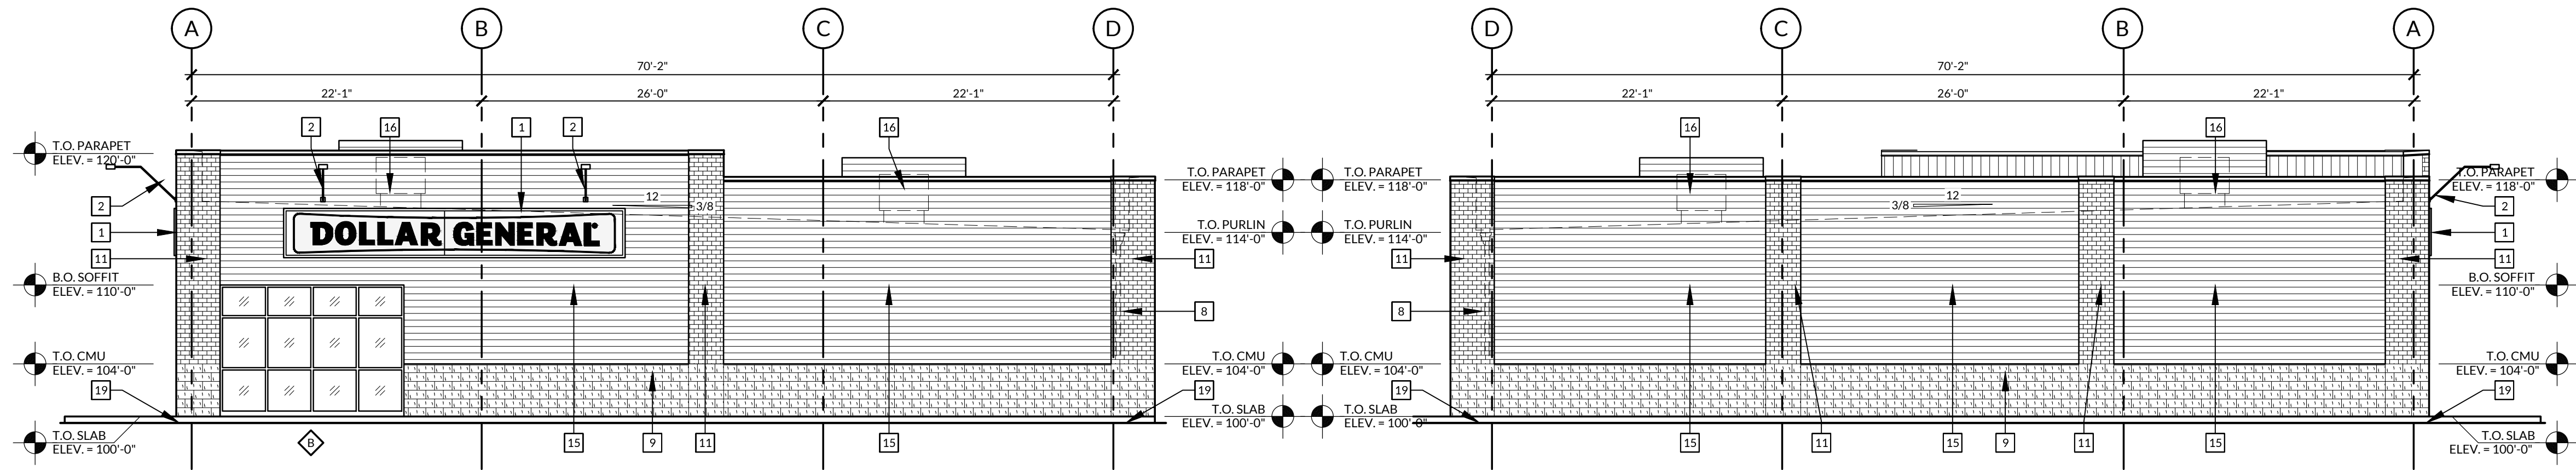


1 SOUTH ELEVATION
SCALE: 1/8"=1'-0"

2 NORTH ELEVATION
SCALE: 1/8"=1'-0"

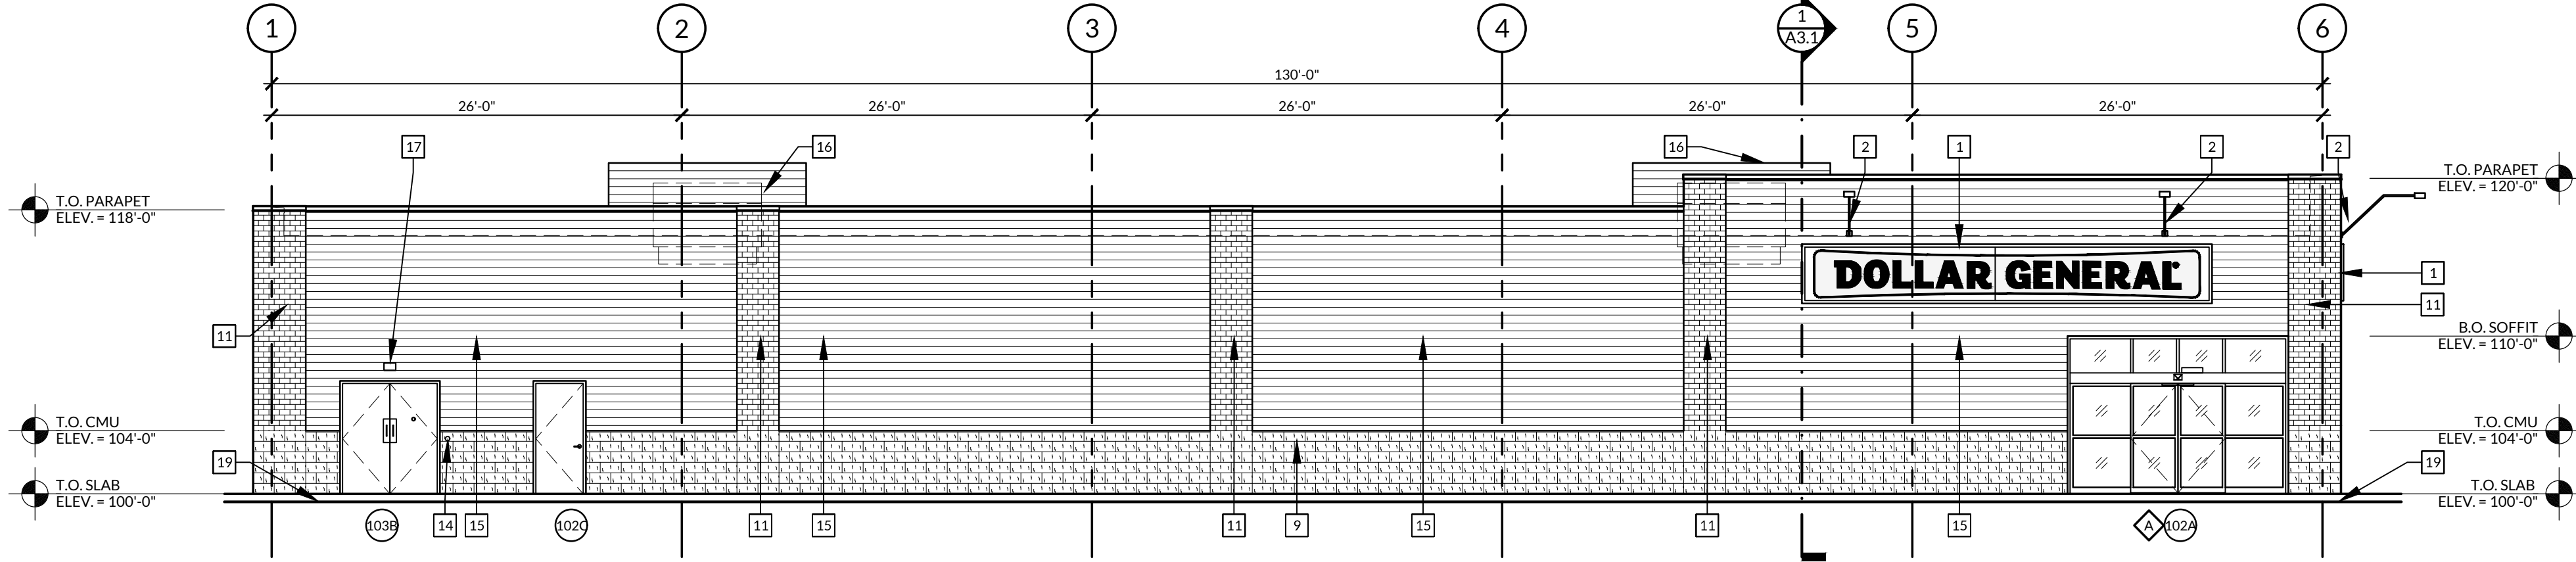


3 WEST ELEVATION
SCALE: 1/8"=1'-0"

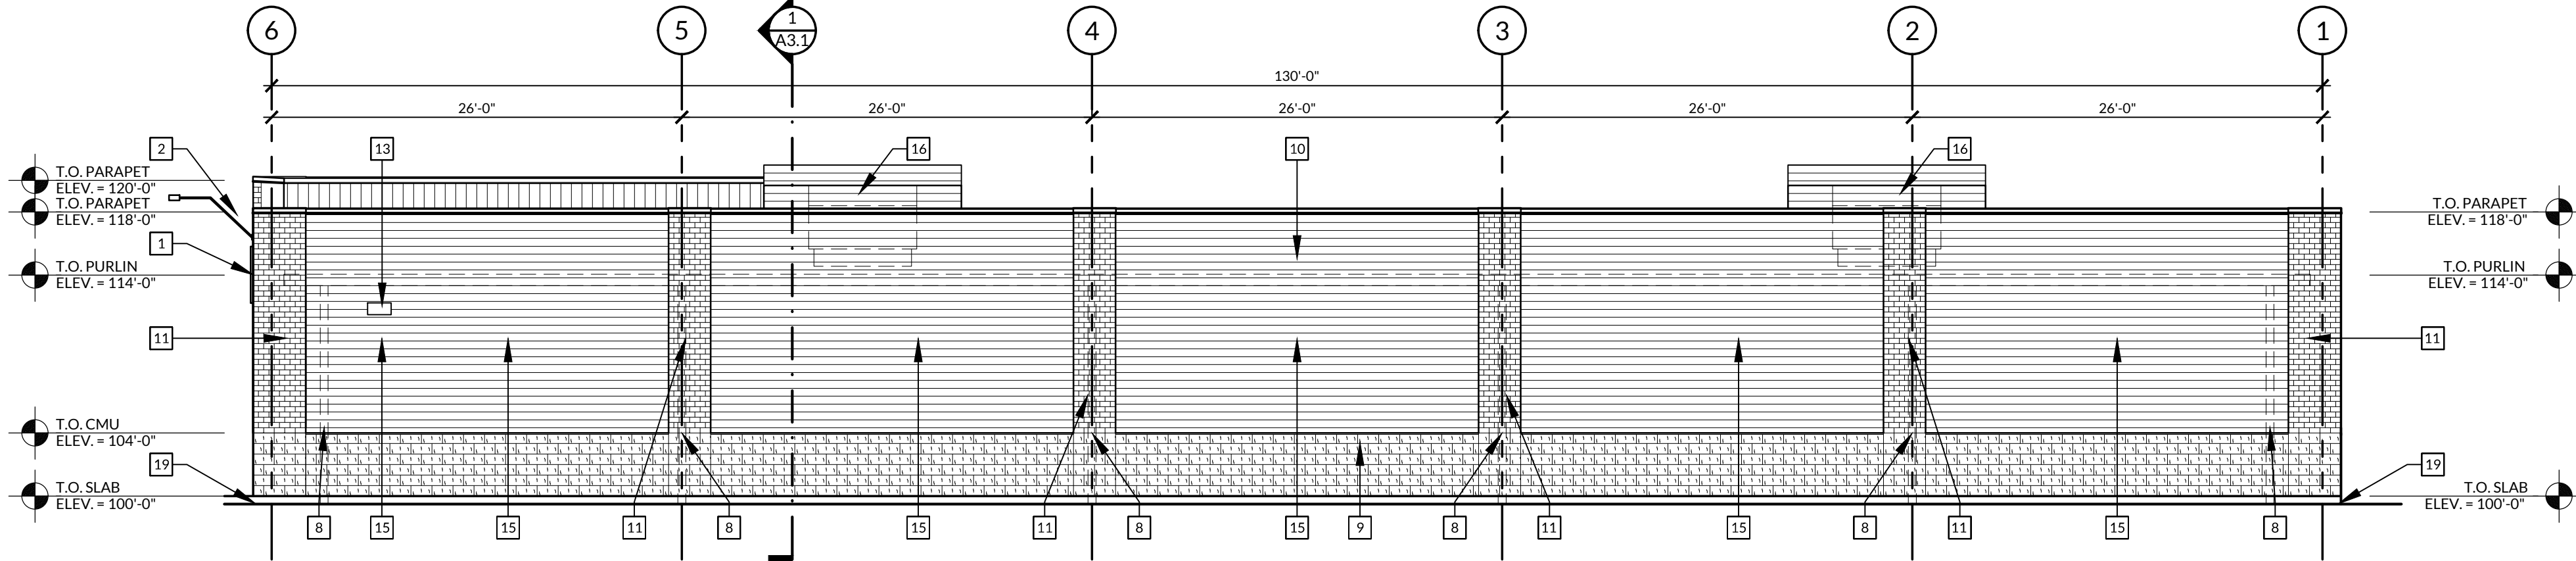

4 EAST ELEVATION
SCALE: 1/8"=1'-0"

ELEVATION KEYNOTES

- 1 SIGN FURNISHED & INSTALLED BY DOLLAR GENERAL CORPORATION. SIGN SHALL BE LIGHTED FROM ABOVE. CONTRACTOR IS TO PROVIDE ADEQUATE BLOCKING AS REQUIRED BY SIGN MANUFACTURER TO SUPPORT SIGN WEIGHT OF UP TO 1,400 LBS. COORDINATE THE PROPER SIGNAGE TO BE USED w/ DOLLAR GENERAL.
- 2 EXTERIOR LIGHTING. REFER TO ELECTRICAL DRAWINGS TO VERIFY EXACT QUANTITY, LOCATION, MOUNTING HEIGHT & OTHER SPECIFICATIONS.
- 3 NOT USED.
- 4 NOT USED.
- 5 NOT USED.
- 6 NOT USED.
- 7 NOT USED.
- 8 GUTTER & DOWNSPOUT. REFER TO EXTERIOR FINISH SCHEDULE FOR COLOR.
- 9 4" SPLIT-FACE CMU. REFER TO EXTERIOR FINISH SCHEDULE FOR TYPE & COLOR.
- 10 STANDING SEAM METAL ROOF. REFER TO EXTERIOR FINISH SCHEDULE FOR COLOR.
- 11 4" SMOOTH or VELOUR ECONOMY SIZE BRICK. REFER TO EXTERIOR FINISH SCHEDULE FOR COLOR.
- 12 NOT USED.
- 13 VENT FOR BATHROOM EXHAUST. REFER TO MECHANICAL DRAWINGS FOR EXACT LOCATION & ADDITIONAL INFORMATION.
- 14 DOOR BUZZER. REFER TO ELECTRICAL DRAWINGS FOR ADDITIONAL INFORMATION.
- 15 NICHIIHA VINTAGEWOOD ARCHITECTURAL PANELS. REFER TO EXTERIOR FINISH SCHEDULE FOR COLOR.
- 16 HVAC UNITS MOUNTED ON ROOF. REFER TO MECHANICAL DRAWINGS FOR ADDITIONAL INFORMATION & LOCATIONS. UNITS TO BE SCREENED FROM VIEW. SCREEN TO BE CITYSCAPES, INC. "ENVISOR SCREENING SYSTEM" or APPROVED EQUAL.
- 17 OUTSIDE AIR TEMP. SENSOR MOUNTED OVER RECEIVING DOORS @ 8'-0" A.F.F.
- 18 MINIMUM EAVE HEIGHT IS 14'-0" A.F.F.
- 19 FINISHED GRADE AT EXTERIOR WALLS SHALL BE A MINIMUM OF 6" BELOW FINISHED FLOOR AT ALL NON-PAVED AREAS.
- 20 NOT USED.

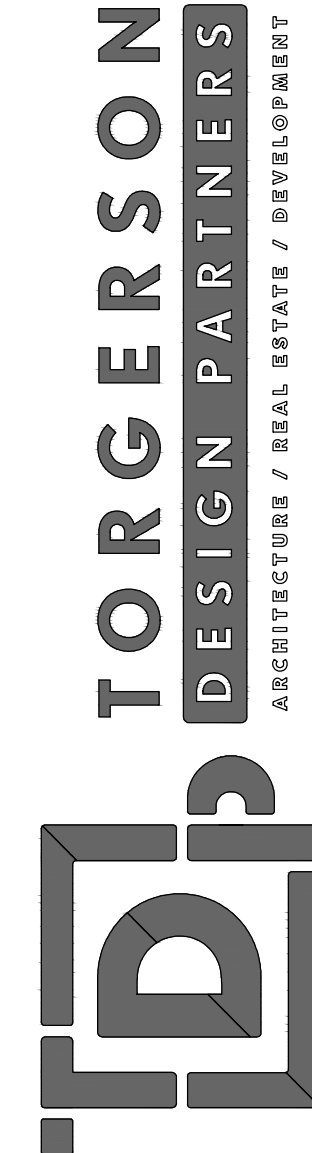

STORE #22466 • PROTOTYPE "E"
EAGLE, WISCONSIN
NORTHEAST CORNER OF HIGHWAY NN & GODFREY LANE/LEEDS DRIVE
EAGLE, WAUKESHA COUNTY, WISCONSIN 53119

DOLLAR GENERAL

STORE #22466 • PROTOTYPE "E"

EAGLE, WISCONSIN

NORTHEAST CORNER OF HIGHWAY NN & GODFREY LANE/LEEDS DRIVE
EAGLE, WAUKESHA COUNTY, WISCONSIN 53119

EXTERIOR FINISH SCHEDULE																															
PRE-ENGINEERED METAL BUILDING VENDOR:	VP BUILDINGS ATTN:DAVID ENGLISH (901) 568-4537					STAR BUILDING SYSTEMS ATTN:RODNEY BURT (800) 879-7827					NUCOR BUILDING SYSTEMS ATTN:BOB BARRY (315) 622-4440 - (260) 837-7891					BIGBEE STEEL BUILDINGS, INC. ATTN:KEVIN BUSLER (800) 633-3378					CHIEF BUILDINGS ATTN:KIRIN SULLIVAN (800) 845-3378					PREFERRED COLORS IF ALTERNATE EXTERIOR MATERIALS ARE USED INSTEAD OF METAL PANELS:					
EXTERIOR FINISHES ARE TO MATCH or BE EQUAL TO VP METAL BUILDING SYSTEM'S FINISH SELECTION.	COOL EGYPTIAN WHITE	COOL DARK BRONZE	BRONZE	COOL COTTON WHITE	GALVALUME	LIGHTSTONE	MEDIUM BRONZE, KYMAR 500	BRONZE	POLAR WHITE	GALVALUME	LIGHTSTONE	MEDIUM BRONZE, KYMAR 500	BRONZE	POLAR WHITE	GALVALUME	SANDSTONE	BURNISHED SLATE	BRONZE	POLAR WHITE	GALVALUME	PARCHMENT	ANTIQUE BRONZE	BRONZE	POLAR WHITE	GALVALUME	SHERWIN WILLIAMS SW7037 "BALANCED BEIGE	SHERWIN WILLIAMS SW7037 "VINTAGE BROWN"	BRONZE	WHITE BY PEMB MANUFACTURER	GALVALUME	
GUTTERS.		●					●					●					●					●					●				
DOWNSPOUTS.		●					●					●					●					●					●				
SIDE & REAR METAL WALL PANELS & TRIM, RECEIVING & EMERGENCY EXIT DOORS. (EXTERIOR OF DOORS TO BE PAINTED. REFER TO DOOR SCHEDULE.)		●					●					●					●					●					●				
4" SPLIT-FACE CMU	MIDWEST BLOCK or EQUAL. COLOR: TBD.					MIDWEST BLOCK or EQUAL. COLOR: TBD.					MIDWEST BLOCK or EQUAL. COLOR: TBD.					MIDWEST BLOCK or EQUAL. COLOR: TBD.					MIDWEST BLOCK or EQUAL. COLOR: TBD.					MIDWEST BLOCK or EQUAL. COLOR: TBD.					
4" SMOOTH or VELOUR ECONOMY SIZE BRICK.	ACME BRICK or EQUAL. COLOR: TBD.					ACME BRICK or EQUAL. COLOR: TBD.					ACME BRICK or EQUAL. COLOR: TBD.					ACME BRICK or EQUAL. COLOR: TBD.					ACME BRICK or EQUAL. COLOR: TBD.					ACME BRICK or EQUAL. COLOR: TBD.					
NICHIIHA FIBER CEMENT PANEL.	SERIES: VINTAGEWOOD. COLOR: REDWOOD.					SERIES: VINTAGEWOOD. COLOR: REDWOOD.					SERIES: VINTAGEWOOD. COLOR: REDWOOD.					SERIES: VINTAGEWOOD. COLOR: REDWOOD.					SERIES: VINTAGEWOOD. COLOR: REDWOOD.					SERIES: VINTAGEWOOD. COLOR: REDWOOD.					
FLAT METAL SOFFIT AT STOREFRONT VESTIBULE AREA.			●					●					●					●					●					●			
BUILDING FASCIA WALL, PARAPET or ENTRANCE, & CANOPY.		●					●					●					●					●					●				
STOREFRONT SYSTEM.			●					●					●					●					●					●			
STANDING SEAM METAL ROOF PANELS.					●					●					●					●					●						●
LINER PANELS (INTERIOR SALES & RECEIVING FLOOR)			●						●					●					●				●					●			

ARCHITECT OF RECORD:
KYLE W. RADER
ARCHITECTURAL LICENSE #:
12667-5

PROJECT NUMBER:
20147 · DGEW

REVISION:

PRELIMINARY
NOT FOR CONSTRUCTION

A2.1
EXTERIOR
ELEVATIONS

DATE: JULY 16, 2020

Drawing name: K:\GIS\LDE\168708007_DollarGeneral_Eagle_WI\2_Design\CAD\PlanSheets\Final Engineering\00.0 - TITLE SHEET.dwg 00.0 Aug 17, 2020 9:02am by: brett.hickey
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FINAL ENGINEERING PLANS

DOLLAR GENERAL

NEC HIGHWAY NN & GODFREY LANE

TOWN OF EAGLE, WISCONSIN 53119



UTILITY AND GOVERNING AGENCY CONTACTS

PLANNING & ZONING DEPARTMENT
TOWN OF EAGLE
820 E. MAIN STREET
EAGLE, WI 531199
TEL: (920) 728-2814
CONTACT: TIM SCHWECKE

ENGINEERING DEPARTMENT
TOWN OF EAGLE
820 E. MAIN STREET
EAGLE, WI 531199
TEL: (262) 402-5040
CONTACT: TIM LYNCH

STORM SEWER SERVICE
TOWN OF EAGLE
820 E. MAIN STREET
EAGLE, WI 531199
TEL: (262) 594-5800

WATER/SANITARY SERVICE
PRIVATE WELL & SEPTIC

ROADWAY AUTHORITY
WAUKESHA COUNTY
515 W MORELAND BLVD, AC220
WAUKESHA, WI 53188
TEL: (262) 548-7740

POWER COMPANY
WE ENERGIES
S13 W33800 US-18
DELAFIELD, WI 53018
TEL: (262) 968-2575

NATURAL GAS COMPANY
WE ENERGIES
S13 W33800 US-18
DELAFIELD, WI 53018
TEL: (262) 968-2575

TELEPHONE
AT&T
TEL: (853) 293-7676

PROJECT TEAM

DEVELOPER
THE OVERLAND GROUP
1903 EAST BATTLEFIELD ST.
SPRINGFIELD, MO 65804
TEL: (417) 293-3332
CONTACT: JACOB W. STAUFFER

ARCHITECT
TORGERSON DESIGN PARTNERS
116 N. 2ND AVE.
OZARK, MO 65721
TEL: (417) 581-8889
CONTACT: MIKE SEBBEN

SURVEYOR
CHAPUT LAND SURVEYS
234 W. FLORIDA STREET
MILWAUKEE, WI 53204
TEL: (414) 224-8068
CONTACT: DONALD CHAPUT


CIVIL ENGINEER
KIMLEY-HORN AND ASSOCIATES, INC.
4201 WINFIELD ROAD, SUITE 600
WARRENVILLE, IL 60555
TEL: (630) 487-5550
EMAIL: JOE.MAYER@KIMLEY-HORN.COM
CONTACT: JOE MAYER,
EMAIL: JUSTIN.MULLER@KIMLEY-HORN.COM
CONTACT: JUSTIN MULLER, P.E.

LANDSCAPE ARCHITECT
KIMLEY-HORN AND ASSOCIATES, INC.
4201 WINFIELD ROAD, SUITE 600
WARRENVILLE, IL 60555
TEL: (630) 487-5550
EMAIL: DANIEL.GROVE@KIMLEY-HORN.COM
CONTACT: DANIEL GROVE

GEOTECH
TERRACON CONSULTANTS, INC.
9856 SOUTH 57TH STREET
FRANKLIN, WI 53132
TEL: (414) 423-0255
PAUL J. KOSZAREK, P.E.
CONTACT: DANIEL GROVE

LEGAL DESCRIPTION

PART OF LOT 1 OF CERTIFIED SURVEY MAP NO. 8689, IN THE SOTHEAST 1/4 OF THE NORTHWEST 1/4 OF SECTION 23, TOWNSHIP 5 NORTH, RANGE 17 EAST, IN THE TOWN OF EAGLE, WAUKESHA COUNTY, WISCONSIN, RECORDED DECEMBER 17, 1998 IN THE OFFICE OF THE REGISTER OF DEEDS FOR WAUKESHA COUNTY, IN VOLUME 77 OF CERTIFIED SURVEY MAPS ON PAGES 47, 48 AND 49, AS DOCUMENT NO. 239997, TOGETHER WITH ALL MINERAL RIGHTS CLAIMED THEREIN UNDER STATMENT OF MINERAL CLAIM RECORDED MAY 24, 2002 AS DOCUMENT NO. 2804813.

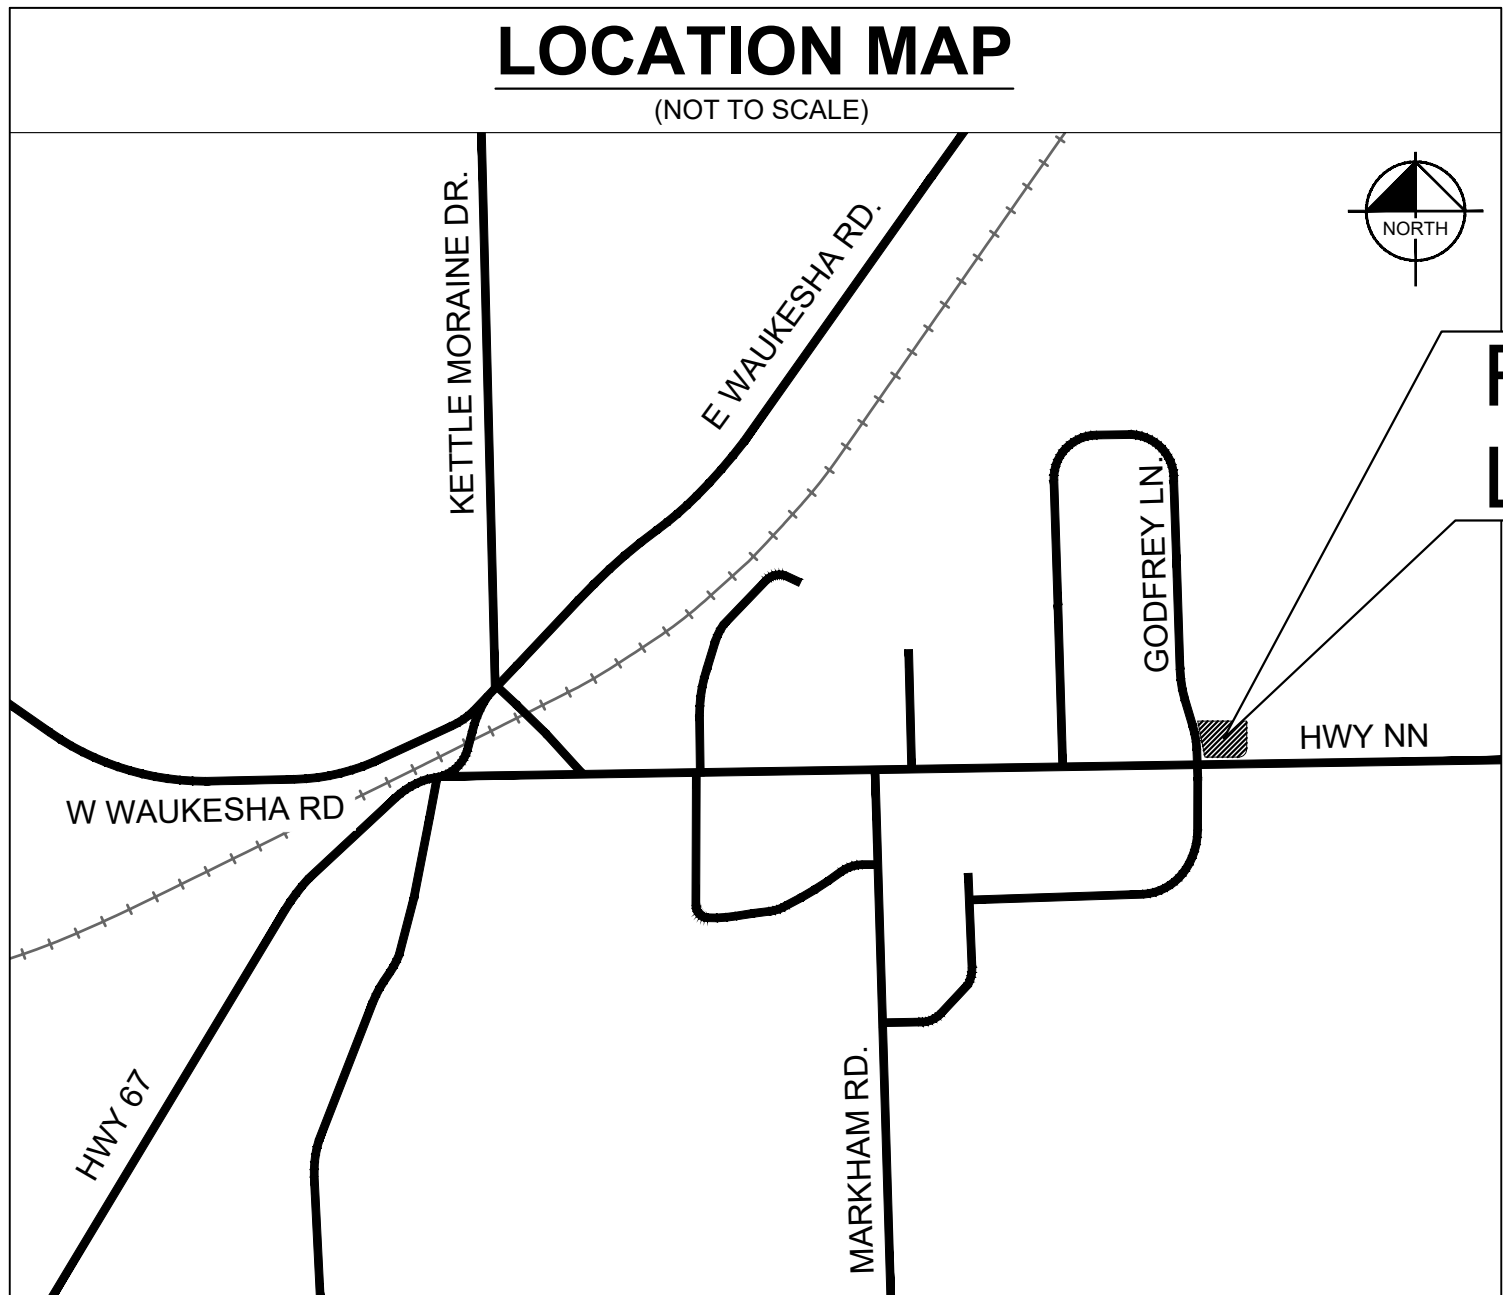

PROJECT
LOCATION

BENCHMARKS

SITE BENCHMARKS:
(LOCATIONS SHOWN ON SURVEY)

STARTING BENCHMARK: REFERENCE MARK AND REFERENCE BENCHMARK FOUND CHISELED CROSS IN TOP OF THE HYDRANT NOZZLE.
ELEVATION=927.61 (NGVD 29)

SITE BENCHMARK: NW FLANGE BOLT ON HYDRANT.
ELEVATION=920.34 (NGVD 29)

SITE BENCHMARK: SET CROSS ON NE COR. OF CONC. PAD.
ELEVATION=924.76 (NGVD 29)

Sheet List Table	
Sheet Number	Sheet Title
C0.0	COVER SHEET
V0.0	ALTA SURVEY
C1.0	GENERAL NOTES
C2.0	DEMOLITION PLAN
C3.0	SITE PLAN
C4.0	EROSION CONTROL PLAN
C4.1	EROSION CONTROL NOTES & DETAILS
C5.0	GRADING PLAN
C6.0	UTILITY PLAN
C7.0	CONSTRUCTION DETAILS
C7.1	CONSTRUCTION DETAILS
L1.0	LANDSCAPE PLAN
L2.0	LANDSCAPE NOTES AND DETAILS

PROFESSIONAL ENGINEER'S CERTIFICATION

I, JUSTIN MULLER, A LICENSED PROFESSIONAL ENGINEER OF WISCONSIN, HEREBY CERTIFY THAT THIS SUBMISSION, PERTAINING ONLY TO THE "C" SERIES CIVIL SHEETS LISTED ABOVE BUT EXCLUDING DETAILS PREPARED BY OTHERS, WAS PREPARED ON BEHALF OF THE OVERLAND GROUP BY KIMLEY-HORN AND ASSOCIATES, INC. UNDER MY PERSONAL DIRECTION. THIS TECHNICAL SUBMISSION IS INTENDED TO BE USED AS AN INTEGRAL PART OF AND IN CONJUNCTION WITH THE PROJECT SPECIFICATIONS AND CONTRACT DOCUMENTS.

DATED THIS 14TH DAY OF AUGUST, A.D., 2020.

Justin Muller
WISCONSIN LICENSED PROFESSIONAL ENGINEER E-40596
MY LICENSE EXPIRES ON JULY 31, 2020



DOLLAR GENERAL

NEC HIGHWAY NN & GODFREY LN.
TOWN OF EAGLE, WI 53119

COVER SHEET

THE OVERLAND
GROUP

Kimley»Horn

© 2020 KIMLEY-HORN AND ASSOCIATES, INC.
4201 WINFIELD ROAD, SUITE 600
WARRENVILLE, IL 60555
PHONE: 630-487-5550
WWW.KIMLEY-HORN.COM



SCALE:	AS NOTED
DESIGNED BY:	JPM
DRAWN BY:	JPM
CHECKED BY:	JMM

No.	1
REVISIONS	
TOWN	COMMENTS
DATE	08/14/20
BY	JPM



ORIGINAL ISSUE:
07/29/2020
KHA PROJECT NO.
168708007
SHEET NUMBER

C0.0

	A	B	C	D	E	F	G	H	I	J	K	L	M	N	O	P	Q	R	S	T	U	V	W	X	Y	Z	AA	AB	AC	AD	AE	AF
	GENERAL NOTES																															
1	1. EXISTING SITE TOPOGRAPHY, UTILITIES, RIGHT-OF-WAY AND HORIZONTAL CONTROL SHOWN ON THE DRAWINGS WERE OBTAINED FROM A SURVEY PREPARED BY: CHAPUT LAND SURVEYS 234 W. FLORIDA STREET MILWAUKEE, WI 53204 TEL: (414) 224-8088																															
2	COPIES OF THE SURVEY ARE AVAILABLE FROM THE ENGINEER. SITE CONDITIONS MAY HAVE CHANGED SINCE THE SURVEY WAS PREPARED. CONTRACTORS TO VISIT SITE TO FAMILIARIZE THEMSELVES WITH THE CURRENT CONDITIONS.																															
3	2. COPIES OF SOILS INVESTIGATION REPORTS MAY BE OBTAINED FROM THE OWNER, ANY BRACING, SHEETING OR SPECIAL CONSTRUCTION METHODS DEEMED NECESSARY BY THE CONTRACTOR IN ORDER TO INSTALL THE PROPOSED IMPROVEMENTS SHALL BE CONSIDERED INCIDENTAL TO THE COST OF THE PROJECT. ANY ADDITIONAL SOILS DATA NEEDED TO CONFIRM THE CONTRACTOR'S OPINIONS OF THE SUBSOIL CONDITIONS SHALL BE DONE AT THE CONTRACTOR'S EXPENSE. THE CONTRACTOR SHALL OBTAIN THE OWNER'S WRITTEN AUTHORIZATION TO ACCESS THE SITE TO CONDUCT A SUPPLEMENTAL SOILS INVESTIGATION.																															
4	3. THE CONTRACTOR SHALL PHOTOGRAPH THE WORK AREA PRIOR TO CONSTRUCTION FOR THE PURPOSE OF DOCUMENTING EXISTING CONDITIONS.																															
5	4. EXCEPT WHERE MODIFIED BY THE CONTRACT DOCUMENTS, ALL PROPOSED WORK SHALL BE IN ACCORDANCE WITH THE FOLLOWING SPECIFICATIONS WHICH ARE HEREBY MADE A PART HEREOF: A. "ROADWAY STANDARD SPECIFICATIONS, WISCONSIN DEPARTMENT OF TRANSPORTATION," AS PREPARED BY WISDOT, CURRENT EDITION AND ITS SUPPLEMENTS. B. "10 STATE RECOMMENDED STANDARDS FOR WASTEWATER FACILITIES," AS PUBLISHED BY HEALTH RESEARCH INC., LATEST EDITION. C. REGULATIONS, STANDARDS AND GENERAL REQUIREMENTS SET FORTH BY THE TOWN OF EAGLE, UNLESS OTHERWISE NOTED ON THE PLANS. D. THE NATIONAL ELECTRIC CODE. E. ALL APPLICABLE PROVISIONS OF THE OCCUPATIONAL SAFETY AND HEALTH ACT ARE HEREIN INCORPORATED BY REFERENCE.																															
6	5. STANDARD SPECIFICATIONS, SUPPLEMENTAL SPECIFICATIONS, AND RECURRING SPECIAL PROVISIONS, CONSTRUCTION PLANS, AND SUBSEQUENT DETAILS ARE ALL TO BE CONSIDERED AS PART OF THE CONTRACT. INCIDENTAL ITEMS OR ACCESSORIES NECESSARY TO THE CONTRACTOR'S WORK MAY NOT BE SPECIFICALLY NOTED, BUT ARE CONSIDERED A PART OF THE CONTRACTOR'S CONTRACT.																															
7	6. IT SHALL BE THE RESPONSIBILITY OF THE CONTRACTOR TO ENSURE THAT ALL ITEMS REQUIRED FOR CONSTRUCTION OF THE PROJECT, AS SHOWN ON THE PLANS, ARE INCLUDED IN THE CONTRACT. ANY ITEM NOT SPECIFICALLY INCLUDED ON THE PLANS, SHALL BE THE RESPONSIBILITY OF THE CONTRACTOR. ANY DISCREPANCY IN THE EVENT OF A DISCREPANCY WITH THE PLANS AND QUANTITIES.																															
8	7. THE CONTRACTOR IS RESPONSIBLE FOR HAVING A SET OF "APPROVED" ENGINEERING PLANS WITH THE LATEST REVISION DATE ON THE JOB SITE PRIOR TO THE START OF CONSTRUCTION. IF THERE ARE ANY DISCREPANCIES WITH WHAT IS SHOWN ON THE CONSTRUCTION PLANS, THE CONTRACTOR SHALL IMMEDIATELY REPORT THEM TO THE SURVEYOR OR ENGINEER BEFORE DOING ANY WORK. OTHERWISE, THE CONTRACTOR ASSUMES FULL RESPONSIBILITY FOR THE CONSTRUCTION PLANS. THE CONTRACTOR SHALL, IN ALL PLANS, SPECIFICATIONS, AND/OR SPECIAL DETAILS, THE CONTRACTOR SHALL SECURE WRITTEN INSTRUCTION FROM THE ENGINEER PRIOR TO PROCEEDING WITH ANY PART OF THE WORK AFFECTED BY OMISSIONS OR DISCREPANCIES. FAILING TO SECURE WRITTEN INSTRUCTION SHALL BE CONSIDERED TO HAVE PROCEEDED AT THE CONTRACTOR'S OWN RISK AND EXPENSE. IN THE EVENT OF ANY DOUBT OR QUESTIONS ARISING WITH RESPECT TO THE TRUE MEANING OF THE CONSTRUCTION PLANS OR SPECIFICATIONS, THE DECISION OF THE ENGINEER SHALL BE FINAL AND CONCLUSIVE.																															
9	8. THE CONTRACTOR SHALL SUBSCRIBE TO ALL GOVERNING REGULATIONS AND SHALL OBTAIN ALL NECESSARY PUBLIC AGENCY PERMITS PRIOR TO STARTING WORK. THE CONTRACTOR, BY USING THESE PLANS FOR THEIR WORK, AGREE TO HOLD HARMLESS KIMLEY-HORN AND ASSOCIATES, INC., THE TOWN OF EAGLE, THEIR EMPLOYEES AND ADVISORS, AND THE OWNER, FROM AND AGAINST ANY AND ALL LIABILITY, CLAIMS, DAMAGES, AND THE COST OF DEFENSE ARISING OUT OF CONTRACTOR(S) PERFORMANCE OF THE WORK DESCRIBED HEREIN.																															
10	9. THE ENGINEER AND OWNER ARE NOT RESPONSIBLE FOR THE CONSTRUCTION MEANS, METHODS, TECHNIQUES, SEQUENCES OR PROCEDURES, TIME OF PERFORMANCE, PROGRAMS OR FOR ANY SAFETY PRECAUTIONS USED BY THE CONTRACTOR. THE CONTRACTOR IS SOLELY RESPONSIBLE FOR EXECUTION OF THE WORK IN ACCORDANCE WITH THE CONTRACT DOCUMENTS AND SPECIFICATIONS.																															
11	10. CONSTRUCTION MATERIALS AND/OR EQUIPMENT MAY NOT BE STORED IN THE RIGHT-OF-WAY, AS DIRECTED BY THE OWNER.																															
12	11. EASEMENTS FOR THE EXISTING UTILITIES, BOTH PUBLIC AND PRIVATE, AND UTILITIES WITHIN PUBLIC RIGHT-OF-WAYS ARE SHOWN ON THE PLANS ACCORDING TO AVAILABLE RECORDS. THE CONTRACTOR SHALL BE RESPONSIBLE FOR DETERMINING THE EXACT LOCATION OF THESE UTILITY LINES AND THEIR PROTECTION FROM DAMAGE DUE TO CONSTRUCTION OPERATIONS. IF EXISTING UTILITY LINES OF ANY NATURE ARE ENCOUNTERED WHICH CONFLICT WITH LOCATIONS OF THE NEW CONSTRUCTION, THE CONTRACTOR SHALL NOTIFY THE ENGINEER SO THAT THE CONFLICT MAY BE RESOLVED.																															
13	12. OWNER SHALL OBTAIN EASEMENTS AND APPROVAL OF PERMITS NECESSARY TO FACILITATE CONSTRUCTION OF THE PROPOSED UTILITIES. THE CONTRACTOR, HOWEVER, SHALL FURNISH ALL REQUIRED BONDS AND EVIDENCE OF INSURANCE NECESSARY TO SECURE THESE PERMITS AND EASEMENTS. THE CONTRACTOR SHALL PRESERVE ALL CONSTRUCTION STAKES UNTIL THEY ARE NO LONGER NEEDED. ANY STAKES DESTROYED OR DISTURBED BY THE CONTRACTOR PRIOR TO THEIR USE SHALL BE RESET BY THE SURVEYOR AT THE CONTRACTOR'S EXPENSE.																															
14	14.A. THE CONTRACTOR SHALL NOTIFY AFFECTED GOVERNMENTAL AGENCIES IN WRITING AT LEAST THREE FULL WORKING DAYS PRIOR TO COMMENCEMENT OF CONSTRUCTION. IN ADDITION, THE CONTRACTOR SHALL NOTIFY, AS NECESSARY, ALL TESTING AGENCIES, THE TOWN OF EAGLE, AND THE OWNER SUFFICIENTLY IN ADVANCE OF CONSTRUCTION.																															
15	14.B. FAILURE OF THE CONTRACTOR TO ALLOW PROPER NOTIFICATION TIME WHICH RESULTS IN THE TESTING COMPANIES TO BE UNABLE TO VISIT THE SITE AND PERFORM TESTING WILL CAUSE THE CONTRACTOR TO SUSPEND THE OPERATION TO BE TESTED UNTIL THE TESTING AGENCY CAN SCHEDULE TESTING OPERATIONS. COST OF SUSPENSION OF WORK SHALL BE BORNE BY THE CONTRACTOR.																															
16	15. ALL CONTRACTORS SHALL KEEP ACCESS AVAILABLE AT ALL TIMES FOR ALL EMERGENCY TRAFFIC, AS DIRECTED BY THE TOWN OF EAGLE.																															
17	16. ANY EXISTING SIGNS, LIGHT STANDARDS, AND UTILITY POLES THAT INTERFERE WITH CONSTRUCTION OPERATIONS AND ARE NOT NOTED ON THE PLANS FOR DISPOSAL SHALL BE REMOVED AND RESET BY THE CONTRACTOR AT THE CONTRACTOR'S OWN EXPENSE, AS DIRECTED BY THE ENGINEER. ANY DAMAGE TO THESE ITEMS SHALL BE REPAIRED OR REPLACED BY THE CONTRACTOR AT THE CONTRACTOR'S OWN EXPENSE TO THE SATISFACTION OF THE OWNER. ANY SIGNS NOT REQUIRED TO BE RESET SHALL BE DELIVERED TO THE RESPECTIVE OWNERS.																															
18	17. ALL TREES TO BE SAVED SHALL BE IDENTIFIED PRIOR TO CONSTRUCTION BY THE LANDSCAPE ARCHITECT AND SHALL BE PROTECTED PER WSDOT SECTION 202. THE RIGHT-OF-WAY LINE AND LIMITS OF THE CONTRACTOR'S OPERATIONS SHALL BE CLEARLY DEFINED THROUGHOUT THE CONSTRUCTION PERIOD. ALL TREES NOTED TO REMAIN SHALL BE PROTECTED FROM DAMAGE TO TRUNKS, BRANCHES AND ROOTS. NO EXCAVATING, FILLING OR GRADING IS TO BE DONE INSIDE THE DRIP LINE OF TREES UNLESS OTHERWISE INDICATED.																															
19	18. LIMB PRUNING SHALL BE PERFORMED UNDER THE SUPERVISION OF AN APPROVED LANDSCAPE ARCHITECT, FORESTER, OR ARBORIST AND SHALL BE UNDERTAKEN IN A MANNER THAT DOES NOT INTERFERE WITH CONSTRUCTION. ALL LIMBS, BRANCHES, AND OTHER DEBRIS RESULTING FROM THE CONTRACTOR'S WORK SHALL BE DISPOSED OF OFF-SITE BY THE CONTRACTOR AT THE CONTRACTOR'S OWN EXPENSE. ALL CUTS OVER ONE (1) INCH IN DIAMETER SHALL BE PAINTED WITH AN APPROVED TREE PAINT.																															
20	19. ALL EXISTING PAVEMENT OR CONCRETE TO BE REMOVED SHALL BE SAWCUT ALONG LIMITS OF PROPOSED REMOVAL BEFORE COMMENCEMENT OF PAVEMENT REMOVAL.																															
21	20. ALL EXISTING UTILITIES OR IMPROVEMENTS, INCLUDING WALKS, CURBS, PAVEMENT, AND PARKWAYS DAMAGED OR REMOVED DURING CONSTRUCTION SHALL BE PROMPTLY RESTORED TO THEIR RESPECTIVE ORIGINAL CONDITION. THE CONTRACTOR'S WORK SHALL BE CONSIDERED INCIDENTAL TO THE CONTRACT UNLESS A PAY ITEM IS LISTED ON THE BID LIST.																															
22	21. REMOVAL OF SPECIFIED ITEMS, INCLUDING BUT NOT LIMITED TO, PAVEMENT, SIDEWALK, CURB, CURB AND GUTTER, CULVERTS, ETC., SHALL BE DISPOSED OF OFF-SITE BY THE CONTRACTOR AT THE CONTRACTOR'S OWN EXPENSE. THE CONTRACTOR IS RESPONSIBLE FOR ANY PERMITS REQUIRED FOR SUCH DISPOSAL.																															
23	22. THE CONTRACTOR SHALL COLLECT AND REMOVE ALL CONSTRUCTION DEBRIS, EXCESS MATERIALS, TRASH, OIL AND GREASE RESIDUE, MACHINERY, TOOLS, AND OTHER MISCELLANEOUS ITEMS WHICH WERE NOT PRESENT PRIOR TO PROJECT COMMENCEMENT AT NO ADDITIONAL EXPENSE TO THE OWNER. THE CONTRACTOR SHALL BE RESPONSIBLE FOR ACQUIRING ANY AND ALL PERMITS NECESSARY FOR THE HAULING AND DISPOSAL REQUIRED FOR CLEANUP, AS DIRECTED BY THE ENGINEER OR OWNER. BURNING ON THE SITE IS NOT PERMITTED.																															
24	23. NO UNDERGROUND WORK WITHIN THE PUBLIC RIGHT-OF-WAY SHALL BE COVERED UNTIL IT HAS BEEN APPROVED BY THE TOWN OF EAGLE. APPROVAL TO PROCEED MUST BE OBTAINED FROM THE TOWN OF EAGLE PRIOR TO INSTALLING PAVEMENT BASE, BINDER, AND SURFACE, AND PRIOR TO POURING ANY CONCRETE AFTER FORMS HAVE BEEN SET, AS NECESSARY.																															
25	24. WHERE SHOWN ON THE PLANS OR DIRECTED BY THE ENGINEER, EXISTING DRAINAGE STRUCTURES AND PIPE SHALL BE CLEANED OF DEBRIS AND PATCHED AS NECESSARY TO ASSURE INTEGRITY OF THE STRUCTURE. THE CONTRACTOR'S WORK SHALL NOT BE PAID FOR SEPARATELY, BUT SHALL BE MERGED INTO THE CONTRACT UNIT PRICE EACH FOR STRUCTURES AND CONTRACT UNIT PRICE PER LINEAL FOOT FOR STORM SEWERS, WHICH SHALL BE PAYMENT IN FULL FOR CLEANING, PATCHING, REMOVAL, AND DISPOSAL OF DEBRIS AND DIRT. DRAINAGE STRUCTURES AND STORM SEWERS CONSTRUCTED AS PART OF THE CONTRACTOR'S PROJECT SHALL BE MAINTAINED BY THE CONTRACTOR AT THE CONTRACTOR'S EXPENSE. NO EXTRA PAYMENT WILL BE MADE FOR CLEANING STRUCTURES OR STORM SEWERS CONSTRUCTED AS PART OF THE CONTRACTOR'S PROJECT.																															
26	25. THE CONTRACTOR SHALL BE RESPONSIBLE FOR HAVING THE UTILITY COMPANIES LOCATE THEIR FACILITIES IN THE FIELD PRIOR TO CONSTRUCTION AND SHALL ALSO BE RESPONSIBLE FOR THE MAINTENANCE AND PRESERVATION OF THESE FACILITIES. THE ENGINEER DOES NOT WARRANT THE LOCATION OF ANY EXISTING UTILITIES SHOWN ON THE PLANS. THE CONTRACTOR SHALL CALL DIGGERS HOTLINE LOCATING SERVICES (1-800-242-8511) AND THE TOWN OF EAGLE FOR UTILITY LOCATIONS.																															
27	26. THE GENERAL CONTRACTOR SHALL COORDINATE WITH UTILITY COMPANIES TO PROVIDE CABLE TV, PHONE, ELECTRIC, GAS AND IRRIGATION SERVICES. GENERAL CONTRACTOR SHALL BE RESPONSIBLE FOR SECURING SITE LAYOUTS FOR THESE UTILITIES AND SHALL COORDINATE AND PROVIDE CONDUIT CROSSLINGS AS REQUIRED. THIS COORDINATION SHALL BE CONSIDERED INCIDENTAL TO GENERAL CONTRACTOR AGREEMENT WITH THE OWNER. ANY CONFLICTS IN UTILITIES SHALL BE CORRECTED BY THE GENERAL CONTRACTOR AT NO ADDITIONAL COST TO THE OWNER.																															
28	27. CONTRACTOR IS TO VERIFY ALL EXISTING STRUCTURES AND FACILITIES AT ALL PROPOSED UTILITY CONNECTION LOCATIONS AND NOTIFY ENGINEER OF ANY DISCREPANCIES PRIOR TO ORDERING MATERIAL AND STARTING WORK.																															
29	28. ANY FIELD TIES ENCOUNTERED SHALL BE INSPECTED BY THE ENGINEER. THE DRAIN TIE SHALL BE CONNECTED TO THE STORM SEWER SYSTEM AND A RECORD KEPT BY THE CONTRACTOR OF THE LOCATIONS AND TURNED OVER TO THE ENGINEER UPON COMPLETION OF THE PROJECT. THE COST OF THE CONTRACTOR'S WORK SHALL BE CONSIDERED INCIDENTAL TO THE CONTRACT, AND NO ADDITIONAL COMPENSATION SHALL BE ALLOWED.																															
30	29. ALL FRAMES AND LIDS FOR STORM AND SANITARY SEWERS, VALVE VAULT COVERS, FIRE HYDRANTS, AND B-BOWES ARE TO BE ADJUSTED TO MEET FINISHED GRADE. THE CONTRACTOR'S ADJUSTMENT IS TO BE MADE BY THE SEWER AND WATER CONTRACTOR, AND THE COST IS TO BE CONSIDERED INCIDENTAL. THESE ADJUSTMENTS TO FINISHED GRADE WILL NOT ALLEVATE THE CONTRACTOR FROM ANY ADDITIONAL ADJUSTMENTS AS REQUIRED BY THE TOWN OF EAGLE UPON FINAL INSPECTION OF THE PROJECT.																															
31	30. HYDRANTS SHALL NOT BE FLUSHED DIRECTLY ONTO THE ROAD SURFACES. WHENEVER POSSIBLE, HOSES SHALL BE USED TO DIRECT THE WATER INTO LOT AREAS OR THE STORM SEWER SYSTEM, IF AVAILABLE. DAMAGE TO THE ROAD AND SUBGRADE DUE TO EXCESSIVE WATER SATURATION OR EROSION FROM HYDRANT FLUSHING, OR FROM LEAKS IN THE WATER DISTRIBUTION SYSTEM, WILL BE REPAIRED BY THE CONTRACTOR FLUSHING OR USING THE HYDRANT AT THE CONTRACTOR'S OWN EXPENSE. LEAKS IN THE WATER DISTRIBUTION SYSTEM SHALL BE REPAIRED BY THE CONTRACTOR. MAIN CONTRACTOR AND SHALL BE REPAIRED AT THE CONTRACTOR'S EXPENSE.																															
32	31. TRENCH BACKFILL WILL BE REQUIRED TO THE FULL DEPTH ABOVE SEWERS AND WATERMAIN WITHIN TWO (2) FEET HORIZONTAL OF PROPOSED OR EXISTING PAVEMENT.																															
33	32. IF SOFT, SPONGY, OR OTHER UNSUITABLE SOILS WITH UNCONFINED COMPRESSIVE STRENGTH LESS THAN 0.5 TSF ARE ENCOUNTERED AT THE BOTTOM OF THE TRENCH, ALL SUCH MATERIAL SHALL BE REMOVED AND REPLACED WITH THE SAFE MATERIAL OF THE TRENCH. IF THE TRENCH IS DEEPER THAN 4 FEET, SUCH DEVICES AND THEIR INSTALLATION SHALL CONFORM TO THE MANUAL OF UNIFORM TRAFFIC CONTROL DEVICES (MUTCD), LATEST EDITION, AND IN ACCORDANCE WITH THE TOWN OF EAGLE CODE.																															
34	2. SUBGRADE PREPARATION																															
35	2.1. EARTHWORK FOR PROPOSED PAVEMENT SUBGRADE SHALL BE FINISHED TO WITHIN 0.1 FOOT, PLUS OR MINUS, OF PLAN ELEVATION. THE CONTRACTOR SHALL CONFIRM THAT THE SUBGRADE HAS BEEN PROPERLY PREPARED AND THAT THE FINISHED TOP SUBGRADE ELEVATION MEETS THE TOLERANCES ALLOWED IN THESE SPECIFICATIONS, UNLESS THE CONTRACTOR ADVISES THE ENGINEER IN WRITING PRIOR TO FINE GRADING FOR BASE COURSE CONSTRUCTION. IT IS UNDERSTOOD THAT THE CONTRACTOR HAS APPROVED AND ACCEPTS THE RESPONSIBILITY FOR THE SUBGRADE.																															
36	2.2. PRIOR TO THE PLACEMENT OF THE BASE COURSE, THE SUBGRADE MUST BE PROOF-ROLLED AND INSPECTED FOR UNSUITABLE MATERIALS AND/OR EXCESSIVE MOVEMENT. IF UNSUITABLE SUBGRADE IS ENCOUNTERED, IT SHALL BE CORRECTED. THIS MAY INCLUDE ONE OR MORE OF THE FOLLOWING: STORM SEWER SYSTEM FROM ADJACENT AND/OR UPSTREAM DRAINAGE AREAS.																															
37	2.2.1. SCARIFY, DISC, AND AERATE.																															
38	2.2.2. REMOVE AND REPLACE WITH STRUCTURAL CLAY FILL.																															
39	2.2.3. REMOVE AND REPLACE WITH GRANULAR MATERIAL.																															
40	2.2.4. USE OF GEOTEXTILE FABRIC.																															
41	MAXIMUM DEFLECTION ALLOWED IN ISOLATED AREAS MAY BE ONE-QUARTER (1/4) INCH TO ONE-HALF (1/2) INCH IF NO DEFLECTION OCCURS OVER THE MAJORITY OF THE AREA.																															
42	2.3. PRIOR TO THE CONSTRUCTION OF THE CURB AND GUTTER AND THE PLACEMENT OF THE BASE MATERIAL, THE PAVEMENT AREA SHALL BE FINE-GRADED TO WITHIN 0.04 FEET (1/2 INCH) OF FINAL SUBGRADE ELEVATION, TO A POINT TWO (2) FEET BEYOND THE BACK OF THE CURB, SO AS TO ENSURE THE PROPER THICKNESS OF PAVEMENT COURSES. NO CLAIMS FOR EXCESS QUANTITY OF BASE MATERIALS DUE TO IMPROPER SUBGRADE PREPARATION WILL BE HONORED.																															
43	2.4. PRIOR TO PLACEMENT OF THE BASE COURSE, THE SUBGRADE SHALL BE APPROVED BY THE TESTING ENGINEER.																															
44	3. CONCRETE WORK																															
45	3.1. ALL EXTERIOR CONCRETE SHALL BE PORTLAND CEMENT CONCRETE WITH AIR ENTRAINMENT OF NOT LESS THAN FIVE (5%) OR MORE THAN EIGHT (8%) PERCENT. CONCRETE SHALL BE A MINIMUM OF SIX (6) INCHES THICK. THE MINIMUM OF 3,500 PSI COMPRESSIVE STRENGTH AT FOURTEEN (14) DAYS AND A MINIMUM OF 4,000 PSI COMPRESSIVE STRENGTH AT TWENTY-EIGHT (28) DAYS. ALL CONCRETE SHALL BE BROOM-FINISHED PERPENDICULAR TO THE DIRECTION OF TRAVEL.																															
46	3.2. CONCRETE CURB AND/OR COMBINATION CURB AND GUTTER SHALL BE OF THE TYPE SHOWN ON THE PLANS. THE CONTRACTOR IS CAUTIONED TO REFER TO THE CONSTRUCTION STANDARDS AND THE REPAIRS OF THE SATISFACTION OF THE OWNER PRIOR TO LAYING THE SURFACE COURSE. THE CONCRETE CURB AND/OR COMBINATION CURB AND GUTTER SHALL BE REPAIRED WITH THE SAME TYPE AND THICKNESS OF CONCRETE. THE CURB AND/OR COMBINATION CURB AND GUTTER SHALL BE REPAIRED WITH THE SAME TYPE AND THICKNESS OF CONCRETE. THE CURB AND/OR COMBINATION CURB AND GUTTER SHALL BE REPAIRED WITH THE SAME TYPE AND THICKNESS OF CONCRETE. THE CURB AND/OR COMBINATION CURB AND GUTTER SHALL BE REPAIRED WITH THE SAME TYPE AND THICKNESS OF CONCRETE. THE CURB AND/OR COMBINATION CURB AND GUTTER SHALL BE REPAIRED WITH THE SAME TYPE AND THICKNESS OF CONCRETE. THE CURB AND/OR COMBINATION CURB AND GUTTER SHALL BE REPAIRED WITH THE SAME TYPE AND THICKNESS OF CONCRETE. 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<div><div>DOLLAR GENERAL</div><div>NEC HIGHWAY NN & GODFREY LN. TOWN OF EAGLE, WI 53119</div><div>ORIGINAL ISSUE: 07/29/2020</div><div>KHA PROJECT NO. 168708007</div><div>SHEET NUMBER</div><div>C2.0</div></div>	<div>DEMOLITION PLAN</div>	<div>THE OVERLAND GROUP</div>	<div><div>Kimley»Horn</div><div>© 2020 KIMLEY-HORN AND ASSOCIATES, INC. 4201 WINTLEF ROAD, SUITE 600 PHONE: 630-487-5550 WWW.KIMLEY-HORN.COM</div></div>	SCALE:	AS NOTED						
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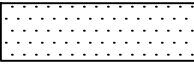

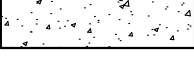


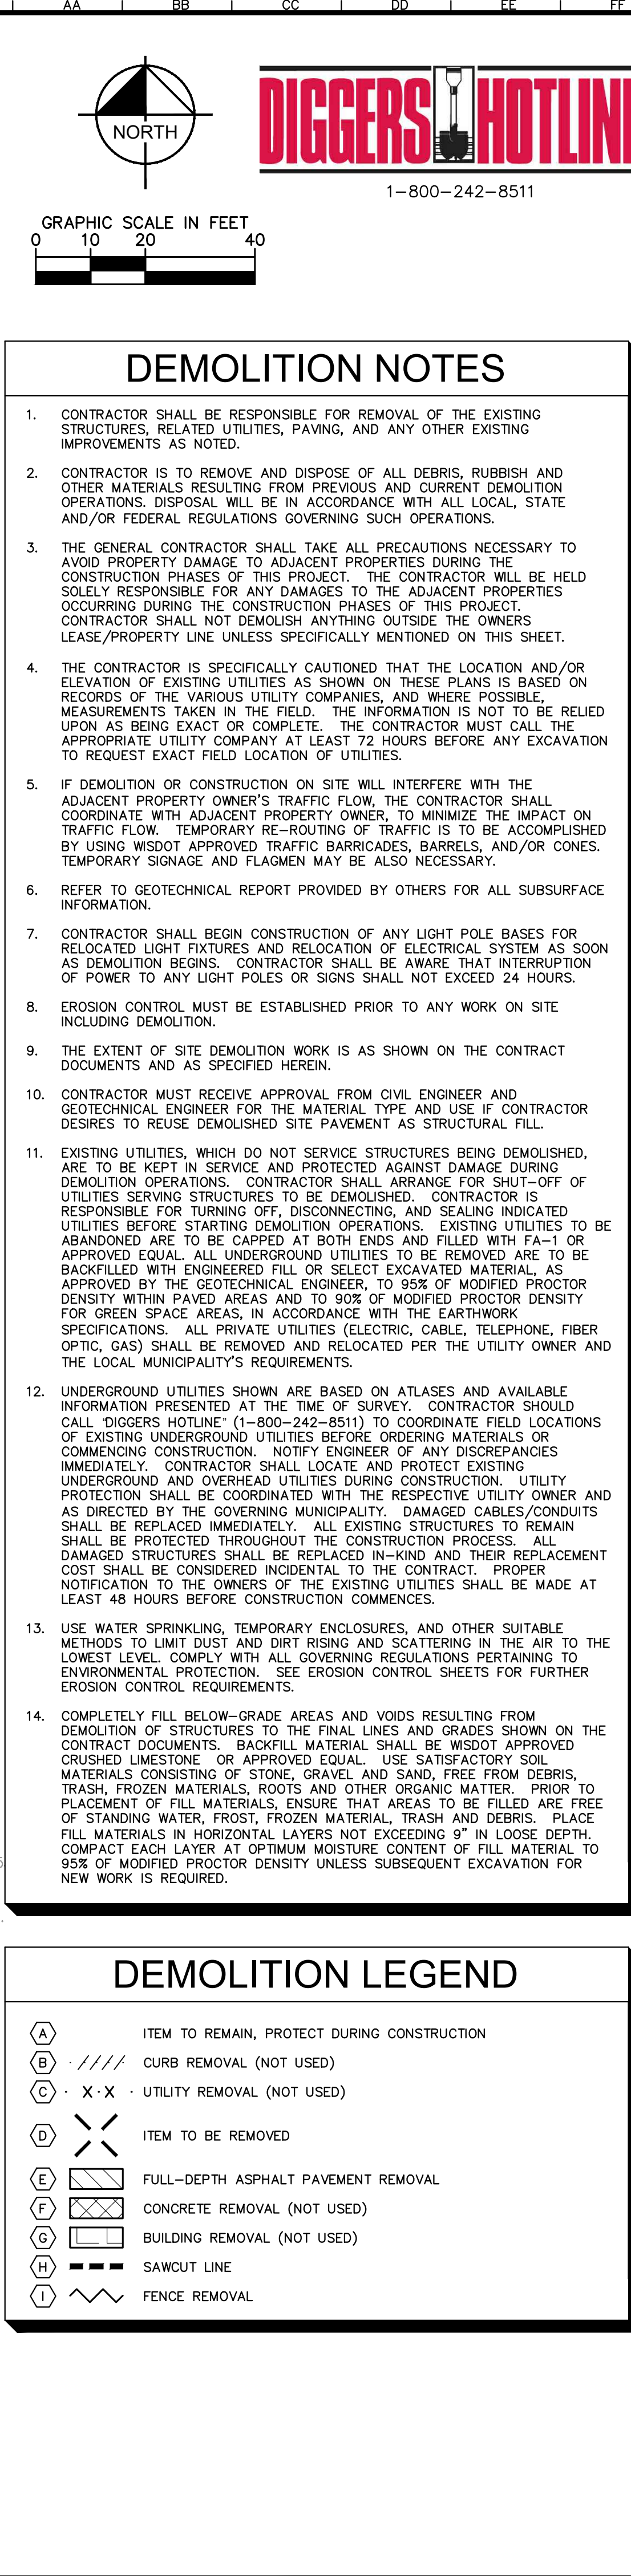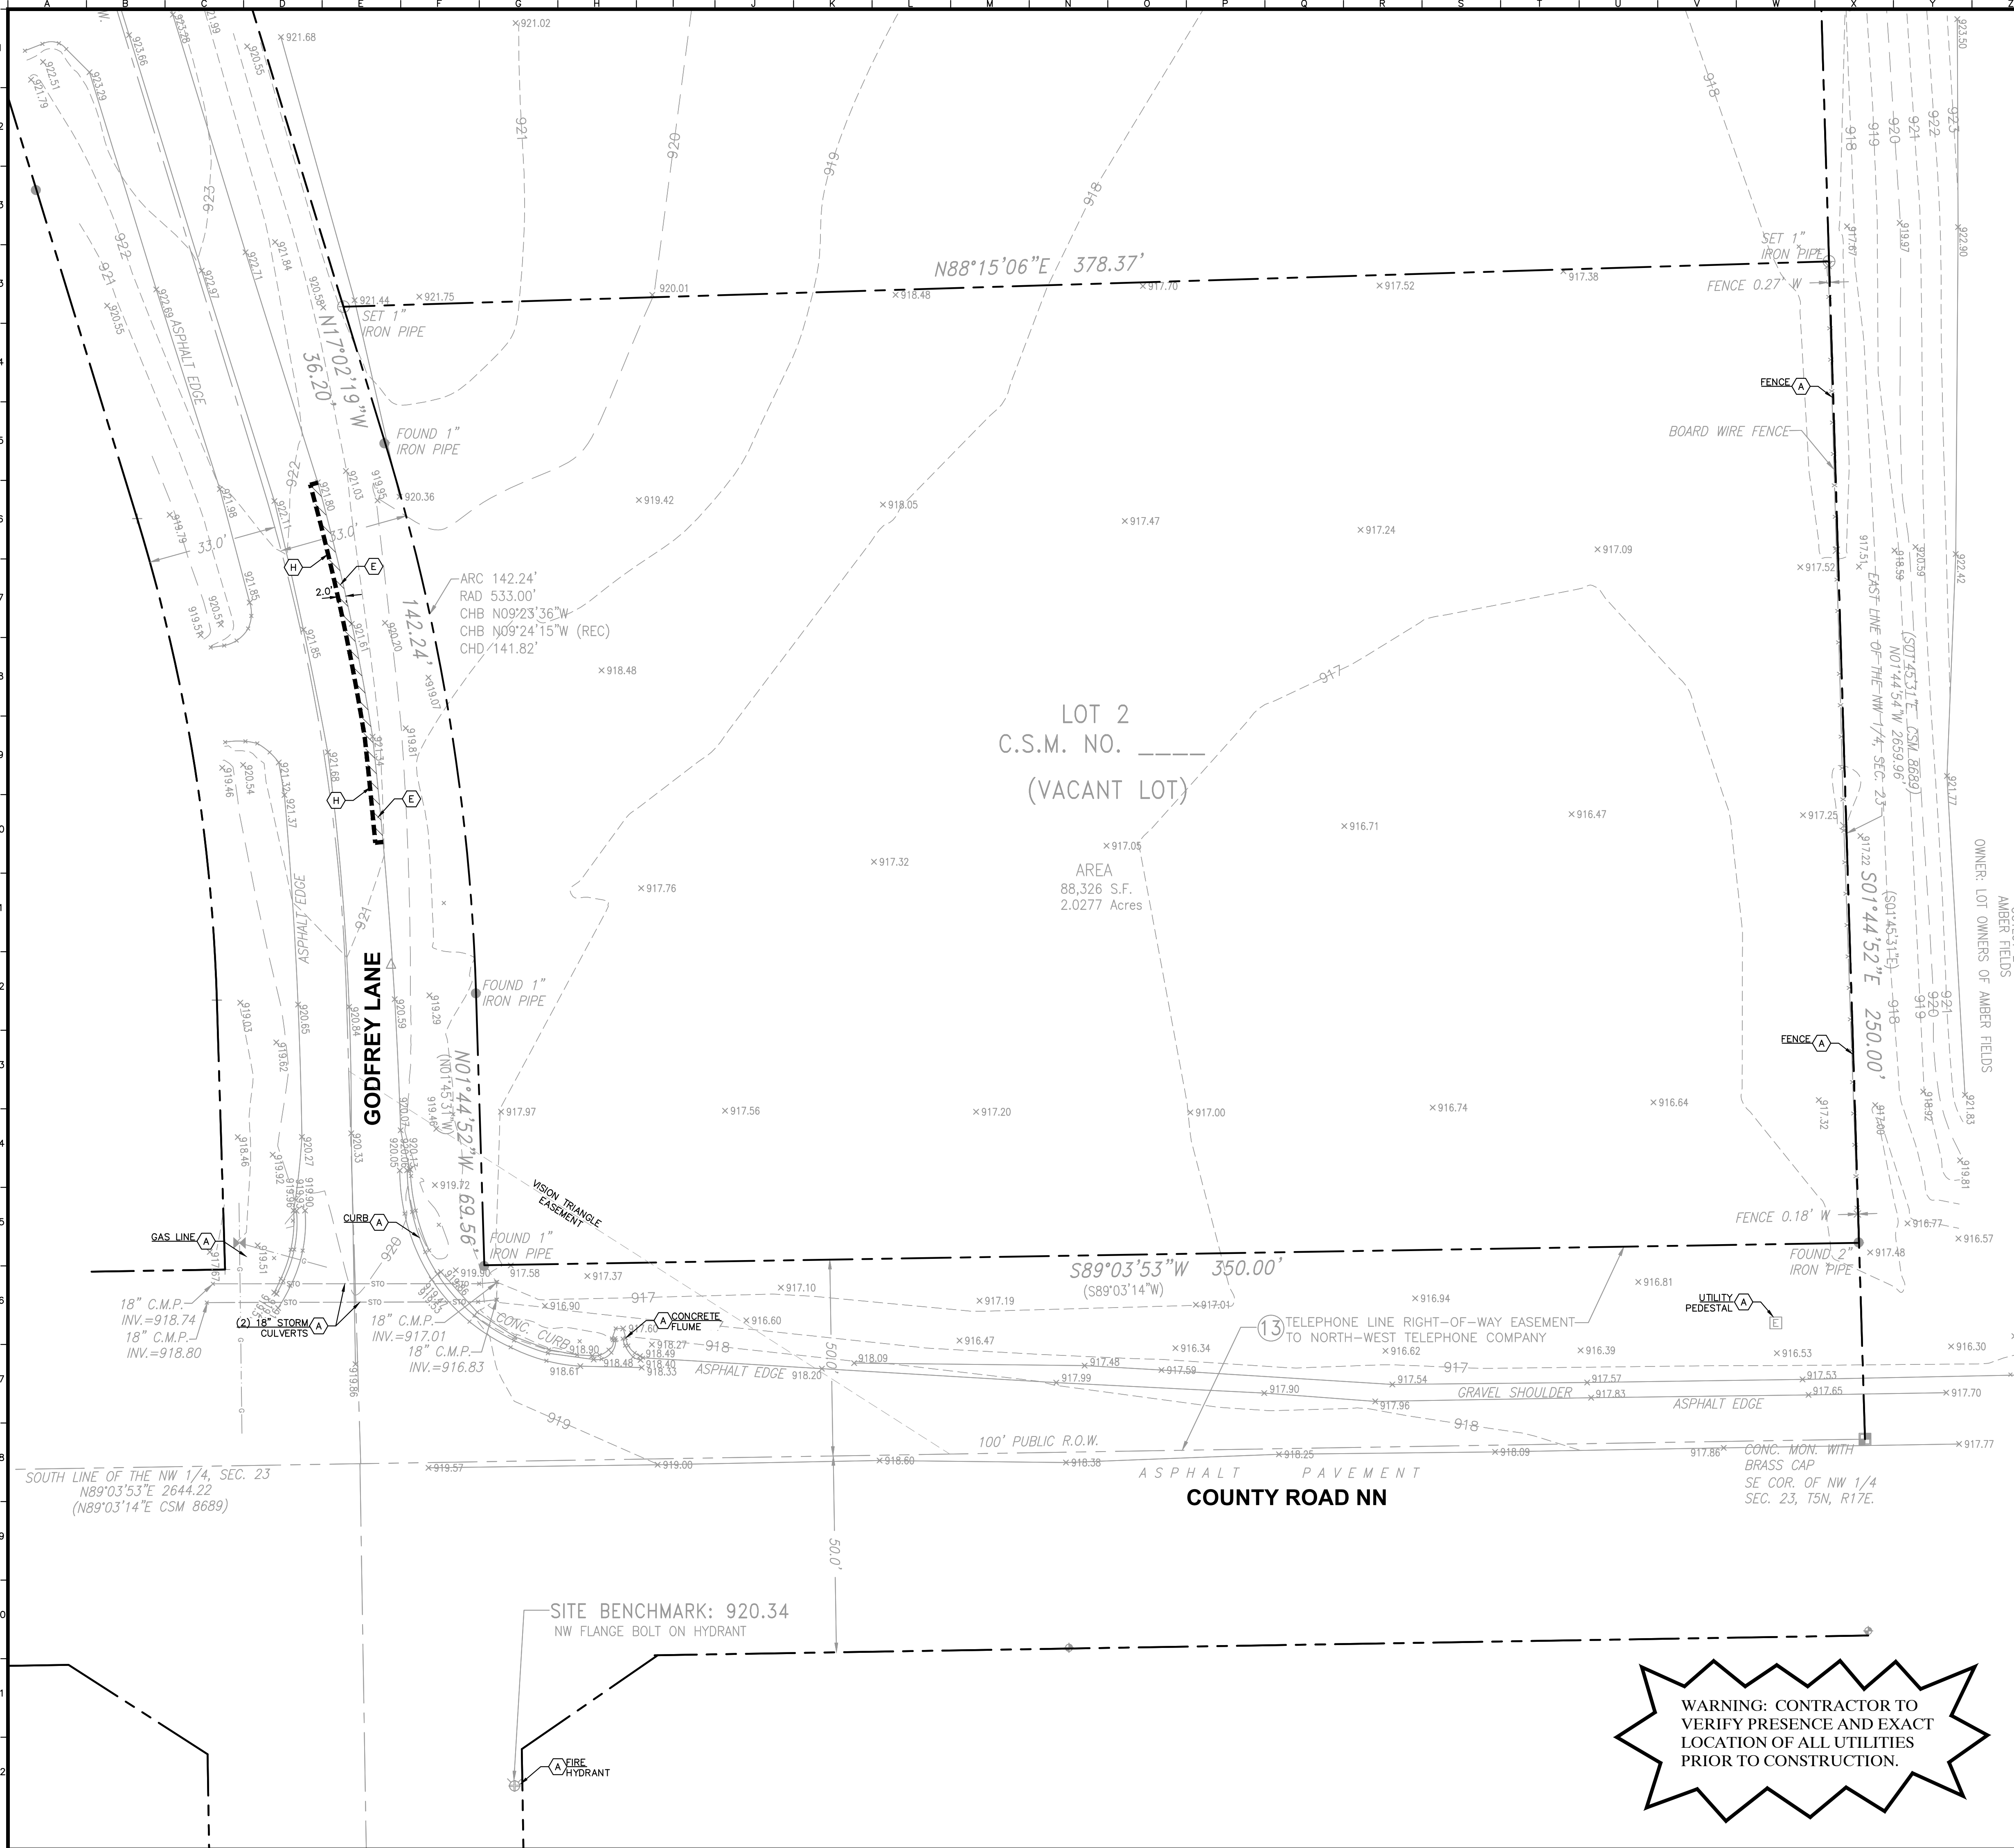

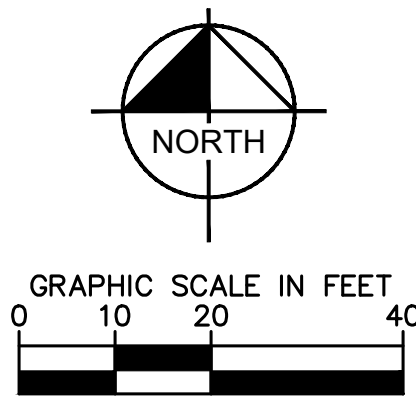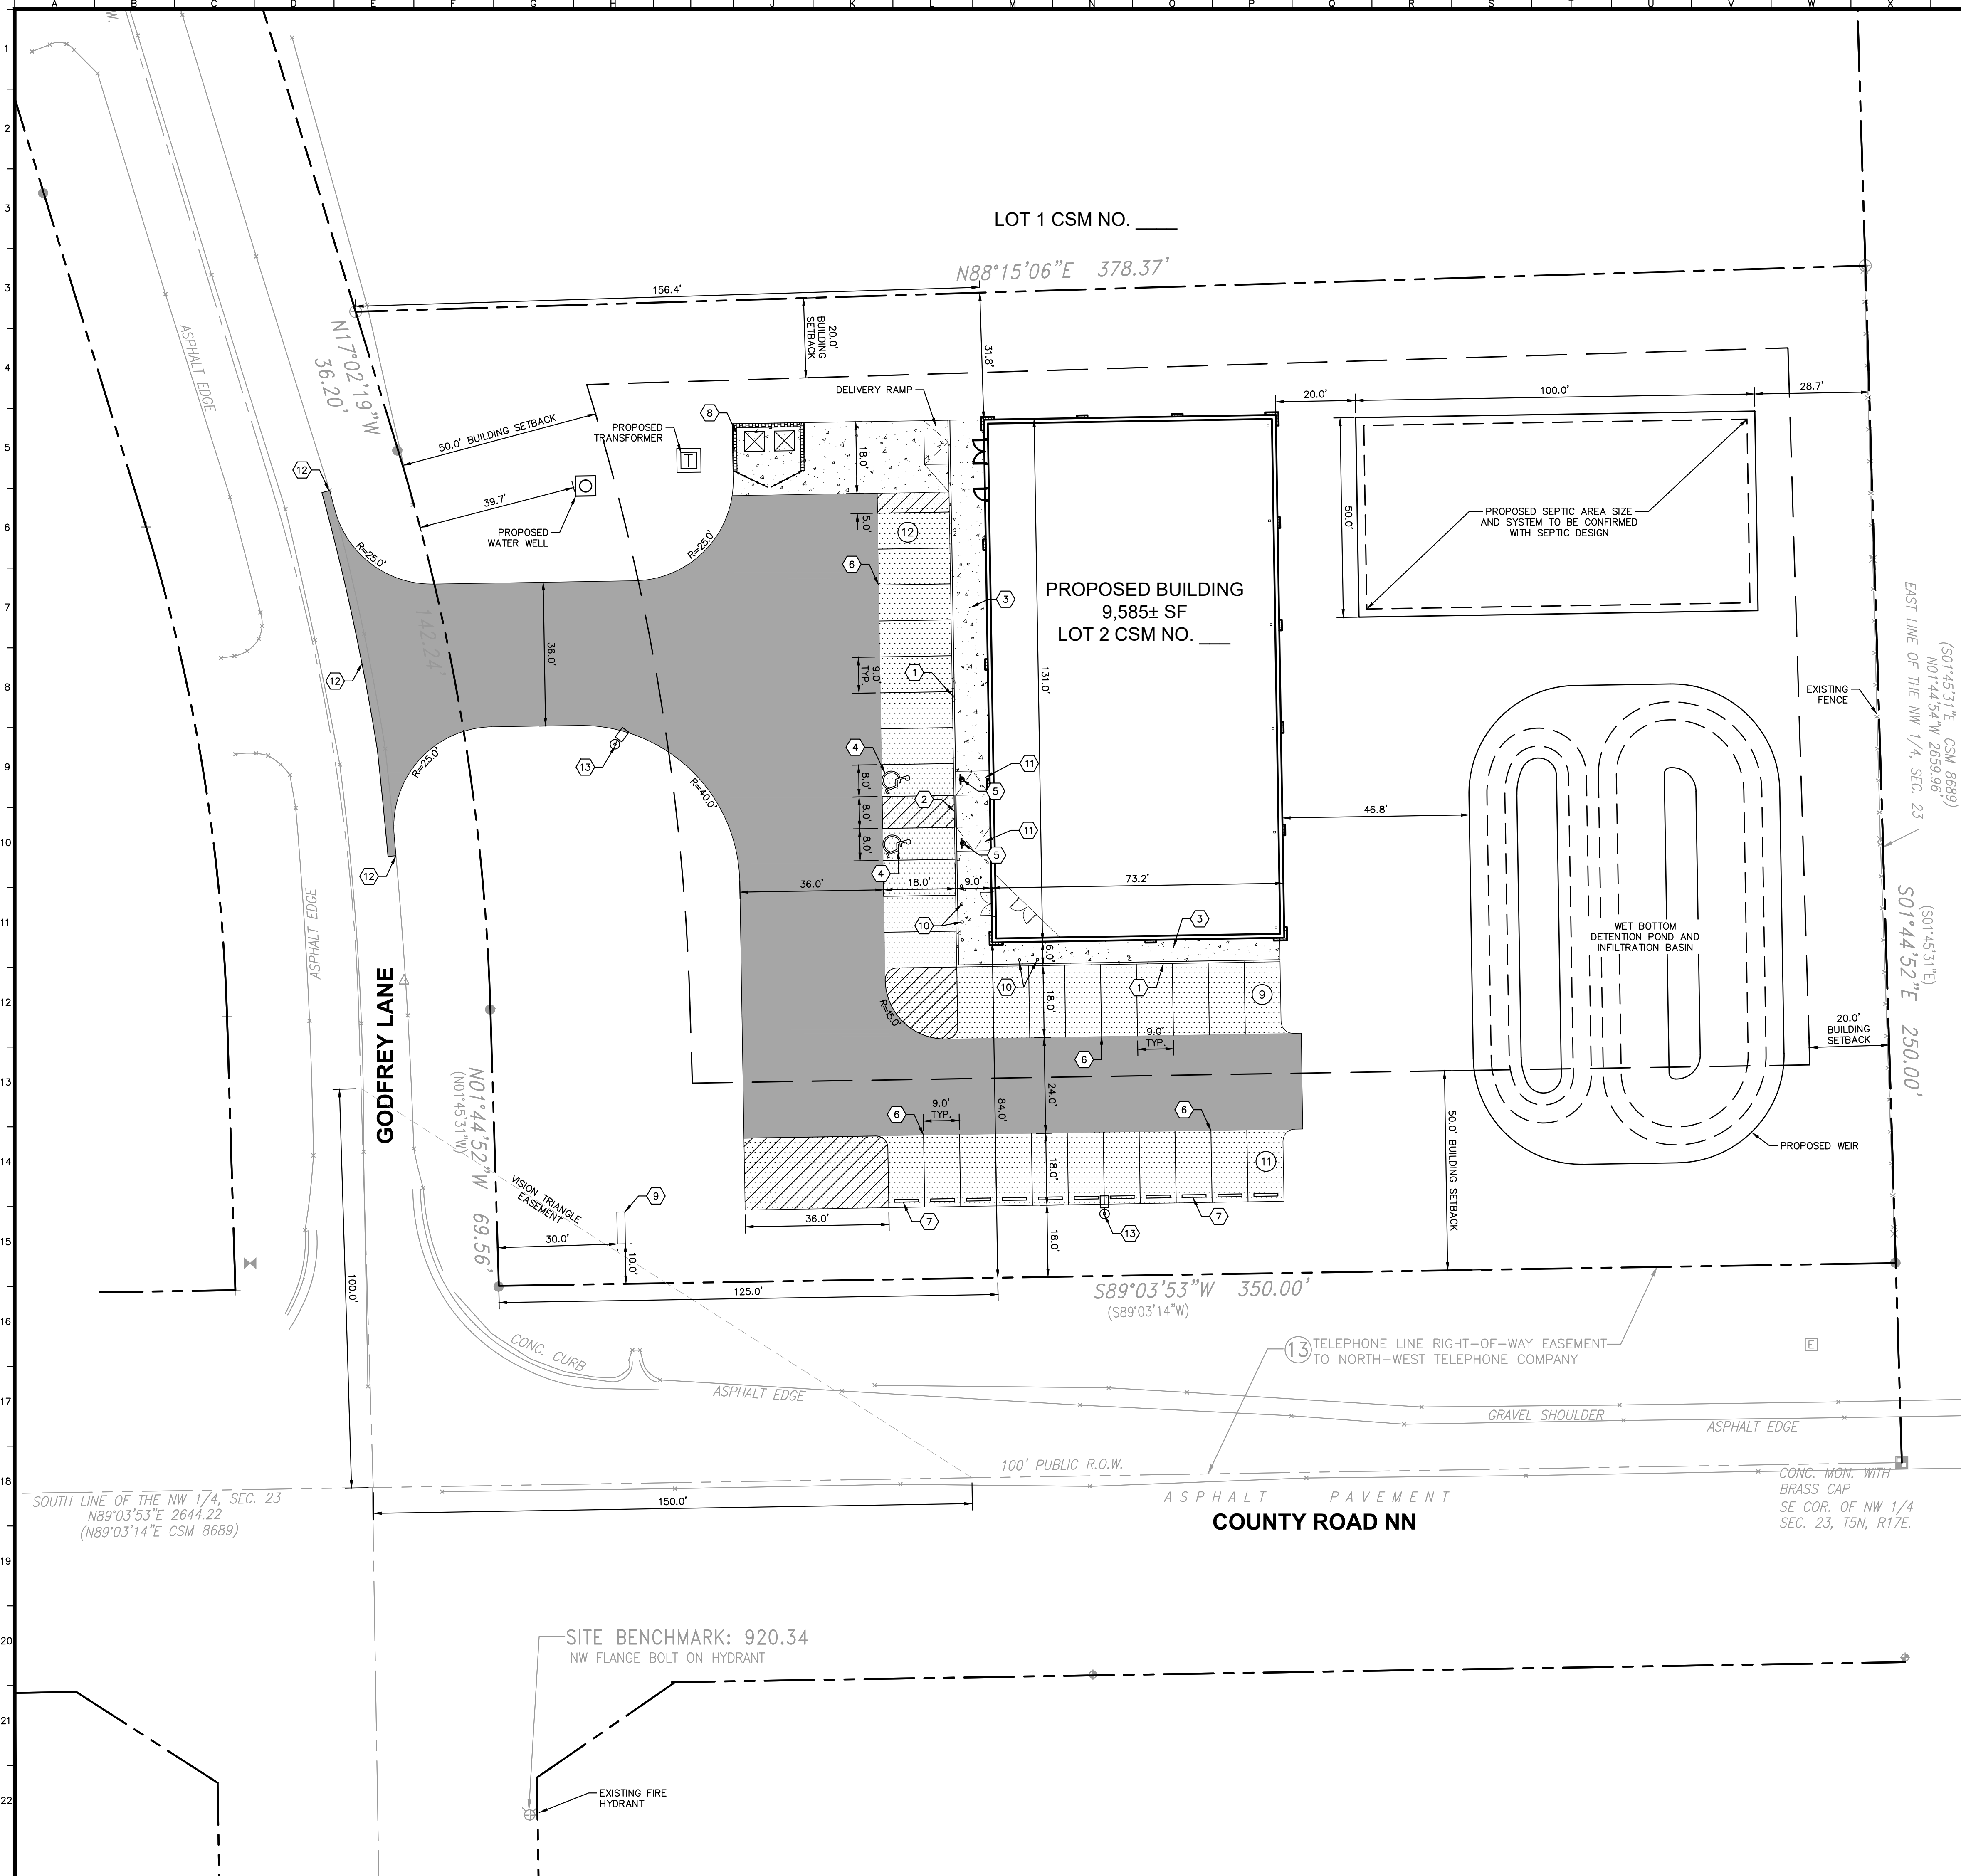


SITE DATE TABLE	
PROPOSED LOT AREA (CSM - LOT 2)	= 2.03 ACRES
TOTAL BUILDING AREA	= 9,585 SF
PARKING SPACES REQUIRED (ONE SPACES PER 300 SF OF BUILDING AREA)	= 32 SPACES
STANDARD PARKING SPACES PROVIDED	= 30 SPACES
ACCESSIBLE PARKING SPACES PROVIDED	= 2 SPACES
TOTAL PARKING SPACES PROVIDED	= 32 SPACES

KEY NOTES


1	INTERCURB CURB AND WALK, TYP. (SEE DETAIL, SHEET C7.0)
2	FLUSH CURB AND WALK (SEE DETAIL, SHEET C7.0)
3	CONCRETE SIDEWALK, TYP. (SEE DETAIL, SHEET C7.0)
4	ACCESSIBLE PAVEMENT MARKINGS, TYP. (SEE DETAIL, SHEET C7.0)
5	ACCESSIBLE PARKING SIGN, TYP. (SEE DETAIL, SHEET C7.0)
6	4" WIDE PAINTED SOLID WHITE LINE, TYP.
7	CONCRETE WHEEL STOPS (SEE DETAIL, SHEET C7.0)
8	MASONRY TRASH ENCLOSURE (SEE ARCH PLANS FOR DETAILS)
9	PROPOSED PYLON SIGN (SEE ARCH PLANS FOR DETAILS)
10	BOLLARD, TYP. (SEE DETAIL, SHEET C7.0)
11	ACCESSIBLE RAMP (SEE DETAIL, SHEET C7.0)
12	CONNECT TO EXISTING PAVEMENT, SIDEWALK, CURB, TYP.
13	LIGHT POLE (SEE LIGHTING PLANS FOR DETAILS, SHOWN FOR REFERENCE ONLY)

PAVING AND CURB LEGEND

	<u>STANDARD DUTY ASPHALT PAVEMENT</u> SEE SHEET C7.0 FOR DETAILS
	<u>HEAVY DUTY ASPHALT PAVEMENT</u> SEE SHEET C7.0 FOR DETAILS
	<u>CONCRETE SIDEWALK / PAVEMENT</u> SEE SHEET C7.0 FOR DETAILS
	INTEGRAL CONCRETE CURB AND WALK
	FLUSH CURB AND WALK
	PROPERTY LINE
	SETBACK LINE
	PARKING COUNT



GENERAL NOTES

1. ALL DIMENSIONS REFER TO THE FACE OF CURB UNLESS OTHERWISE NOTED.
2. BUILDING DIMENSIONS ARE TO THE OUTSIDE FACE OF BUILDING UNLESS OTHERWISE NOTED.
3. REFER TO ARCHITECTURAL AND STRUCTURAL PLANS TO VERIFY ALL BUILDING DIMENSIONS.
4. RADII ADJACENT TO PARKING STALL AND NOT DIMENSIONED ON THIS PLAN SHALL BE 3- FEET, TYPICAL.
5. REFER TO ARCHITECTURAL PLANS FOR MONUMENT SIGN DETAILS. SEE MEP PLANS FOR SITE ELECTRICAL DRAWINGS.
6. ALL PROPOSED ON-SITE STRIPING SHALL BE PAINTED UNLESS OTHERWISE NOTED.

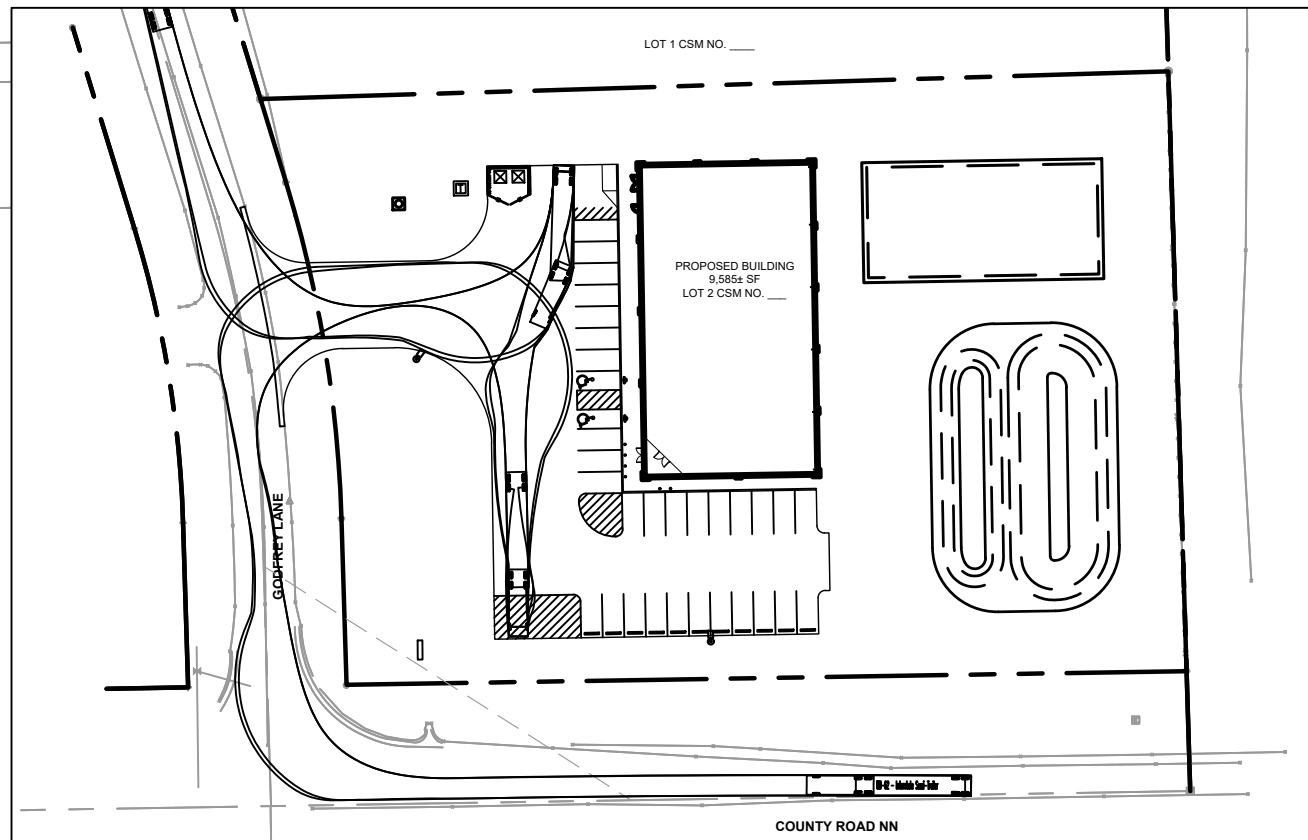


TRUCK ROUTE (WB-62)
SCALE: 1" = 80'

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EROSION CONTROL SCHEDULE AND SEQUENCING:

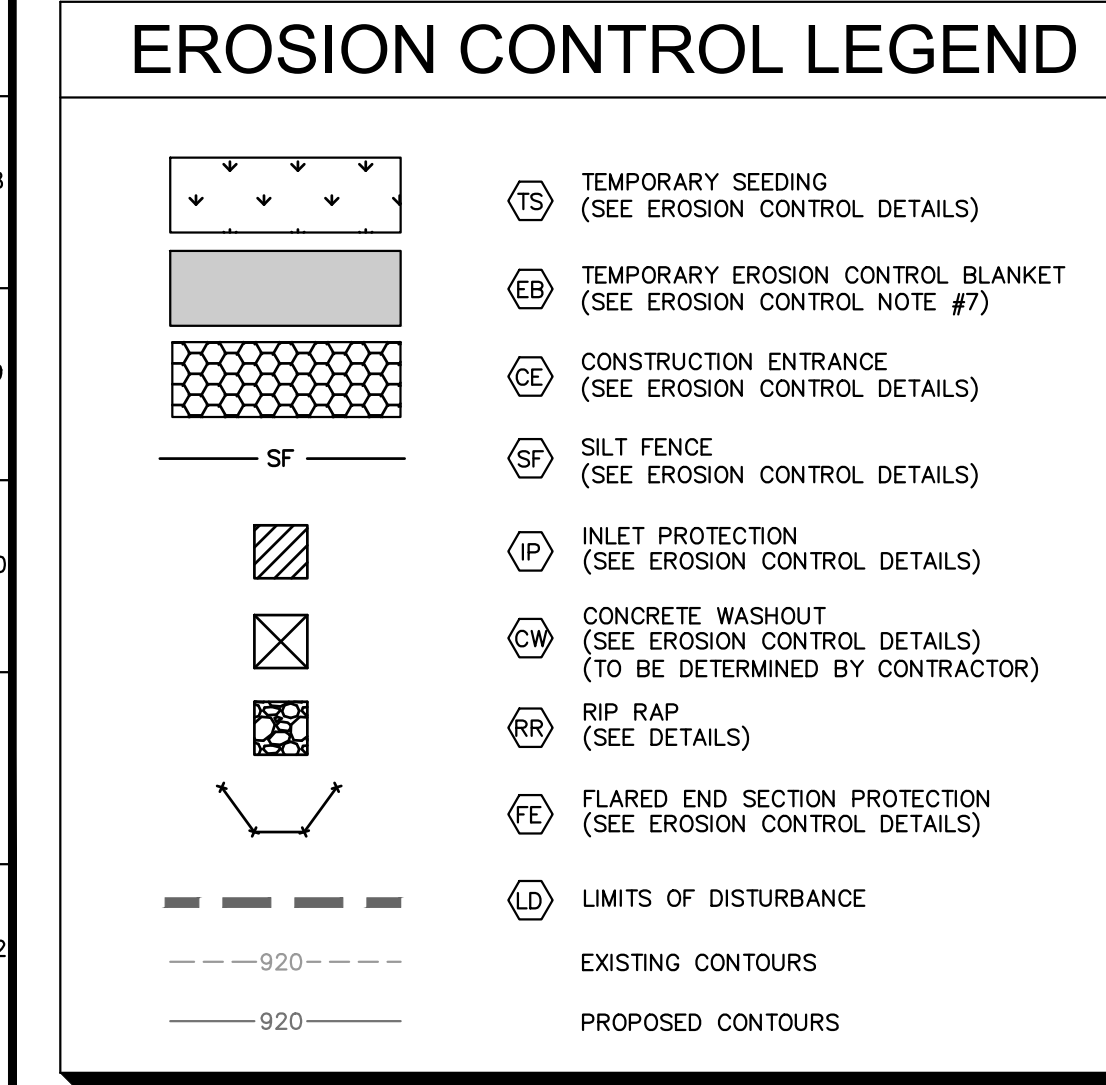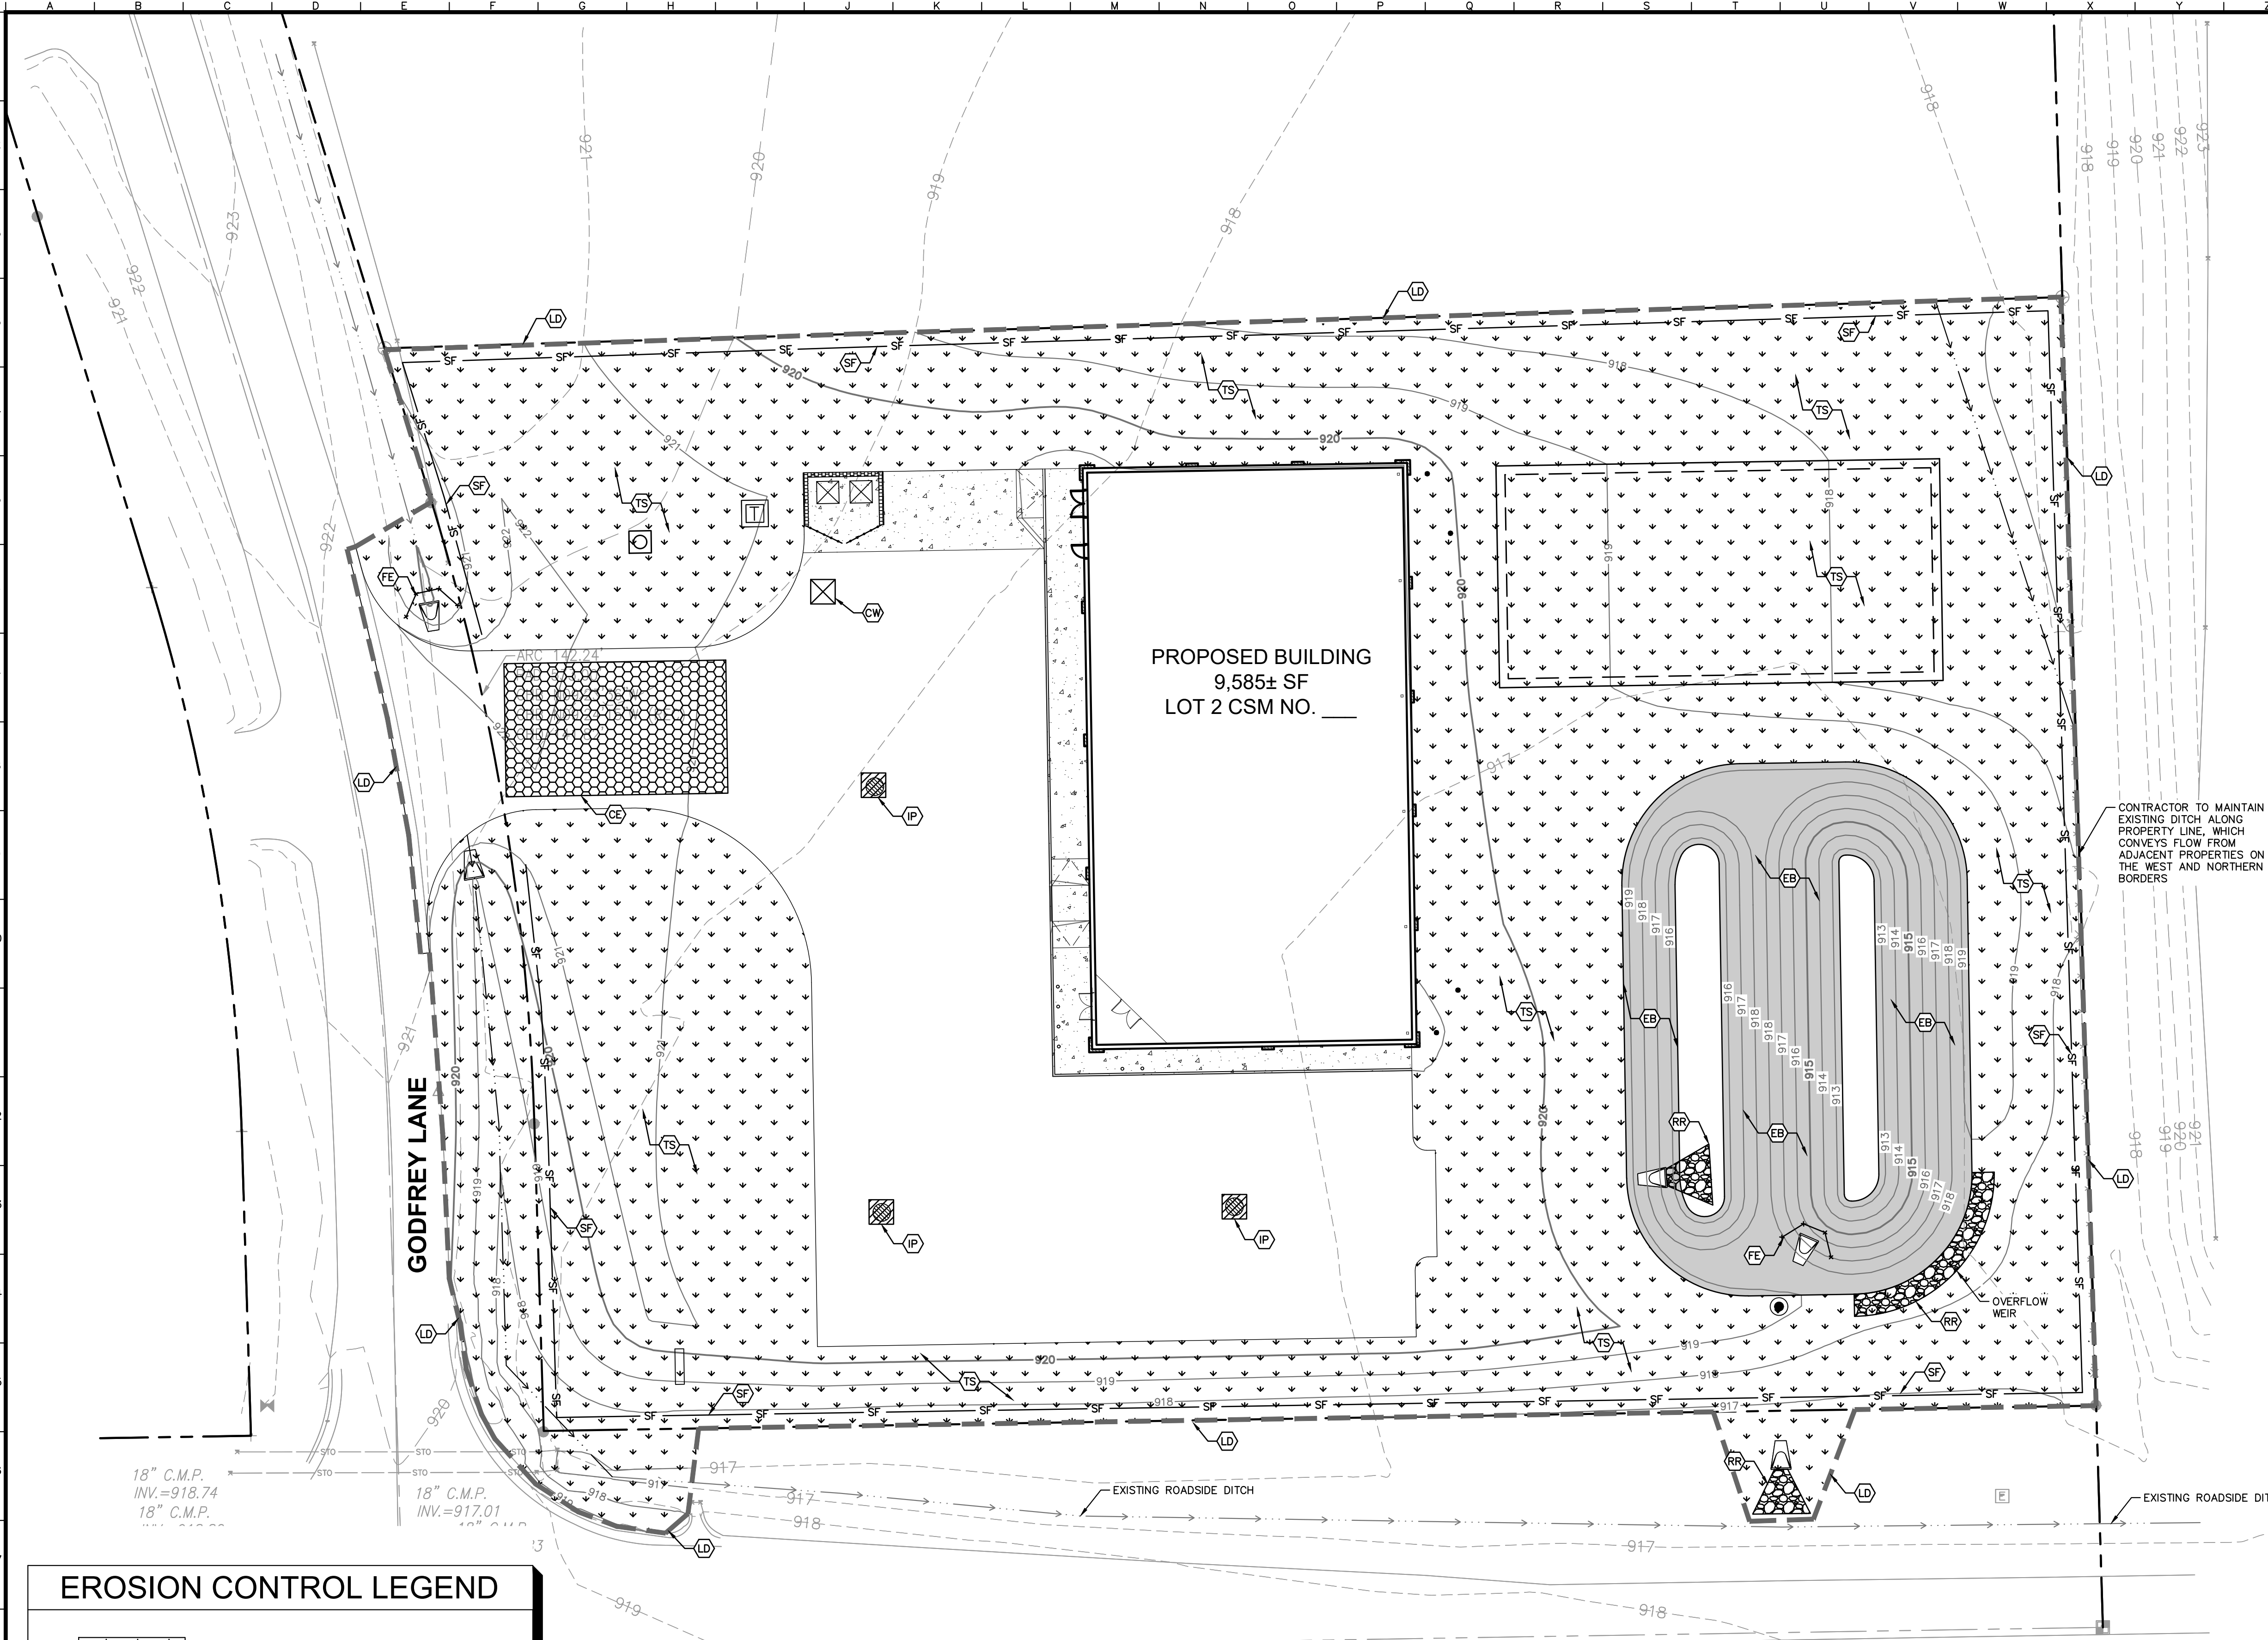I. ROUGH GRADING	CONSTRUCTION ENTRANCE/EXIT, SILT FENCE PROTECTION, CONCRETE WASHOUT AREA AND TREE PROTECTION SHALL BE INSTALLED PRIOR TO THE INITIATION OF ROUGH GRADING, AS NEEDED. TEMPORARY EROSION CONTROL MEASURES TO BE INSTALLED UPON COMPLETION OF ROUGH GRADING AT AS NECESSARY THROUGHOUT CONSTRUCTION.
II. UTILITY INSTALLATION	ALL PRIOR EROSION CONTROL MEASURES INSTALLED ABOVE TO BE MAINTAINED AS NECESSARY DURING UTILITY INSTALLATION. STORM STRUCTURE INLET PROTECTION SHALL BE INSTALLED AS STORM DRAINAGE SYSTEM IS CONSTRUCTED.
III. PAVING	ALL PRIOR EROSION CONTROL MEASURES INSTALLED ABOVE TO BE MAINTAINED AS NECESSARY DURING PAVING AND THROUGHOUT THE REMAINDER OF THE PROJECT.
IV. FINAL GRADING/SOIL STABILIZATION/ LANDSCAPING	ALL TEMPORARY EROSION CONTROL MEASURES TO BE REMOVED AT THE CONCLUSION OF THE PROJECT AS DIRECTED BY THE LOCAL MUNICIPALITY.





EROSION CONTROL NOTES

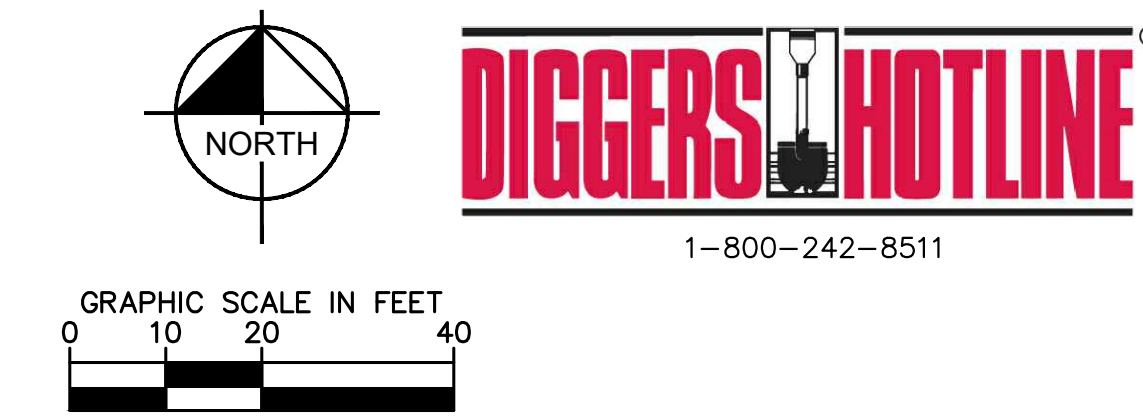1. CONSTRUCTION ENTRANCE SHALL BE LOCATED SO AS TO PROVIDE THE LEAST AMOUNT OF DISBURSE TO THE FLOW OF TRAFFIC IN AND OUT OF THE SITE. ADDITIONALLY, CONSTRUCTION ENTRANCE SHALL BE LOCATED TO CONCLUDE WITH THE PHASING OF THE PAVEMENT REPLACEMENT.
2. POST CONSTRUCTION STORM WATER POLLUTION CONTROL MEASURES INCLUDE STABILIZATION BY PERMANENT PAVING, DRAINAGE SYSTEM STRUCTURE, OR LANDSCAPING.
3. TEMPORARY AND PERMANENT STABILIZATION PRACTICES AND BMP'S SHALL BE INSTALLED AT THE EARLIEST POSSIBLE TIME DURING THE CONSTRUCTION SEQUENCE. AS AN EXAMPLE, PERMEABLE SILT FENCE SHALL BE INSTALLED BEFORE COMMENCEMENT OF ANY EROSION CONTROL MEASURES. OTHER BMP'S SHALL BE INSTALLED AS SOON AS PRACTICABLE AND SHALL BE MAINTAINED UNTIL FINAL SITE STABILIZATION IS ATTAINED. CONTRACTOR SHALL ALSO REFERENCE CIVIL AND LANDSCAPE PLANS SINCE PERMANENT STABILIZATION IS PROVIDED BY LANDSCAPING, THE BUILDING(S), AND SITE PAVING.
4. BMP'S HAVE BEEN LOCATED AS INDICATED ON THIS PLAN IN ACCORDANCE WITH GENERALLY ACCEPTED ENGINEERING PRACTICES IN ORDER TO MINIMIZE EROSION AND TRANSPORT OF SEDIMENT. SILT FENCES LOCATED AT TOE OF SLOPE AND INLET PROTECTION FOR INLETS RECEIVING SEDIMENT FROM SITE RUN-OFF.
5. THE PLACEMENT OF EROSION/SEDIMENTATION CONTROLS SHALL BE IN ACCORDANCE WITH THE APPROVED EROSION AND SEDIMENTATION CONTROL PLAN.
6. ANY MAJOR VARIATION IN MATERIALS OR LOCATIONS OF CONTROLS OR FENCES FROM THOSE SHOWN ON THE APPROVED PLANS WILL REQUIRE A REVISION AND MUST BE APPROVED BY THE REVIEWING ENGINEER, ENVIRONMENTAL SPECIALIST, GEOTECHNICAL ENGINEER, AND/OR AGRICULTURAL ENGINEER. MAJOR REVISIONS MUST BE APPROVED BY THE PLANNING AND DEVELOPMENT DEPARTMENT AND THE ENVIRONMENTAL DEPARTMENT. MINOR CHANGES OR ADDITIONAL CONTROL MEASURES TO BE MADE AS FIELD REQUIREMENTS TO THE EROSION AND SEDIMENTATION CONTROL PLAN SHALL BE REQUIRED BY THE ENVIRONMENTAL INSPECTOR DURING THE COURSE OF CONSTRUCTION TO CORRECT CONTROL INADEQUACIES AT NO ADDITIONAL COST TO THE OWNER.
7. CONTRACTOR SHALL PLACE EROSION CONTROL BLANKET (NORTH AMERICAN GREEN S150BN OR APPROVED EQUAL) ON ALL SITE AREAS WITH SLOPES GREATER THAN 4:1, AND IN THE BOTTOM AND SIDE SLOPES OF ALL SWALES.
8. PRIOR TO FINAL ACCEPTANCE, HAUL ROADS AND WATERWAY CROSSINGS CONSTRUCTED FOR TEMPORARY CONTRACTOR ACCESS MUST BE REMOVED, ACCUMULATED SEDIMENT REMOVED FROM THE WATERWAY AND THE AREA SURROUNDING TO ITS ORIGINAL GRADIENT. EXCESSIVE EROSION AND LAND CLEARING SHALL BE DISPOSED OF IN APPROVED SPOIL DISPOSAL SITES.
9. PERMANENT, FINAL PLANT COVERING OR STRUCTURES SHALL BE INSTALLED PRIOR TO FINAL ACCEPTANCE.
10. ALL CONTROL DEVICES THAT FUNCTION SIMILARLY TO SILT FENCE OR FIBER ROLL MUST BE REPAIRED, REPLACED OR SUPPLEMENTED WITH EFFECTIVE CONTROLS WHEN THEY BECOME NONFUNCTIONAL OR THE SEDIMENT REACHES ONE-THIRD THE HEIGHT OF THE DEVICE. THESE REPAIRS MUST BE MADE WITHIN 24 HOURS OF THE RAINFALL EVENT OR AS SOON AS FIELD CONDITIONS ALLOW ACCESS.
11. ALL SEDIMENT DELTAS AND DEPOSITS MUST BE REMOVED FROM SURFACE DRAINAGE AREAS, CATCH BASINS, AND OTHER DRAINAGE SYSTEMS. ALL AREAS WHERE SEDIMENT REMOVAL RESULTED IN EXPOSED SOIL MUST BE RESTABILIZED. THE REMOVAL AND STABILIZATION MUST TAKE PLACE IMMEDIATELY, BUT NO MORE THAN 7 DAYS AFTER THE RAINFALL EVENT UNLESS PRECLUDED BY ADVERSE WEATHER. REGULAR VISUAL INSPECTION AND MAINTENANCE EFFORTS MUST BE USED TO OBTAIN ACCESS. ONCE ACCESS IS OBTAINED, REMOVAL AND STABILIZATION MUST TAKE PLACE IMMEDIATELY, BUT NO MORE THAN 14 DAYS AFTER THE RAINFALL EVENT. THE CONTRACTOR IS RESPONSIBLE FOR OBTAINING NECESSARY PERMITS FROM ALL APPROPRIATE AUTHORITIES AND RECEIVING THE APPLICABLE PERMITS PRIOR TO CONDUCTING ANY WORK.
12. ACCUMULATIONS OF TRACKED AND DEPOSITED SEDIMENT MUST BE REMOVED FROM OFF-SITE PAVED SURFACES WITHIN 24 HOURS OR SOONER IF REQUIRED. SEDIMENT TRACKING MUST BE MINIMIZED BY THE APPROPRIATE MANAGEMENT PRACTICES LIKE DESIGNATED OFF-SITE PARKING AREAS. CONTRACTOR IS RESPONSIBLE FOR STREET SWEEPING AND/OR SCRAPING IF YOUR PRACTICES ARE NOT ADEQUATE TO PREVENT SEDIMENT FROM BEING TRACKED FROM THE SITE.
13. SURFACE WATERS, DRAINAGE DITCHES AND CONVEYANCE SYSTEMS MUST BE INSPECTED FOR SEDIMENT DEPOSITS.
14. THE CONTRACTOR SHALL INSTALL AND MAINTAIN ALL EROSION CONTROL MEASURES AS INDICATED ON THIS SHEET IN ACCORDANCE WITH THE STORMWATER POLLUTION PREVENTION PLAN (SWPPP) PREPARED BY THE OWNER AND ASSOCIATES, INC. THE CONTRACTOR IS RESPONSIBLE FOR IMPLEMENTING THE PROVISIONS INDICATED IN THE SWPPP, INCLUDING EROSION CONTROL MEASURES AND INSPECTION FREQUENCY, AS REQUIRED BY THE WISCONSIN DNR PERMIT PROGRAM REQUIREMENTS.
15. PUMPING SEDIMENT LADEN WATER INTO ANY STORMWATER FACILITY THAT IS NOT DESIGNATED TO BE A SEDIMENT TRAP, DRAINAGEWAY, OR OFFSITE AREA EITHER DIRECTLY OR INDIRECTLY WITHOUT FILTRATION IS PROHIBITED.
16. SOIL STOCKPILES SHALL NOT BE LOCATED IN A DRAINAGEWAY, FLOOD PLAIN AREA OR A DESIGNATED BUFFER, UNLESS OTHERWISE APPROVED, UNDER SPECIFIC CONDITIONS TO BE ESTABLISHED BY THE DIRECTOR OR ADMINISTRATOR.
17. STOCKPILES TO REMAIN IN PLACE FOR MORE THAN THREE DAYS SHALL BE PROVIDED WITH SESC MEASURES. MATERIAL IS TO BE HAULED OFF IMMEDIATELY AND LEGALLY IF NO STOCKPILE IS TO REMAIN IN PLACE.
18. ALL TEMPORARY SESC MEASURES SHALL BE REMOVED WITHIN 30 DAYS AFTER FINAL STABILIZATION IS ACHIEVED, TRAPPED SEDIMENT AND OTHER DISTURBED SOILS RESULTING FROM TEMPORARY MEASURES SHALL BE PROPERLY DISPOSED OF PRIOR TO PERMANENT STABILIZATION.
19. WATER REMOVED FROM TRAPS, BASINS, AND OTHER WATER HOLDING DEPRESSIONS OR EXCAVATIONS MUST FIRST PASS THROUGH A SEDIMENT TRAP AND/OR FILTRATION UNIT. ALL DRAINAGEWAYS AND STORMWATER DISCHARGE LOCATIONS SHALL BE PROTECTED FROM EROSION.
20. SITE STABILIZATION REQUIREMENTS ARE AS FOLLOWS:
 - 20.1. WHERE THE INITIATION OF STABILIZATION MEASURE BY THE 7TH DAY AFTER CONSTRUCTION ACTIVITY TEMPORARILY OR PERMANENTLY CEASES ON A PORTION OF THE SITE IS REQUIRED, THE STABILIZATION MEASURE SHALL BE INITIATED AS SOON AS PRACTICABLE.
 - 20.2. WHERE CONSTRUCTION ACTIVITY WILL RESUME ON A PORTION OF THE SITE WITHIN 14 DAYS FROM WHEN ACTIVITIES CEASED, (E.G. THE TOTAL TIME PERIOD THAT CONSTRUCTION ACTIVITY IS TEMPORARILY CEASED IS LESS THAN 14 DAYS) THEN STABILIZATION MEASURES DO NOT HAVE TO BE INITIATED ON THAT PORTION OF THE SITE BY THE 7TH DAY AFTER CONSTRUCTION ACTIVITY TEMPORARILY CEASED.

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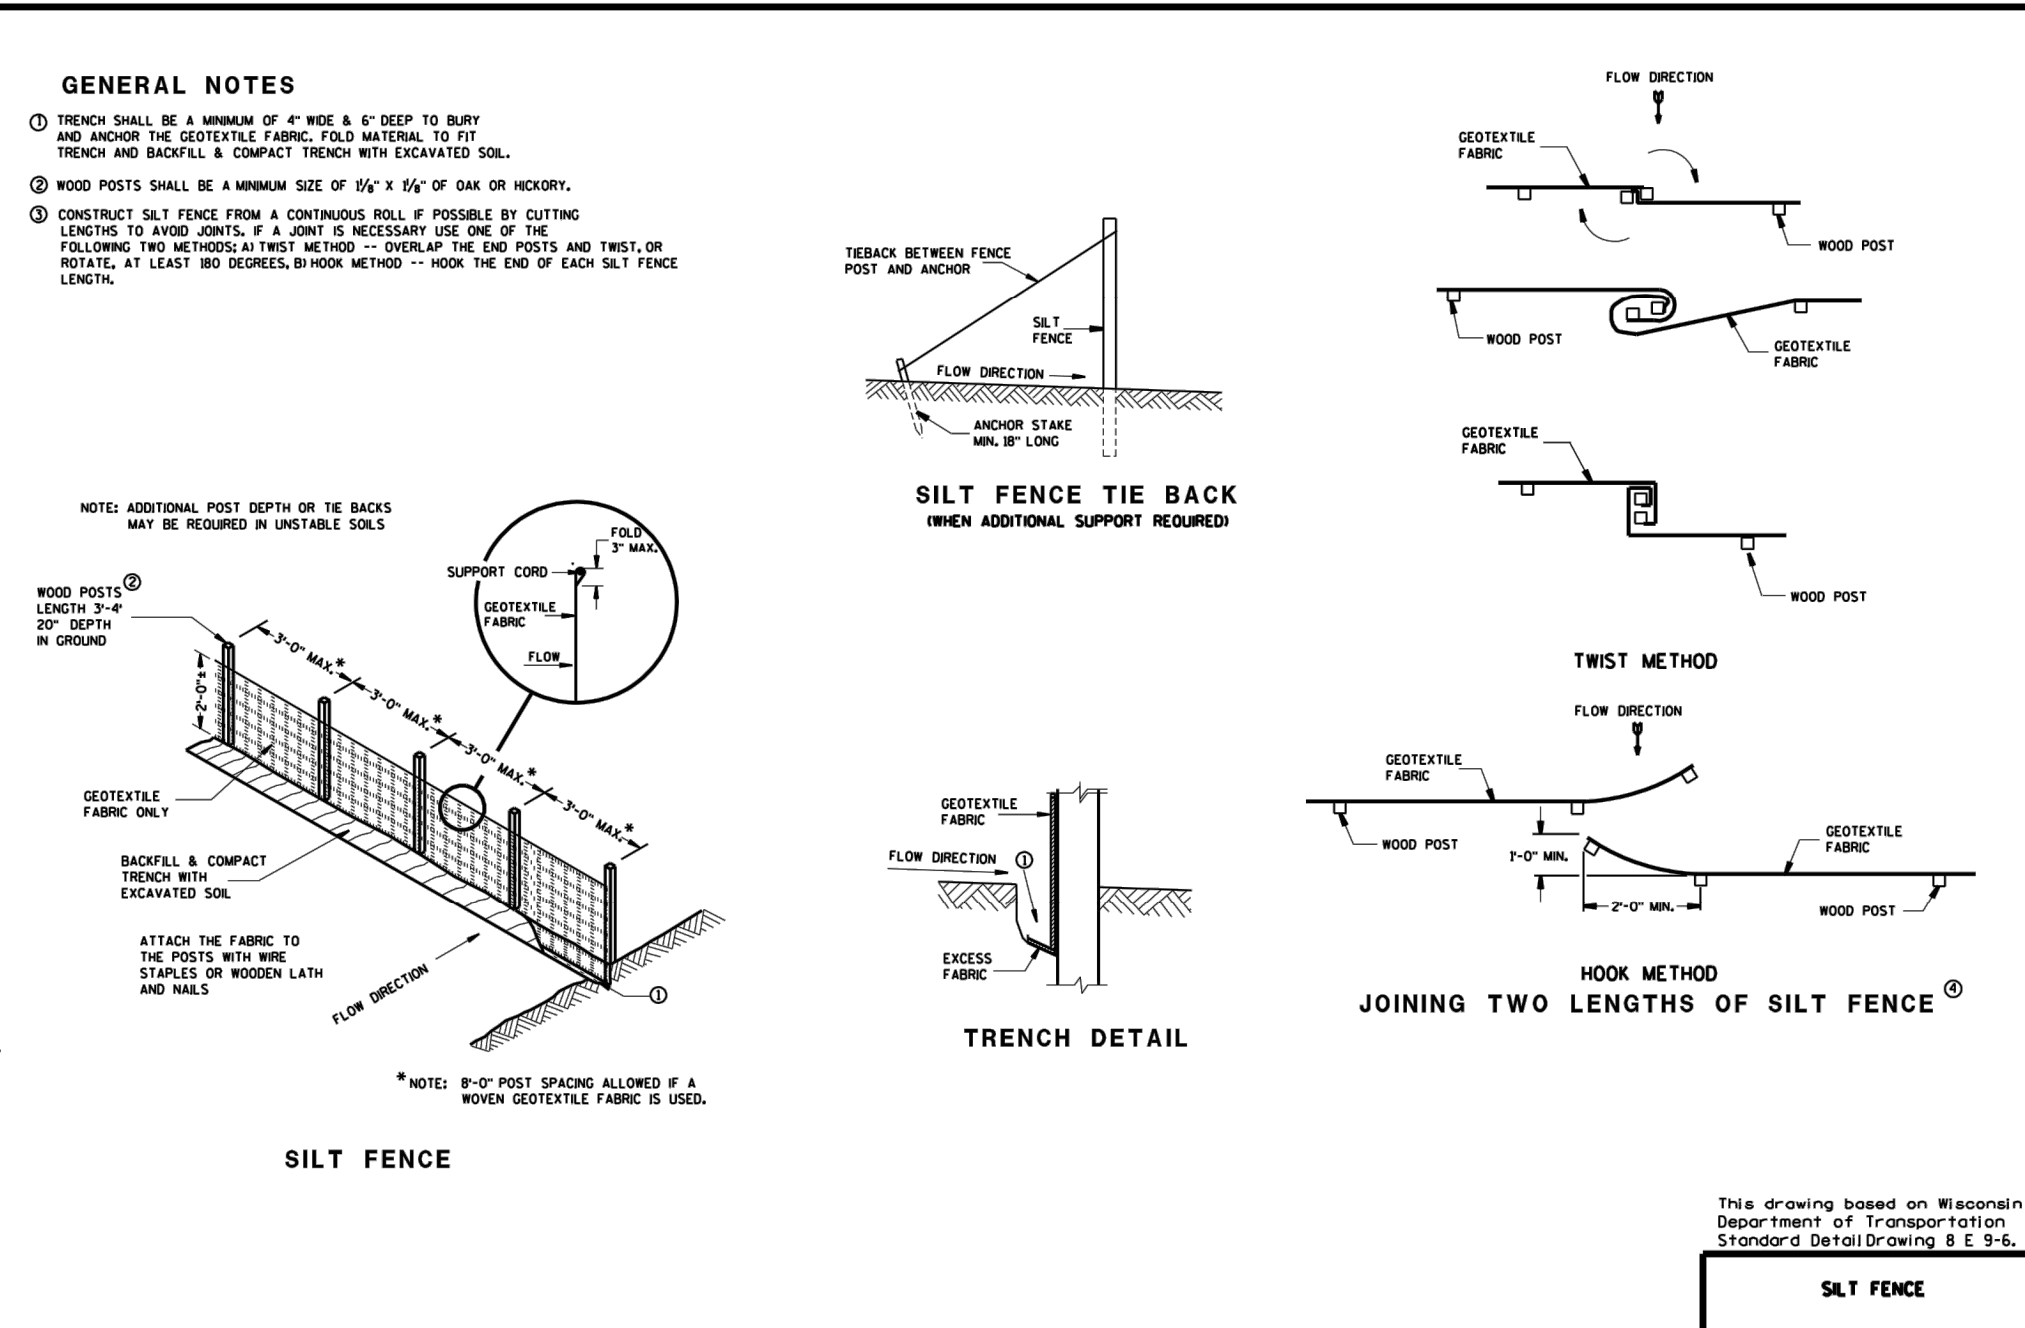
Drawing name: K:\GIS\LDE\168708007_DollarGeneral_Erge_MV2 Design\CAD\PlanSheets\Final Engineering\C4.1 Aug 17, 2020 9:03am by: brethickey
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1. PREPARE SOIL BEFORE INSTALLING BLANKETS, INCLUDING ANY NECESSARY APPLICATION OF LIME, FERTILIZER, AND SEED.
 2. BEGIN AT THE TOP OF THE SLOPE BY ANCHORING THE BLANKET IN A 6" DEEP X 6" WIDE TRENCH WITH APPROXIMATELY 12" OF BLANKET EXTENDED BEYOND THE UP-SLOPE PORTION OF THE TRENCH AS SHOWN IN DETAIL 2. ANCHOR THE BLANKET WITH A ROW OF STAPLES/STAKES APPROXIMATELY 12" APART IN THE BOTTOM OF THE TRENCH. BACKFILL AND COMPACT THE TRENCH AFTER STAPLING. APPLY SEED TO COMPACTED SOIL AND FOLD REMAINING 12" PORTION OF BLANKET BACK OVER SEED AND COMPACTED SOIL. SECURE BLANKET OVER COMPACTED SOIL WITH A ROW OF STAPLES/STAKES SPACED APPROXIMATELY 12" APART ACROSS THE WIDTH OF THE BLANKET.
 3. ROLL THE BLANKETS (A) DOWN OR (B) HORIZONTALLY ACROSS THE SLOPE. BLANKETS WILL UNROLL WITH APPROPRIATE SIDE AGAINST THE SOIL SURFACE. ALL BLANKETS MUST BE SECURELY FASTENED TO SOIL SURFACE BY PLACING STAPLES/STAKES IN APPROPRIATE LOCATIONS AS PER MANUFACTURER'S RECOMMENDATION.
 4. THE EDGES OF PARALLEL BLANKETS MUST BE STAPLED WITH MINIMUM 6" OVERLAP. TO ENSURE PROPER SEAM ALIGNMENT, PLACE THE EDGE OF THE OVERLAPPING BLANKET (BLANKET BEING INSTALLED ON TOP) EVEN WITH THE SEAM STITCH ON THE PREVIOUSLY INSTALLED BLANKET.
 5. CONSECUTIVE BLANKETS SPICED DOWN THE SLOPE MUST BE PLACED END OVER END (SHINGLE STYLE) WITH AN APPROXIMATE 3" OVERLAP. STAPLE THROUGH OVERLAPPED AREA, APPROXIMATELY 12" APART ACROSS ENTIRE BLANKET WIDTH.
 6. PLACE STAPLES/STAKES PER MANUFACTURER'S RECOMMENDATION FOR THE APPROPRIATE SLOPE BEING APPLIED.
- NOTES:**
1. IN LOOSE SOIL CONDITIONS, THE USE OF STAPLE OR STAKE LENGTHS GREATER THAN 6" MAY BE NECESSARY TO PROPERLY SECURE THE BLANKETS.
 2. FOLLOW EROSION CONTROL TECHNOLOGY COUNCIL SPECIFICATION FOR PRODUCT SELECTION.
 3. PREVIOUS LAND WITH SLOPES RUNNING GREATER THAN OR EQUAL TO 4:1 SHALL CONTAIN SLOPE STABILIZATION BLANKET

EROSION CONTROL BLANKET (SLOPE INSTALLATION)

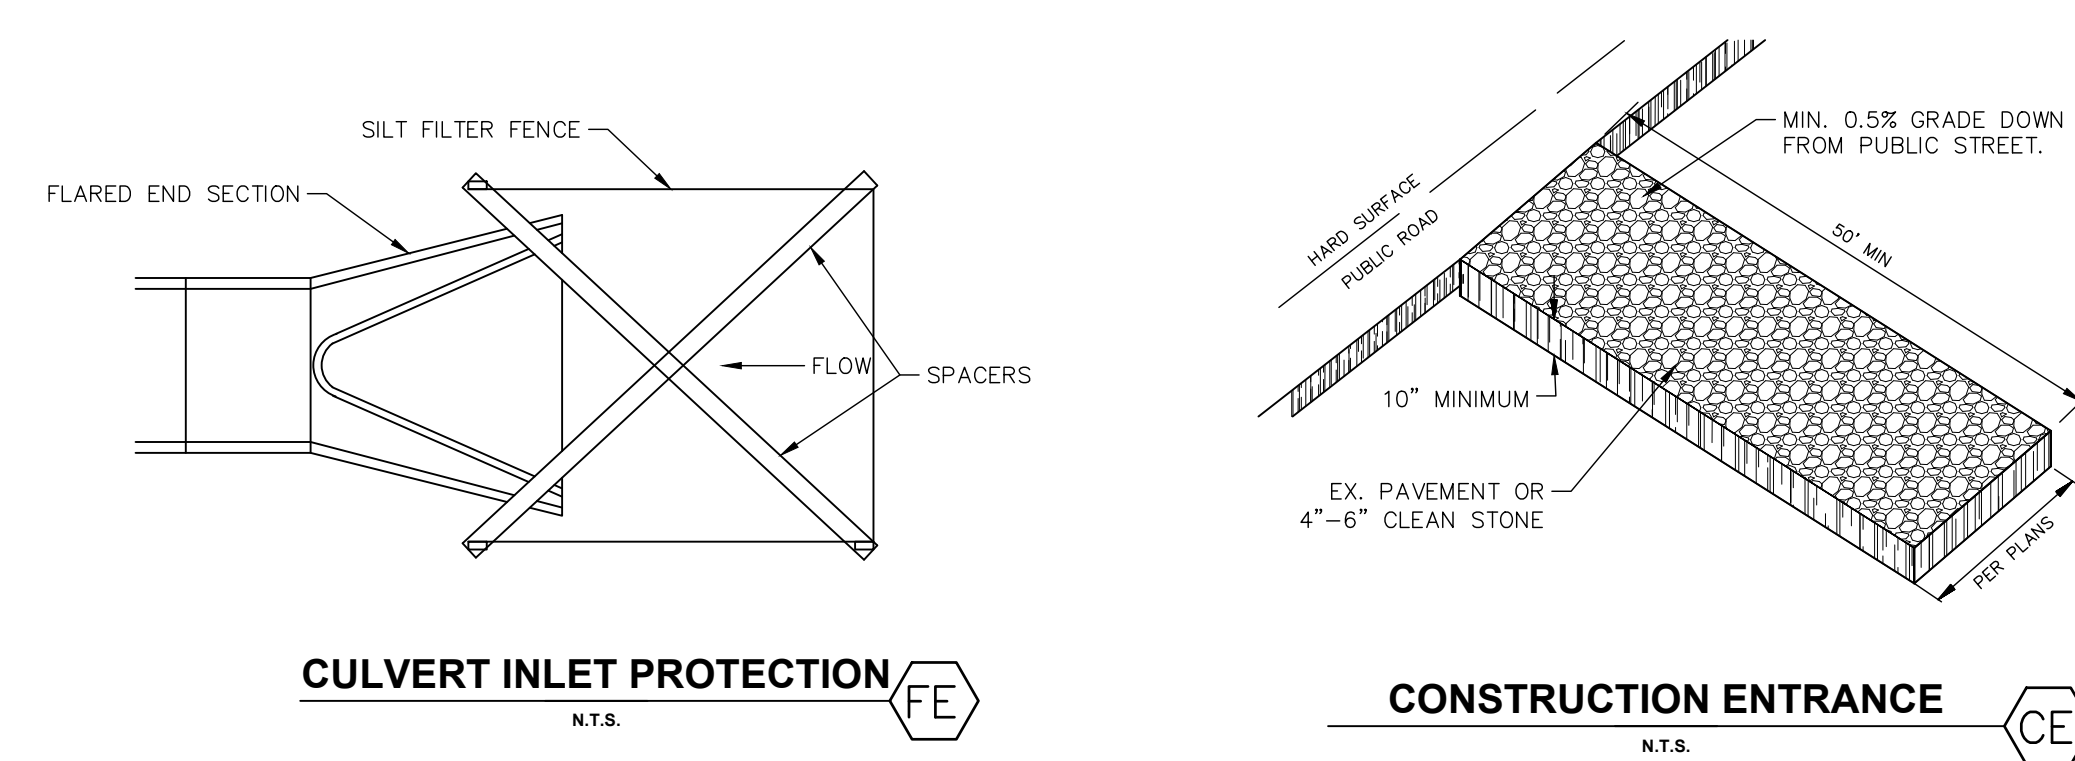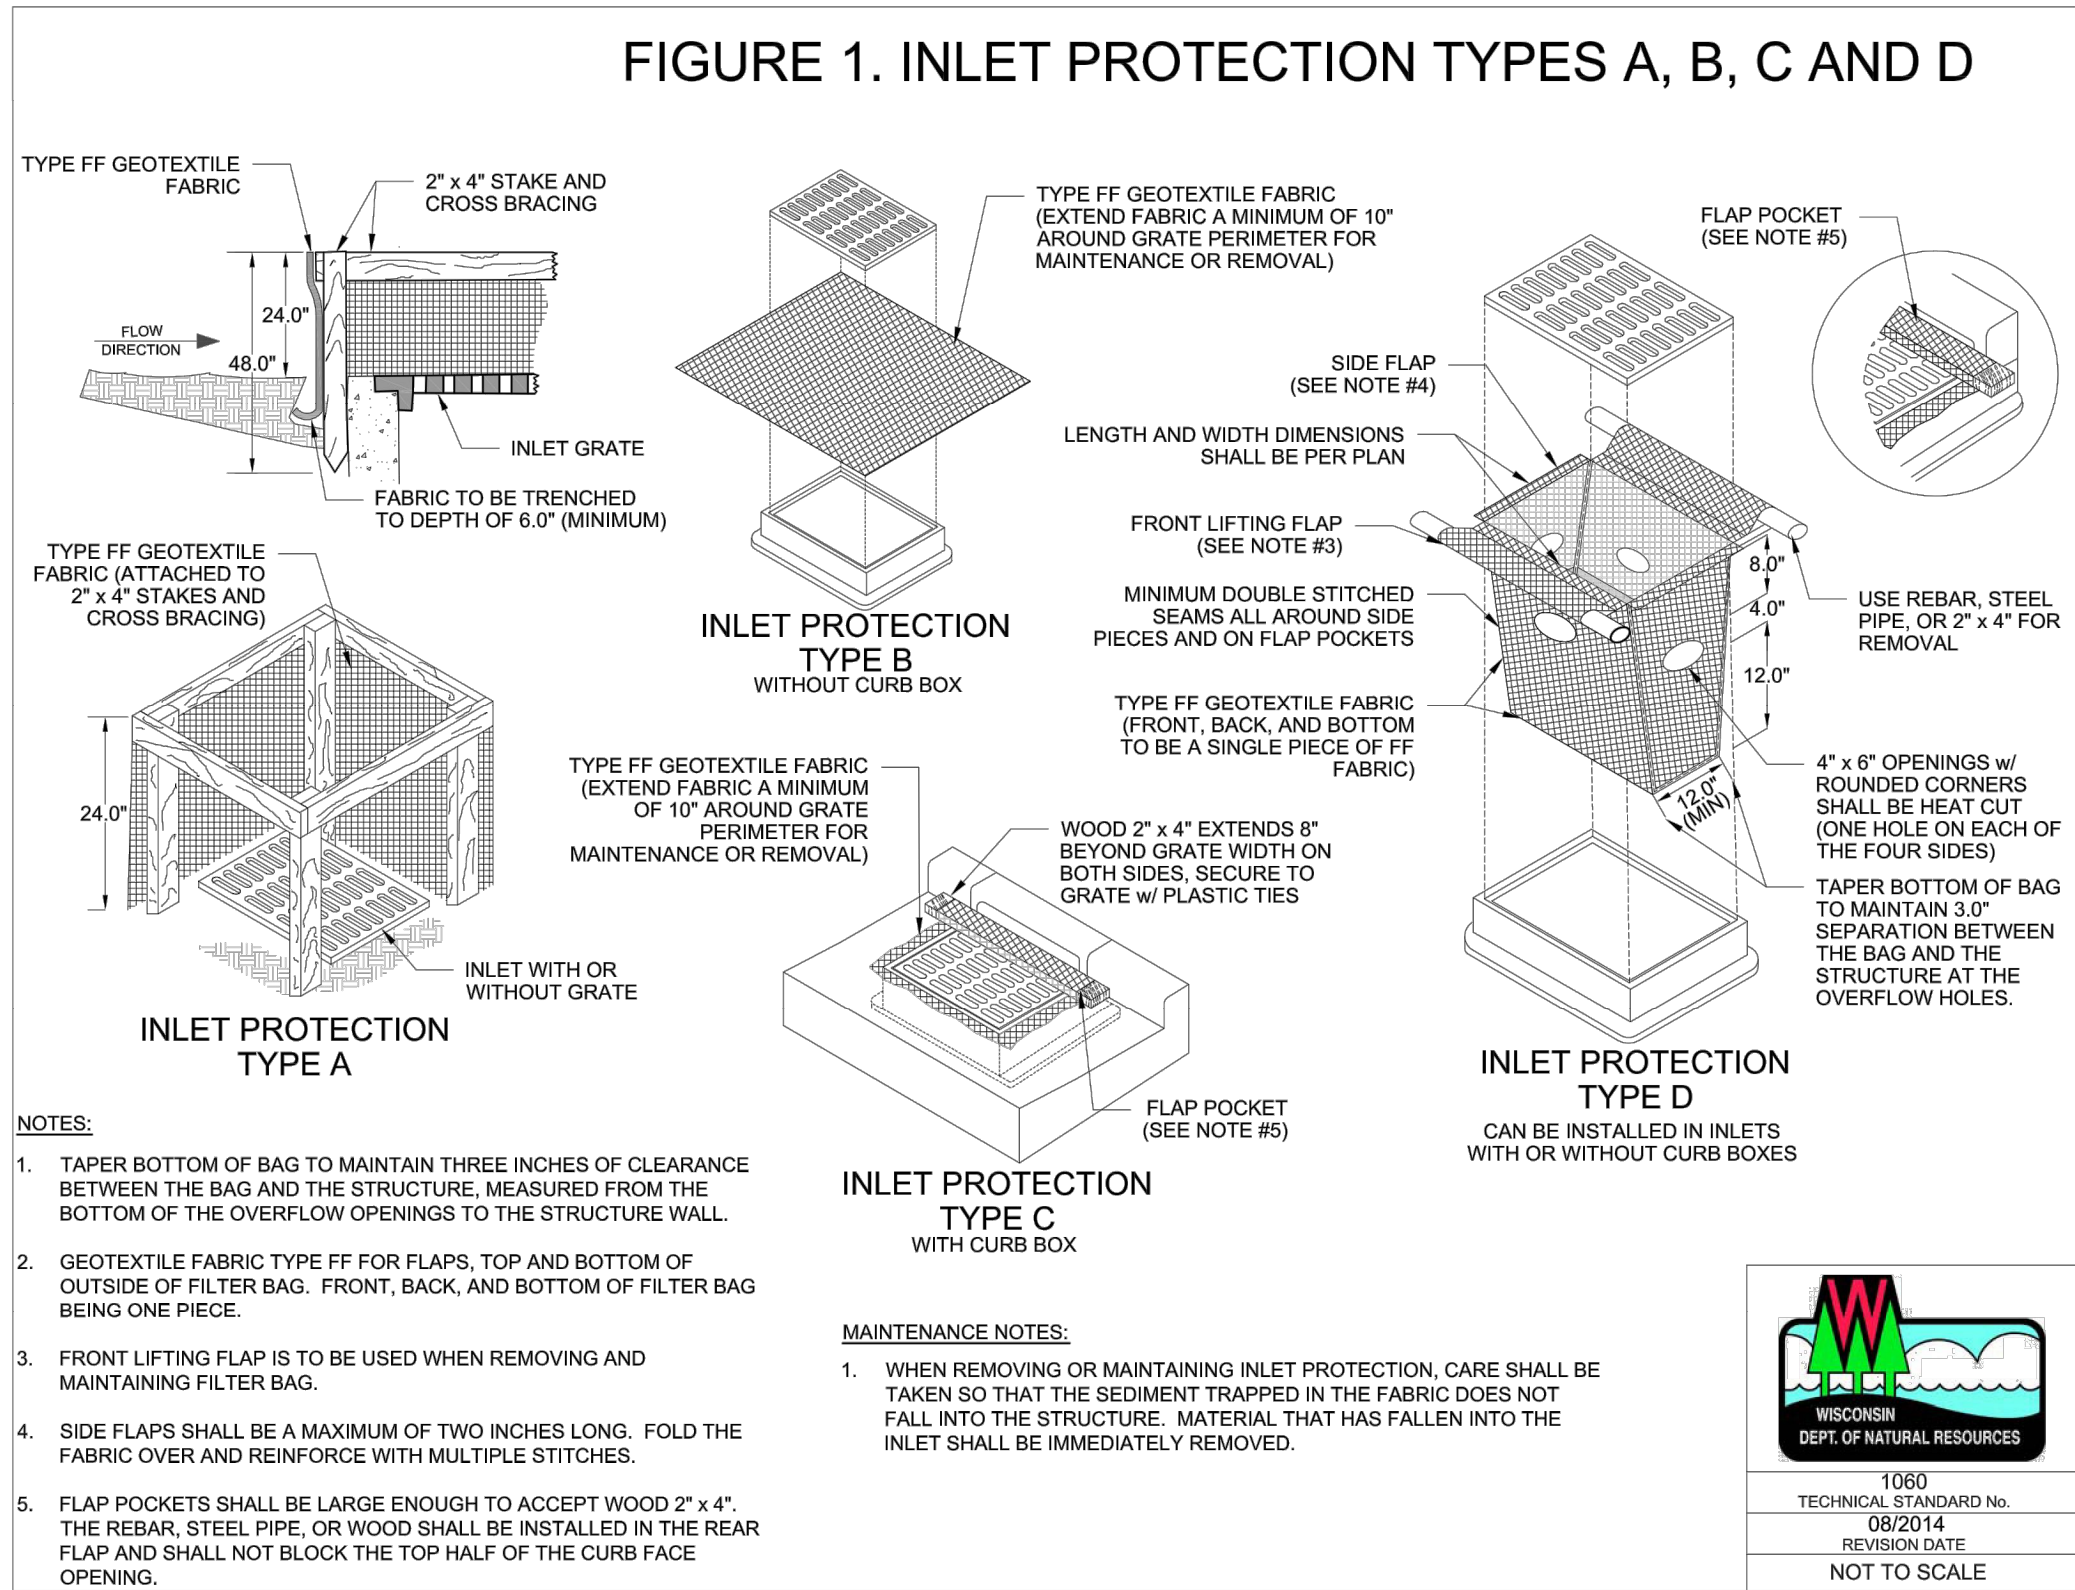
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STABILIZATION TYPE	JAN.	FEB.	MAR.	APR.	MAY	JUNE	JULY	AUG.	SEPT.	OCT.	NOV.	DEC.
PERMANENT SEEDING			A			*	*					
DORMANT SEEDING	B										B	
TEMPORARY SEEDING			C			D						
SODDING			E									
MULCHING	F		**									

- A KENTUCKY BLUEGRASS 90 LBS/ACRE MIXED WITH PERENNIAL RYEGRASS 30 LBS/ACRE
- B KENTUCKY BLUEGRASS 135 LBS/ACRE MIXED WITH PERENNIAL RYEGRASS 45 LBS/ACRE + 2 TONS STRAW MULCH/ACRE
- C SPRING OATS 100 LBS/ACRE
- D WHEAT OR CEREAL RYE 150 LBS/ACRE
- E SOD
- F STRAW MULCH 2 TONS/ACRE
- * WATERING NEEDED DURING JUNE AND JULY
- ** WATERING NEEDED FOR 2 TO 3 WEEKS AFTER APPLYING SOD

SEEDING CHART



- NOTES:**
1. THE ROCK RIPRAP SHALL MEET IDOT REQUIREMENTS FOR GRADATION NO. RR-3 & RR-4, QUALITY DESIGNATION "A".
 2. GEOTEXTILE (NON-WOVEN) MINIMUM CRITERIA:
 - 2.1. WEIGHT OF GEOTEXTILE (OZ/SQ. YD.) 6
 - 2.2. TENSILE STRENGTH (LB) ASTM D 4632 180
 - 2.3. ELONGATION AT FAILURE (%) ASTM D 4632 ≥ 50
 - 2.4. PUNCTURE (LB) ASTM D 4833 80
 - 2.5. ULTRAVIOLET LIGHT (% RESIDUAL TENSILE STRENGTH) ASTM D 4355 MIN 70
 - 2.6. APPARENT OPENING SIZE (AOS) ASTM D 4751 MAX 40 SIEVE
 - 2.7. PERMITTIVITY SEC-1 ASTM D 4491 MIN 0.70
 3. ANY GEOTEXTILE SPLICES SHALL OVERLAP A MINIMUM OF 18 INCHES, WITH UPSTREAM OR UPSLOPE GEOTEXTILE OVERLAPPING THE ABUTTING DOWNSLOPE GEOTEXTILE.
 4. APRON WIDTH W1 SHALL BE 3 TIMES THE CULVERT PIPE DIAMETER. APRON WIDTH W2 SHALL BE EQUAL TO L1 PLUS THE PIPE DIAMETER.
 5. ROCK THICKNESS D SHALL BE AT LEAST 1.5 TIMES THE RIPRAP D100 SIZE.
 6. APRON LENGTH L1 AND ROCK RIPRAP HAS BEEN SIZED ACCORDING TO ILLINOIS URBAN MANUAL ROCK OUTLET PROTECTION STANDARD 910 BASED CALCULATED VELOCITY FOR THIS PROJECT SITE. PLEASE SEE TABLE 1 FOR DETAILS.

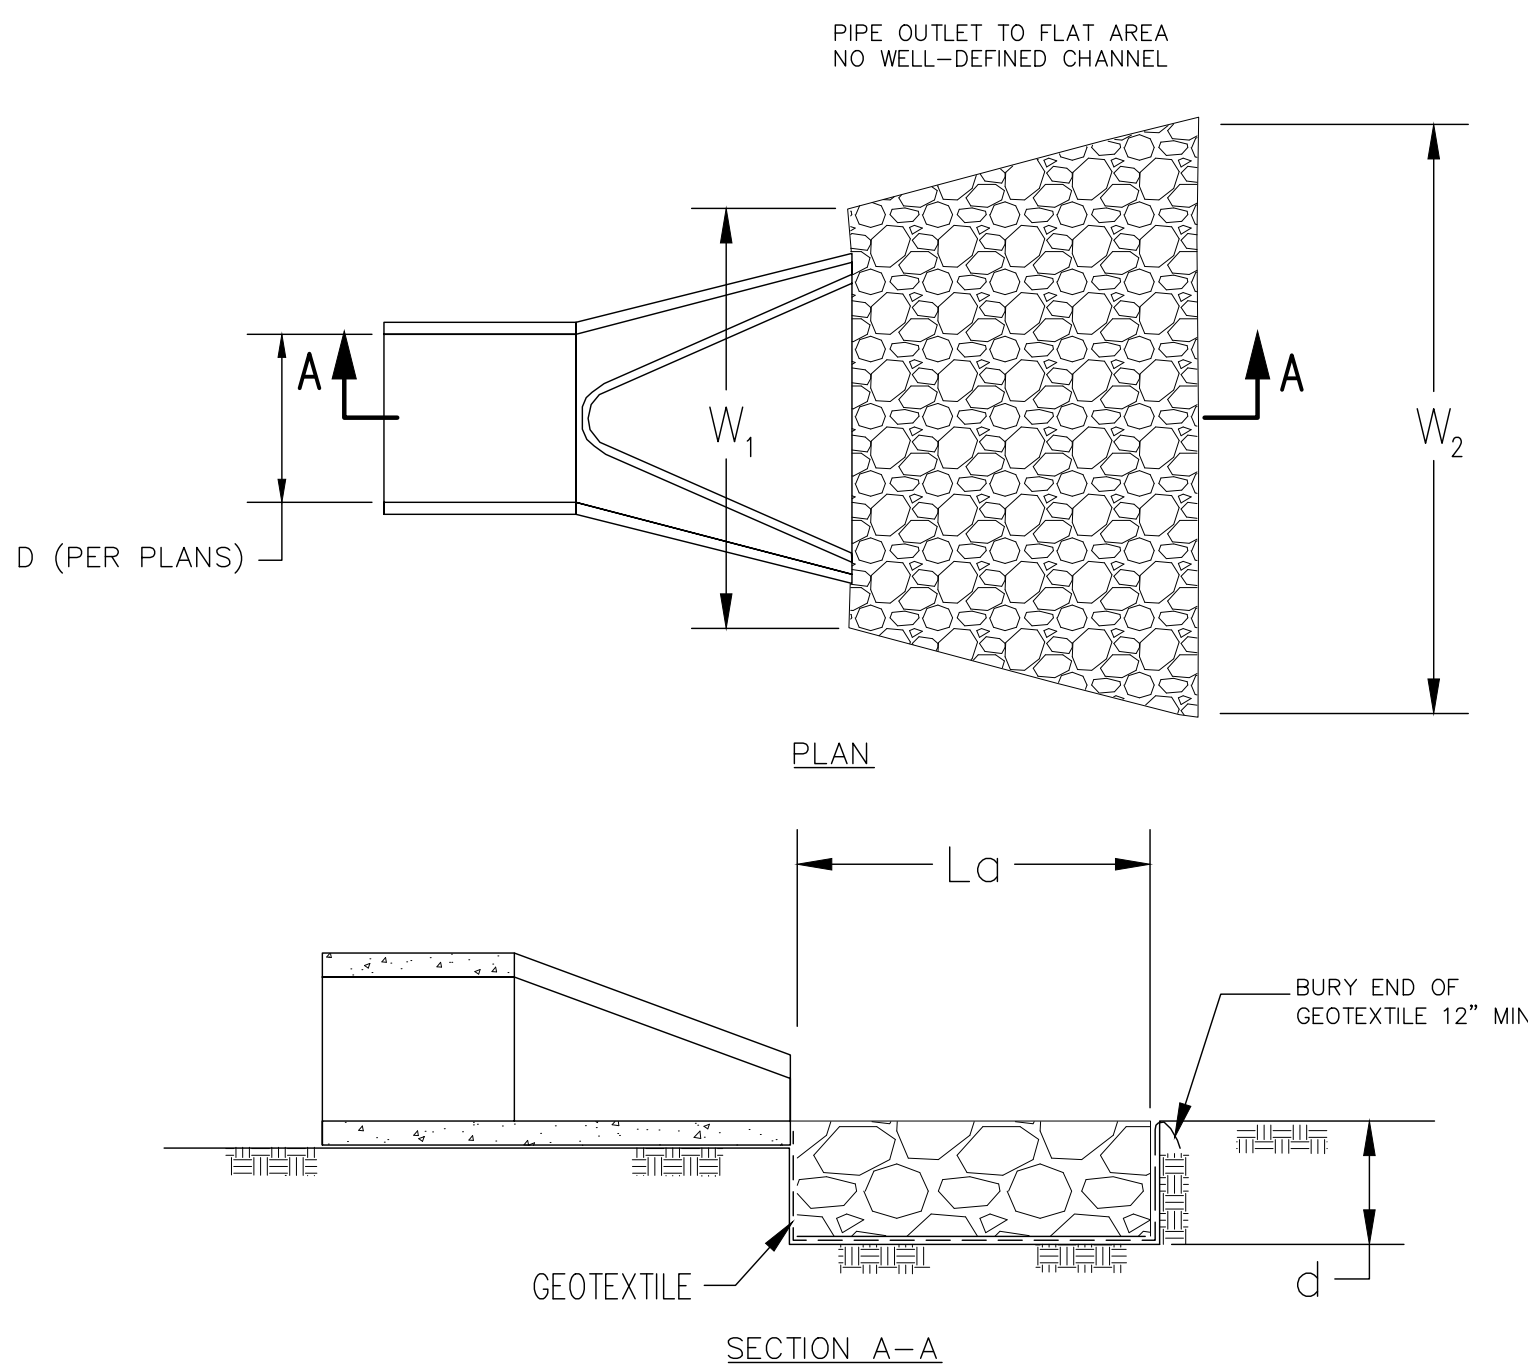RIPRAP DIMENSION TABLE							
INLET PIPE SIZE d (IN)	LENGTH OF APRON L1 (FT)	MEDIAN RIPRAP SIZE C (IN)	WIDTH OF APRON U/S FACE W1 (FT)	WIDTH OF APRON D/S FACE W2 (FT)	DEPTH OF RIPRAP d (IN)	AREA OF RIPRAP (SQ)	VOLUME OF RIPRAP (CY)
12	10	6	3.00	13.00	15	8.89	3.7
15	10	6	3.75	13.75	15	9.72	4.1
18	15	9	4.50	19.50	20	20.00	11.1
21	15	9	5.25	20.25	20	21.25	11.8
24	18	9	6.00	24.00	20	30.00	16.7
27	18	9	6.75	24.75	20	31.50	17.5
30	20	9	7.50	27.50	20	38.89	21.6
36	24	12	9.00	33.00	28	56.00	43.6
42	27	12	10.50	37.50	30	72.00	60.0
48	27	15	12.00	39.00	32	76.50	68.0
54	27	15	13.50	40.50	32	81.00	72.0
60	36	15	15.00	51.00	32	132.00	118.0
72	44	18	18.00	62.00	32	195.56	174.0

RIP RAP DETAIL OUTLET PROTECTION


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DIGGERS HOTLINE



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CONCRETE WASHOUT
N.T.S.

SCALE:	AS NOTED	DESIGNED BY: JPM	DRAWN BY: JPM	CHECKED BY: JMM
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THE OVERLAND GROUP				
EROSION CONTROL NOTES & DETAILS				
DOLLAR GENERAL NEC HIGHWAY NN & GODFREY LN. TOWN OF EAGLE, WI 53119				
ORIGINAL ISSUE: 07/29/2020 KHA PROJECT NO. 168708007 SHEET NUMBER				
TOWN COMMENTS: 08/14/20 JPM BY: DATE: REVISIONS: 1 No.				



DOLLAR GENERAL NEC HIGHWAY NN. & GODFREY LN. TOWN OF EAGLE, WI 53119		GRADING PLAN		THE OVERLAND GROUP		Kimley»Horn © 2020 KIMLEY HORN AND ASSOCIATES, INC. 10000 WISCONSIN AVENUE, SUITE 600 WARRENVILLE, IL 60055 WWW.KIMLEY-HORN.COM		SCALE: AS NOTED DESIGNED BY: JPM DRAWN BY: JPM CHECKED BY: JMM		1 No. DATE BY		08/14/20 JPM	
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

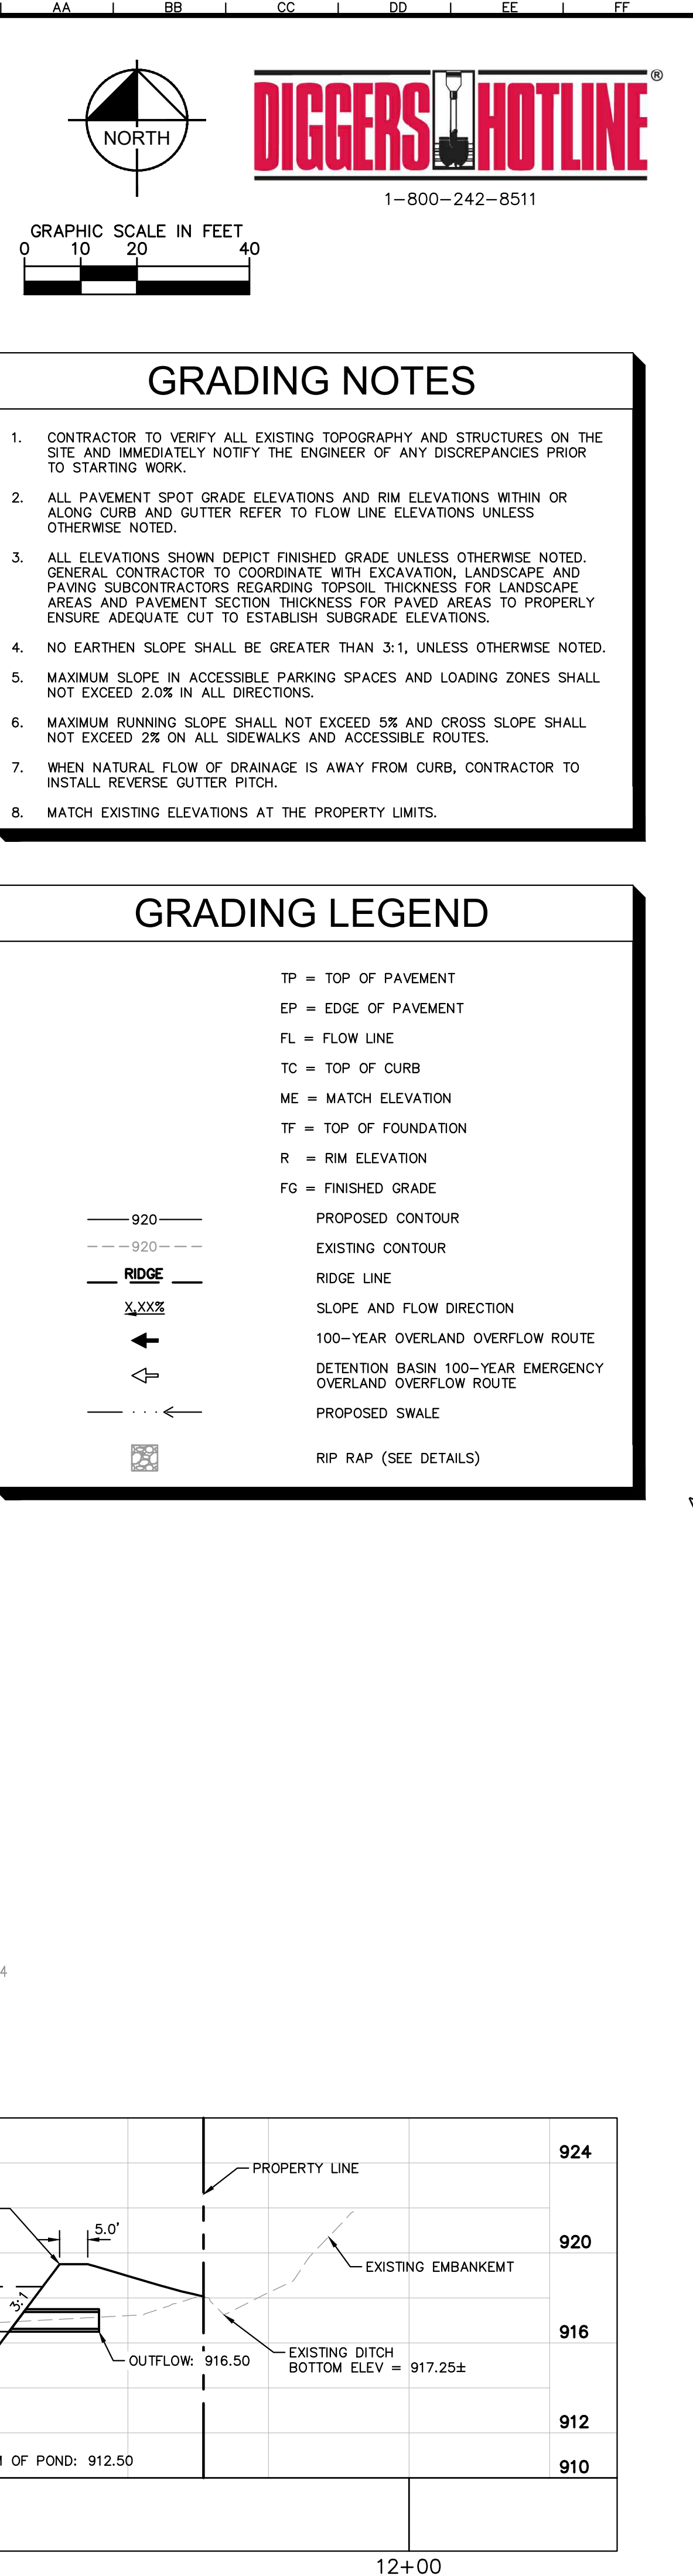

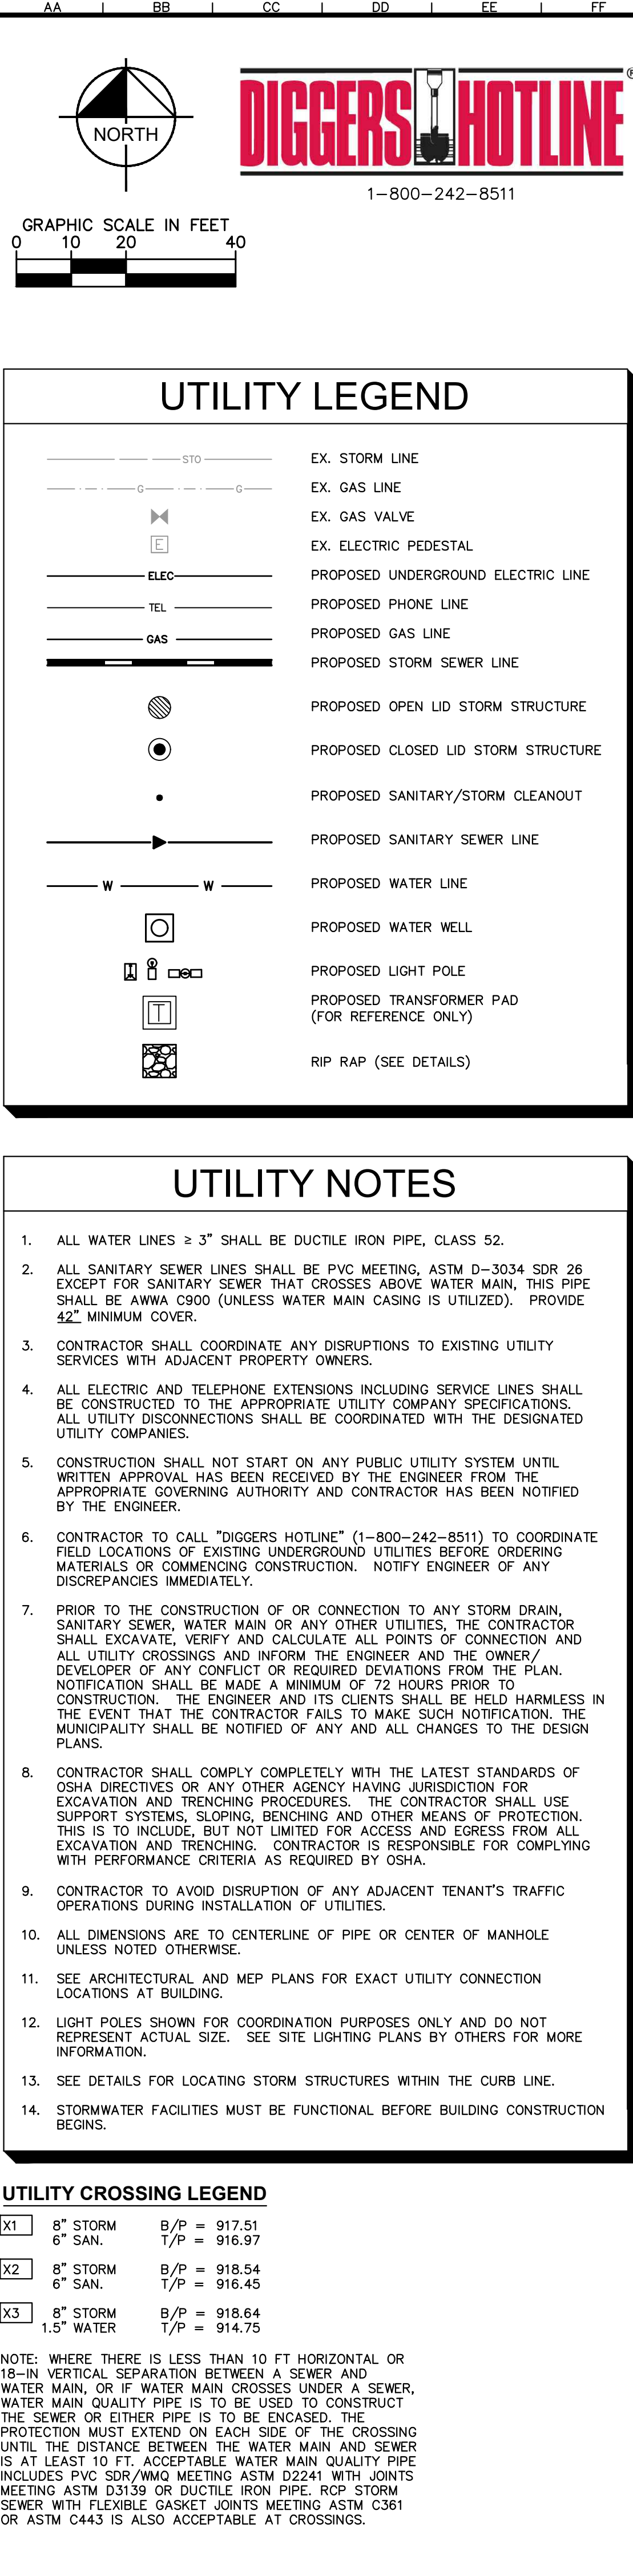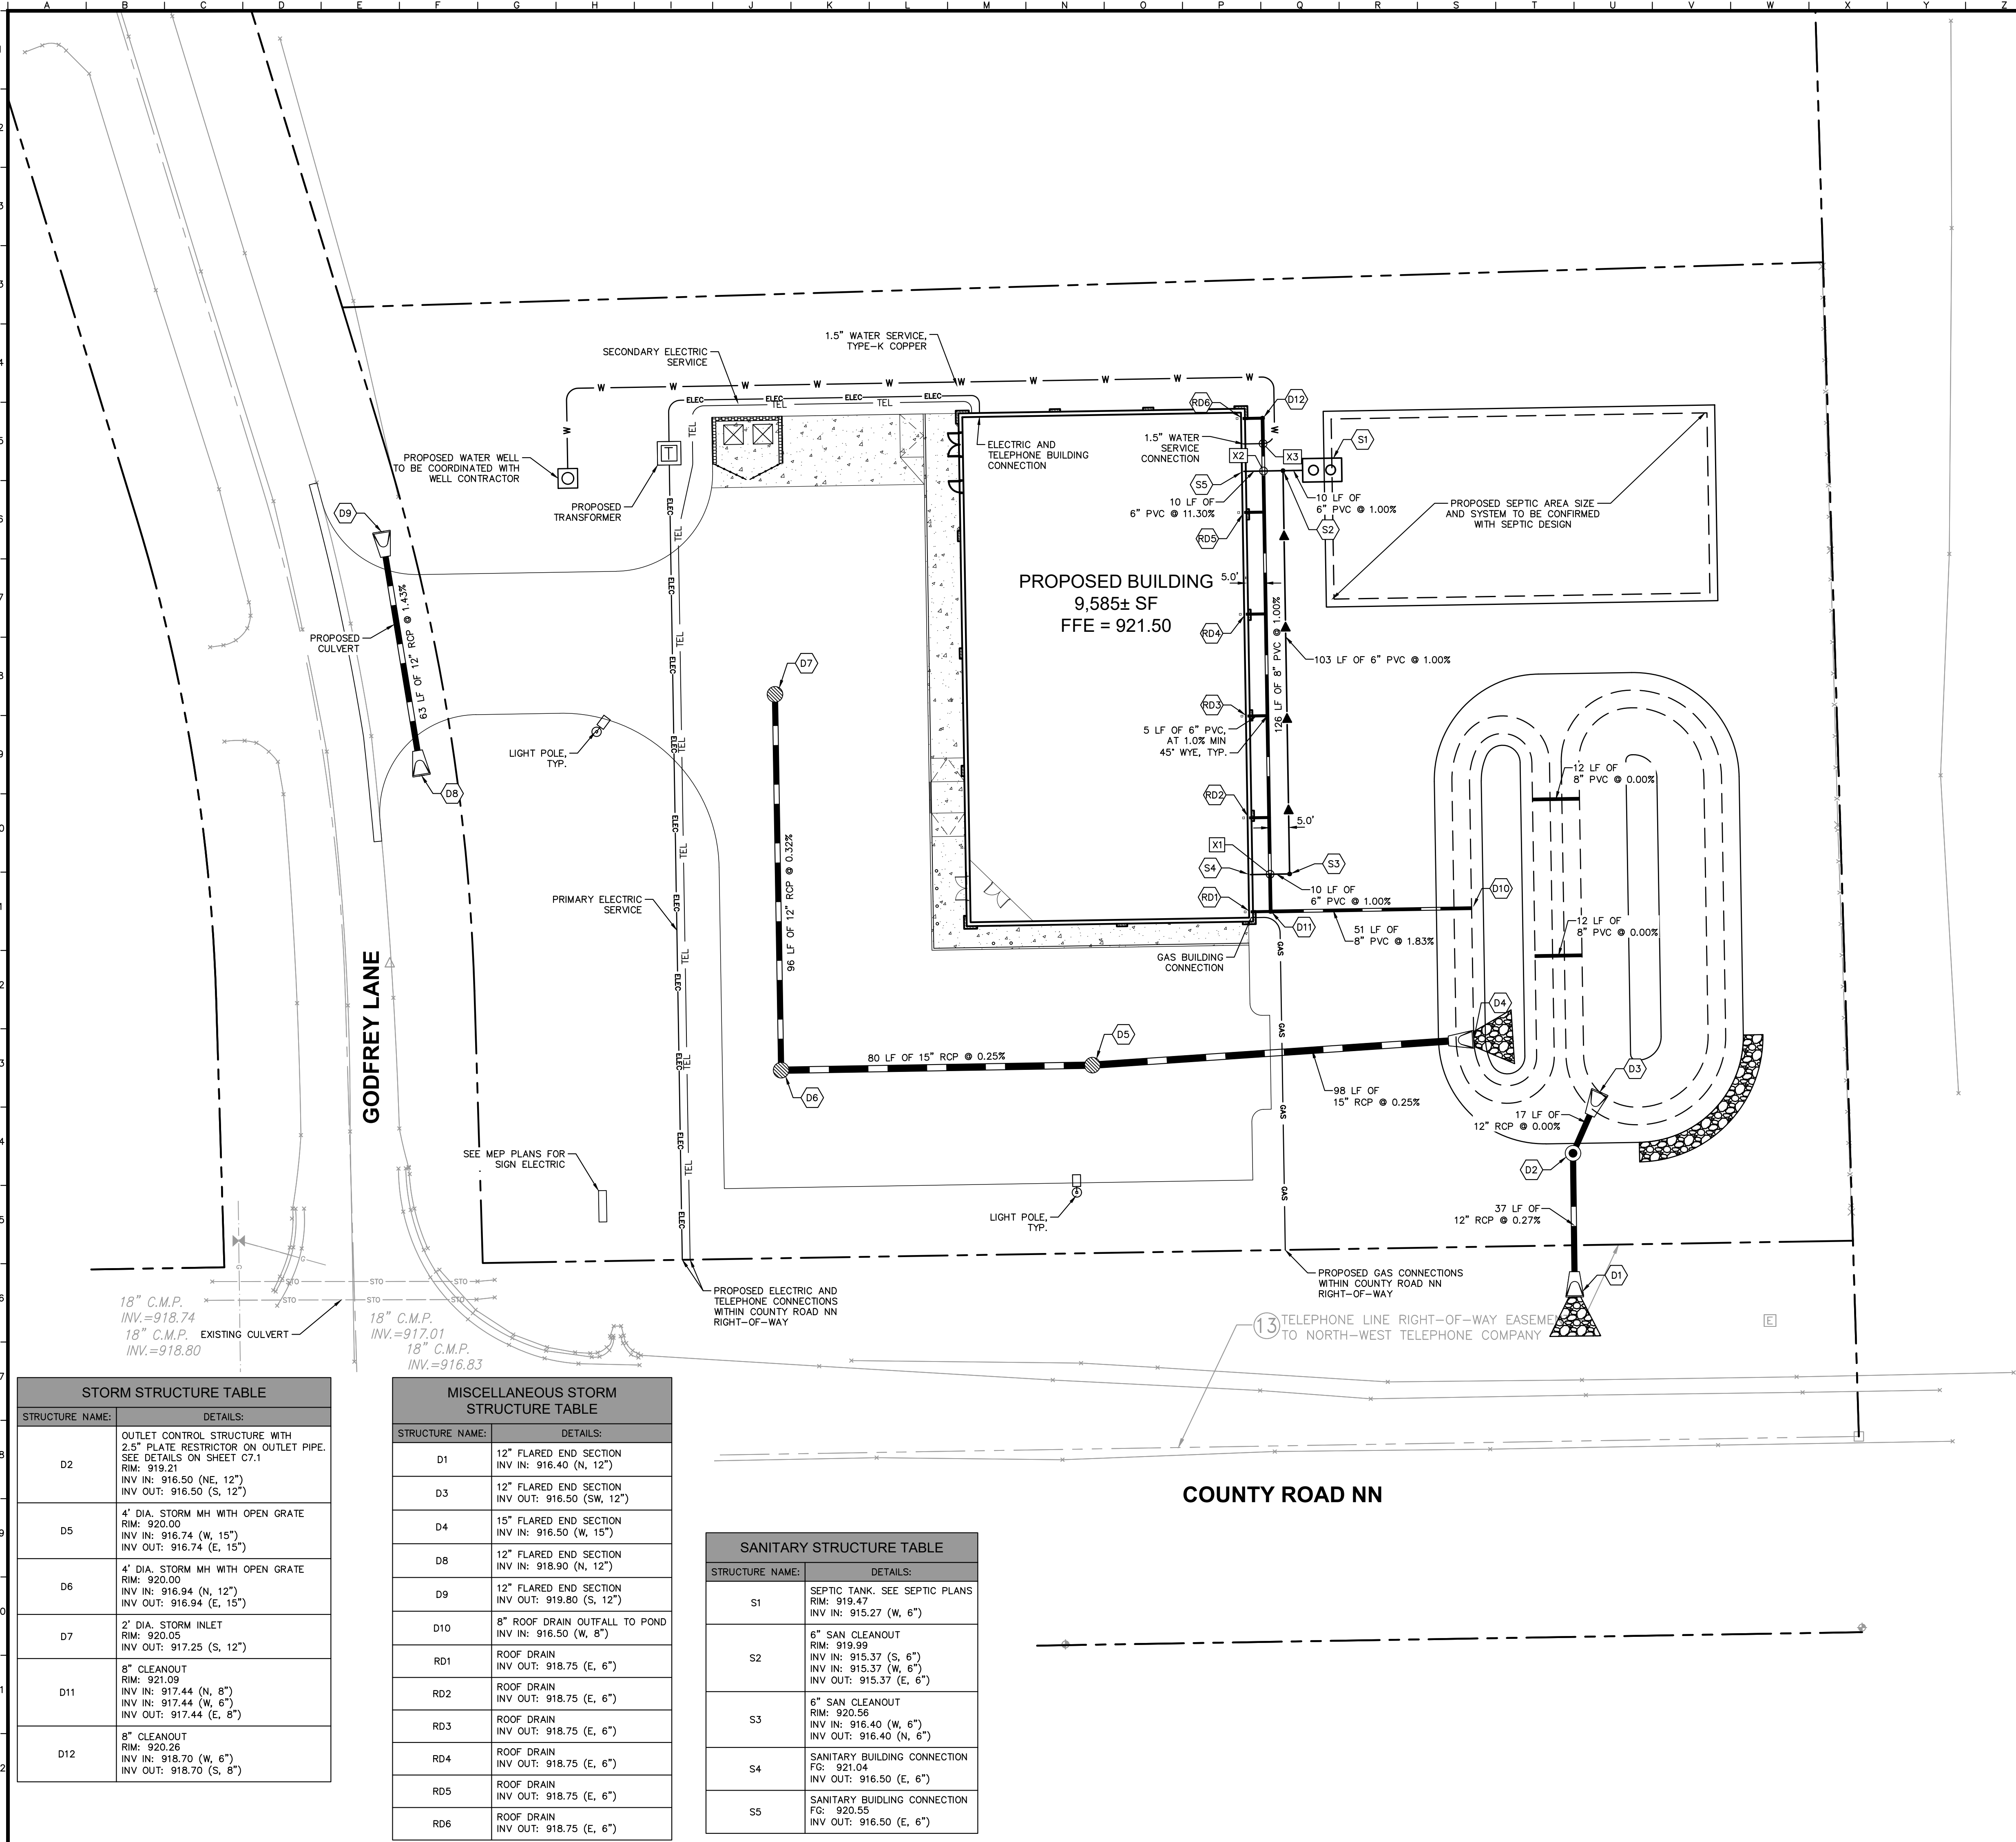
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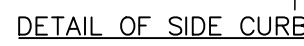


GENERAL NOTES:

1. THE MAXIMUM SLOPE OF THE SIDE FLARE FOR TYPE B RAMPS SHALL BE 1:10; HOWEVER, IF THE WIDTH OF THE LANDING AREA BETWEEN THE TOP OF THE RAMP AND AN OBSTRUCTION IS LESS THAN $1.2m$ (4'-0") THEN THE MAXIMUM SLOPE SHALL BE 1:12.
2. ALL SLOPE RATIOS ARE EXPRESSED AS UNITS OF VERTICAL DISPLACEMENT TO UNITS OF HORIZONTAL DISPLACEMENT (V:H).
3. ALL DIMENSIONS ARE IN INCHES UNLESS OTHERWISE SHOWN.
4. RAMP DETAILS TO BE COORDINATED PER VILLAGE REQUIREMENTS.
5. DETECTABLE WARNINGS SHALL CONSIST OF TRUNCATED DOMES WHICH CONTRAST VISUALLY WITH ADJOINING SURFACES, EITHER LIGHT-ON-DARK OR DARK-ON-LIGHT.
6. CONTRACTOR TO SELECT ADA DETECTABLE WARNING PERMEABLE PAVERS OR CONCRETE WITH ADA DETECTABLE WARNING DOMES FOR RAMPS.

LEGEND



-  SIDEWALK
 RAMP
 DETECTABLE WARNINGS
 NON WALKING AREA
 FACE OF BUILDING




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			DESIGNED BY:	JPM								
			DRAWN BY:	JPM								
			CHECKED BY:	JMM								
			<div>Kimley»Horn</div> <div>© 2020, KIMLEY-HORN AND ASSOCIATES, INC. 1000 KIMLEY-HORN WHITE, 600 WARRENVILLE, IL 60050 TEL: 630.261.5600 WWW.KIMLEY-HORN.COM</div>									
						1			TOWN COMMENTS			
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									JPM			
									DATE BY			

Drawing name: K:\GIS\LDS\168708007_DollarGeneral_Eggs_W\2 Design\CAD\PiaSheets\Final Engineering\07.0 - CONSTRUCTION DETAILS.dwg C7.1 Aug 17, 2020 8:04am by brethickey
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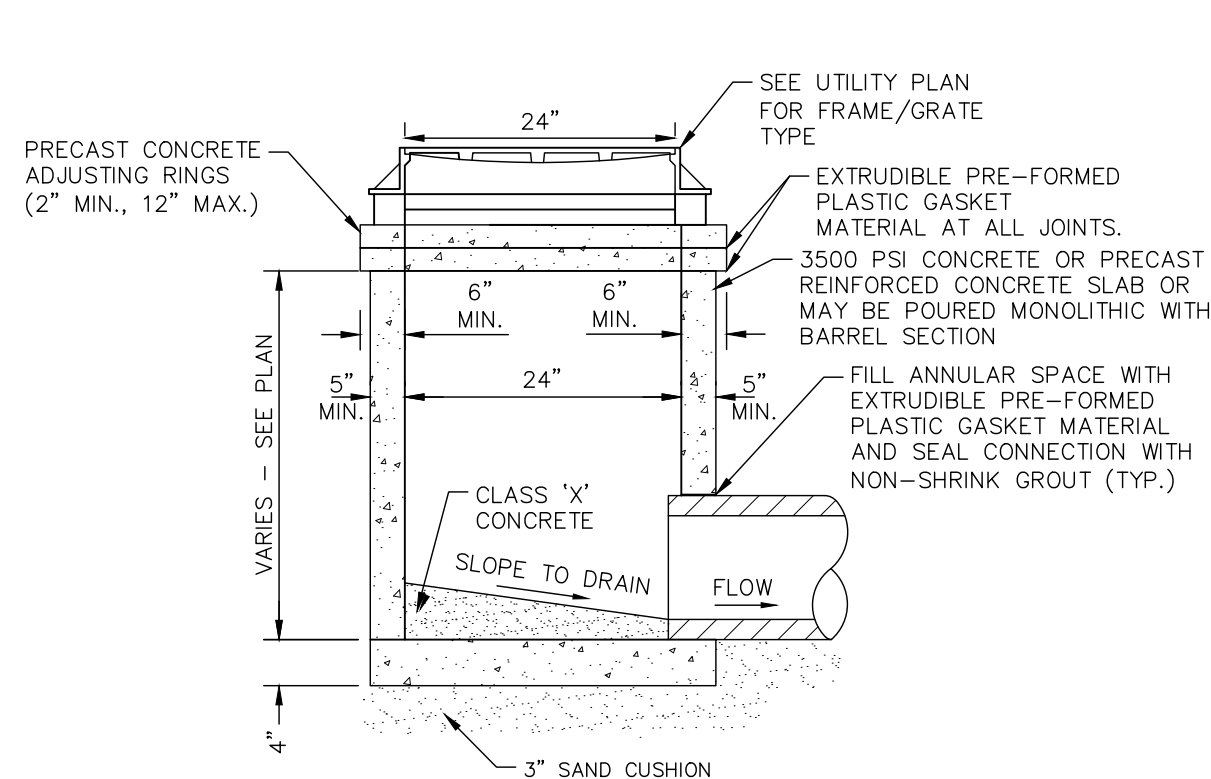
SDD 8f1 Apron Endwalls for Culvert Pipe

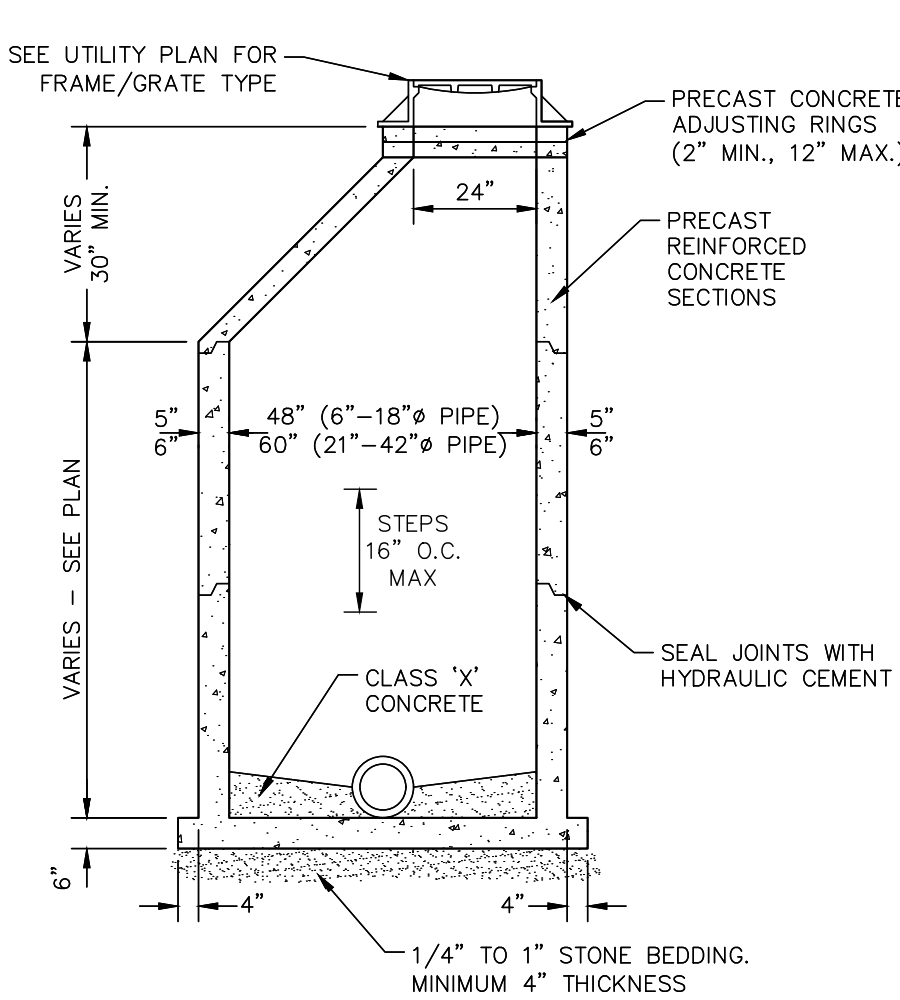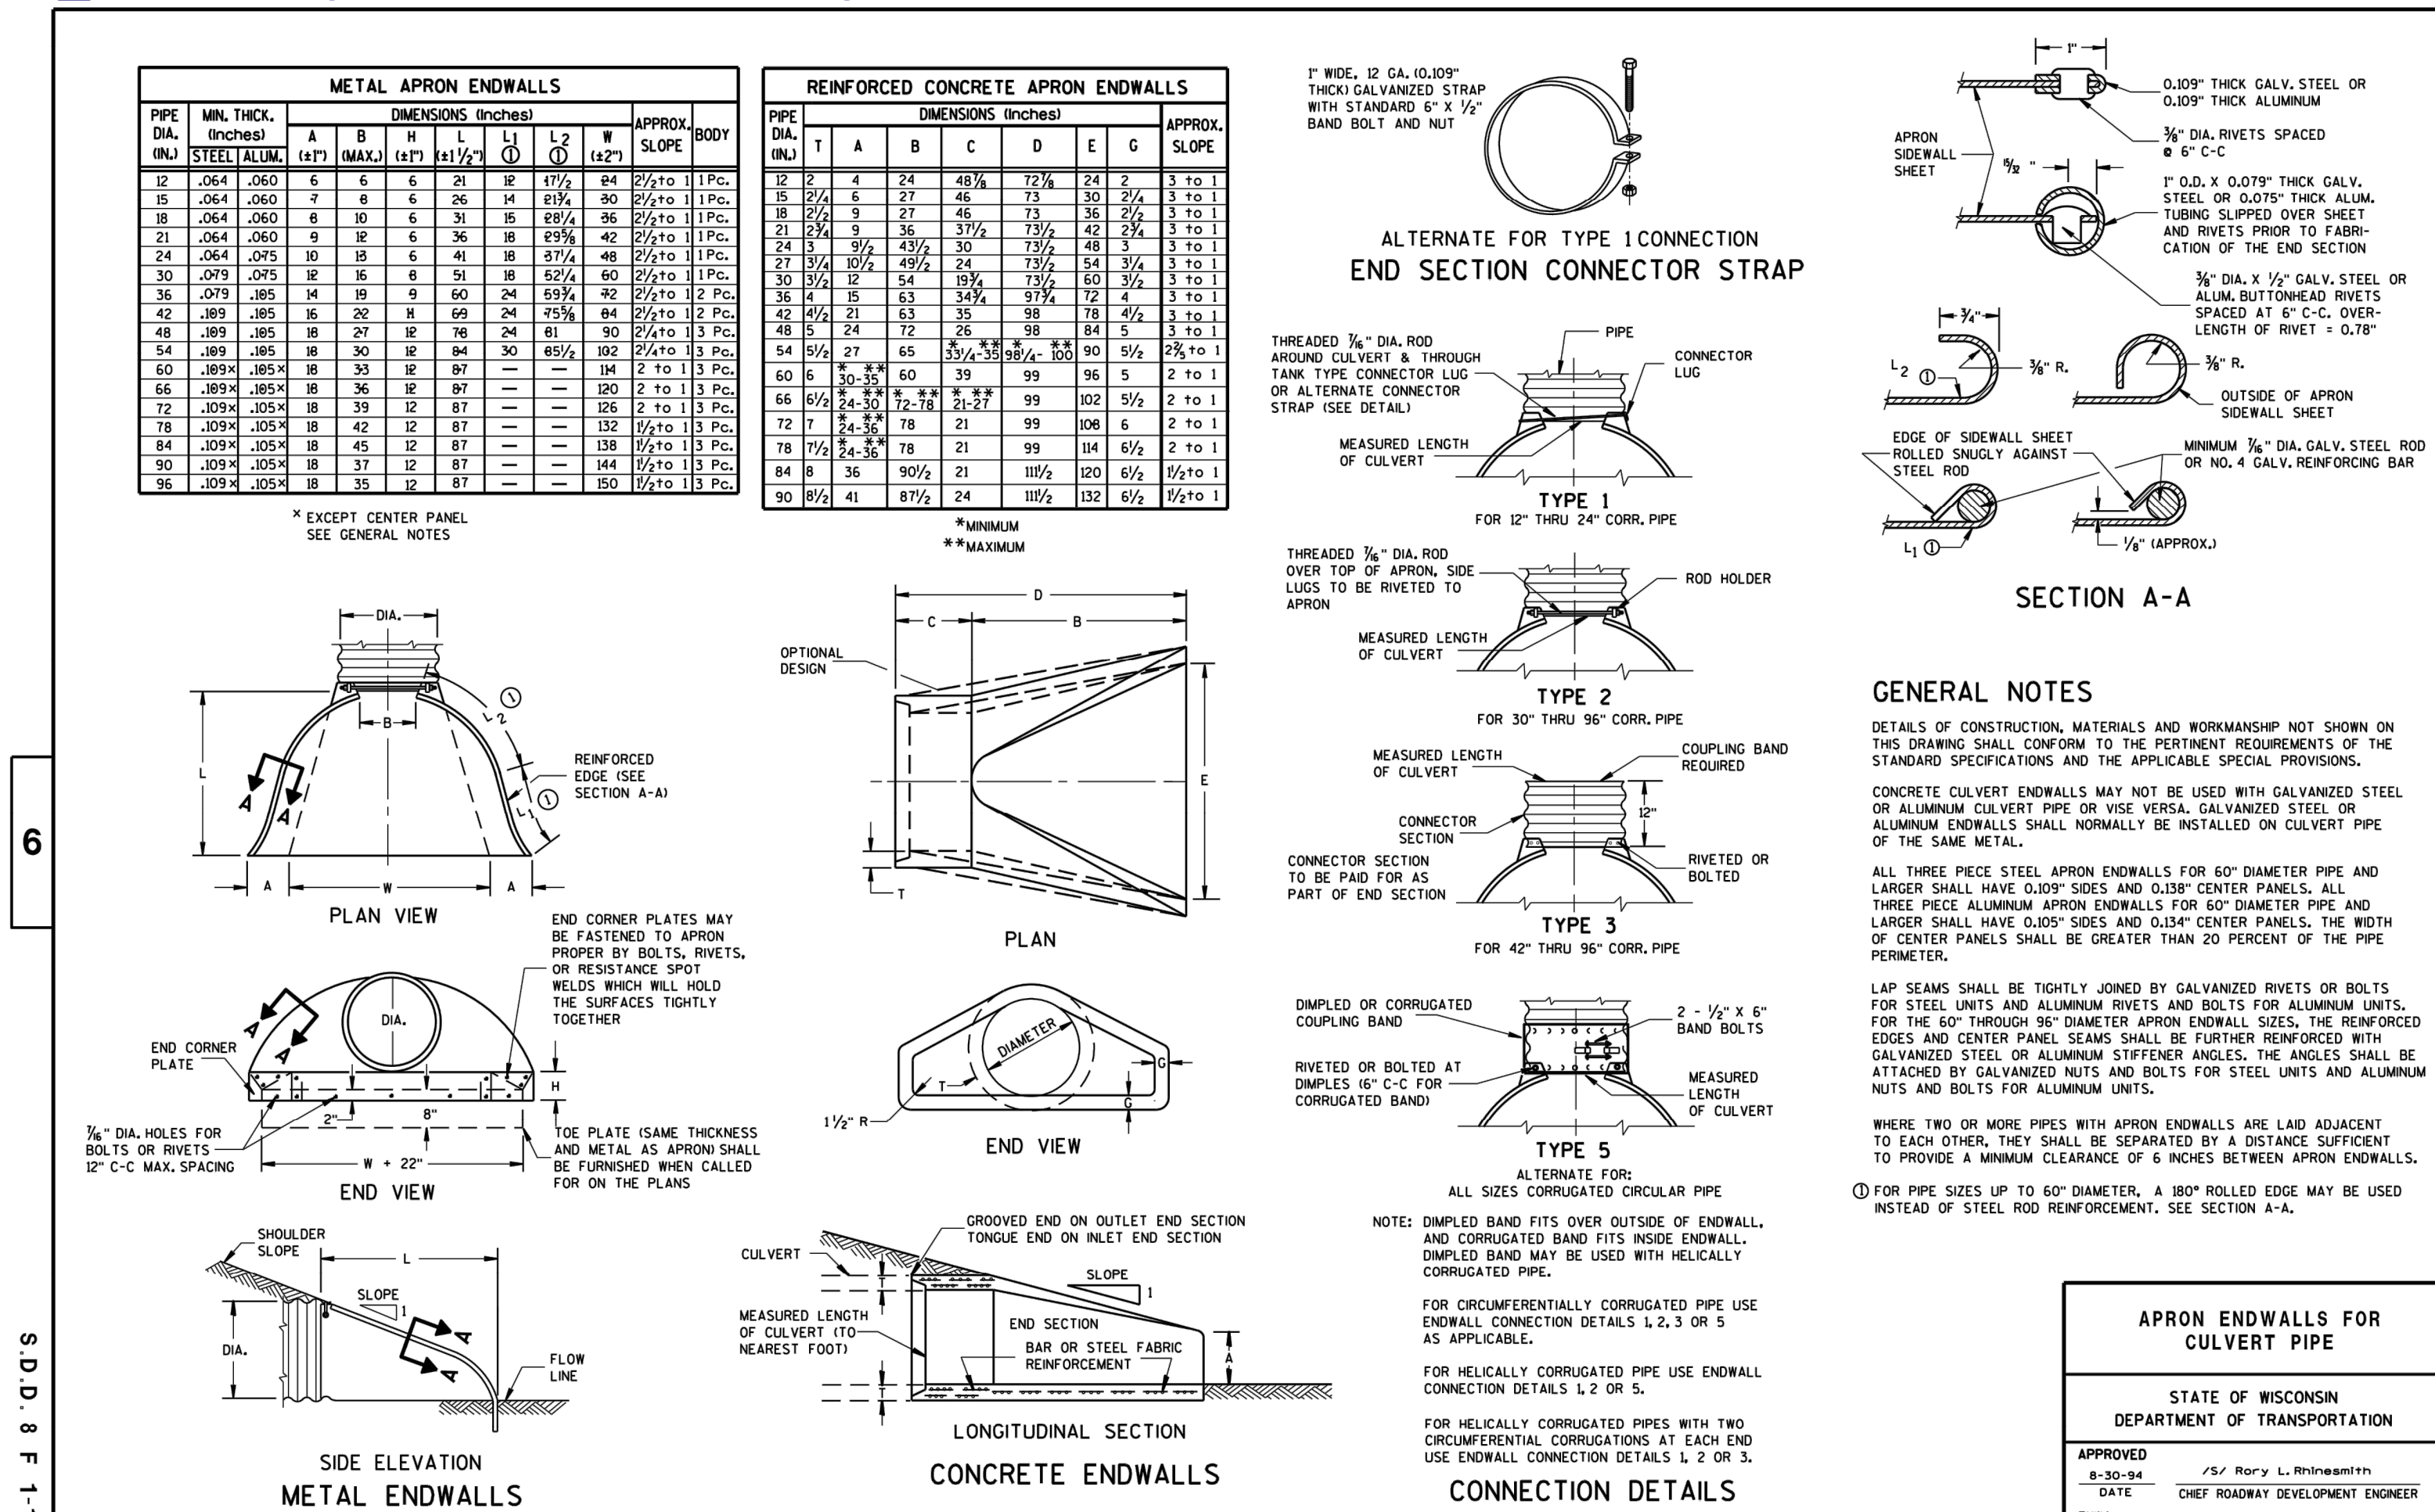


STORM MANHOLE TYPE A
N.T.S.

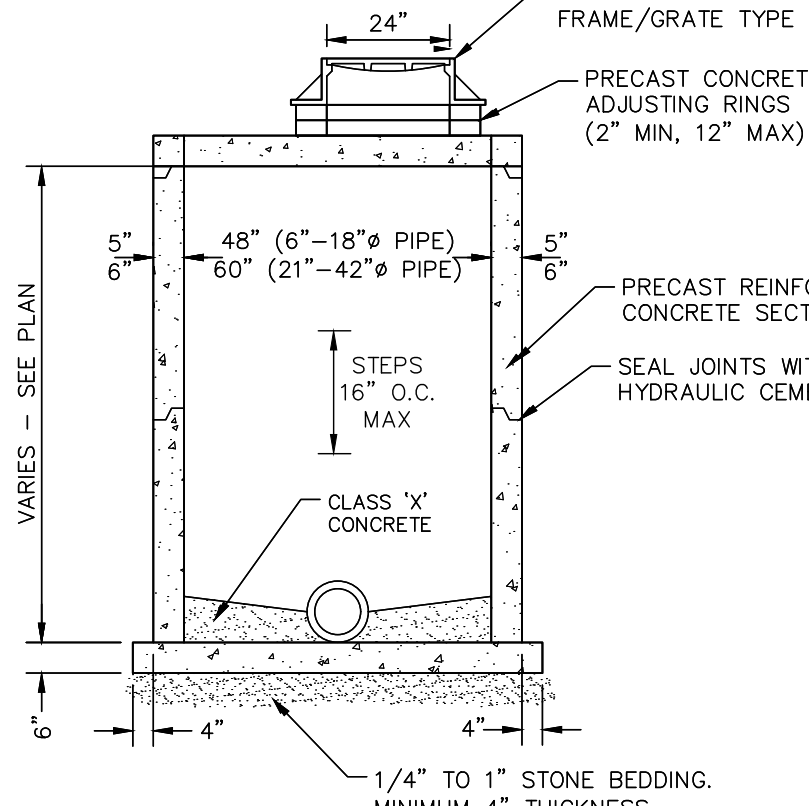


STORM MANHOLE (FLAT TOP)
N.T.S.



2' DIAMETER STORM INLET
N.T.S.

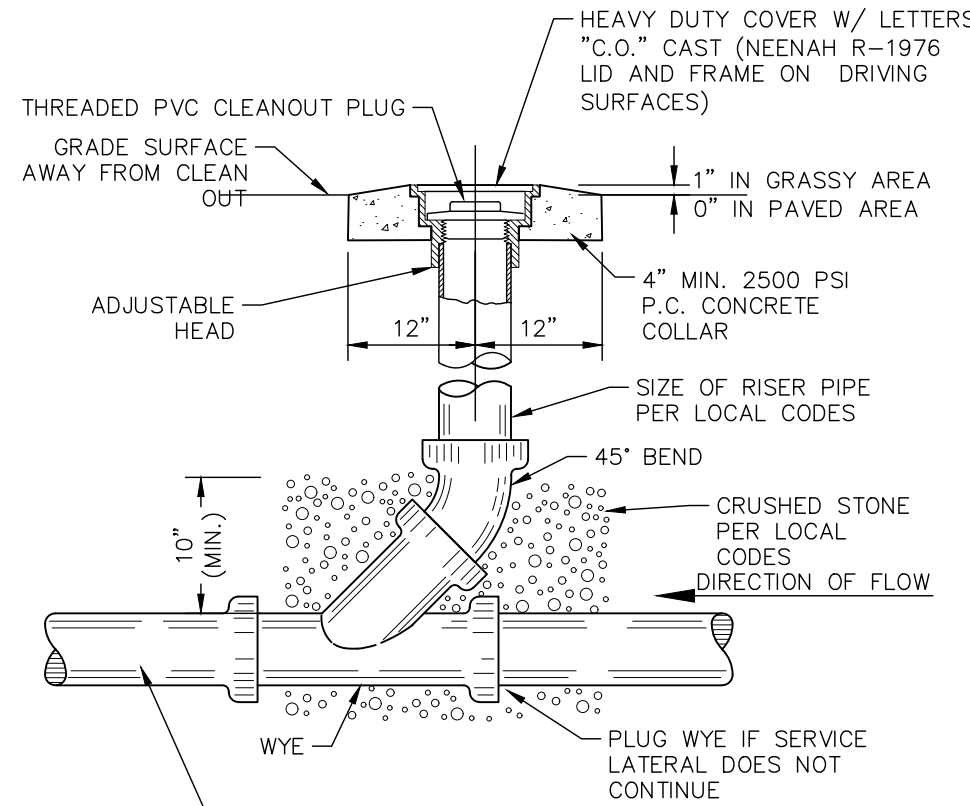


SANITARY/STORM CLEAN-OUT
N.T.S.

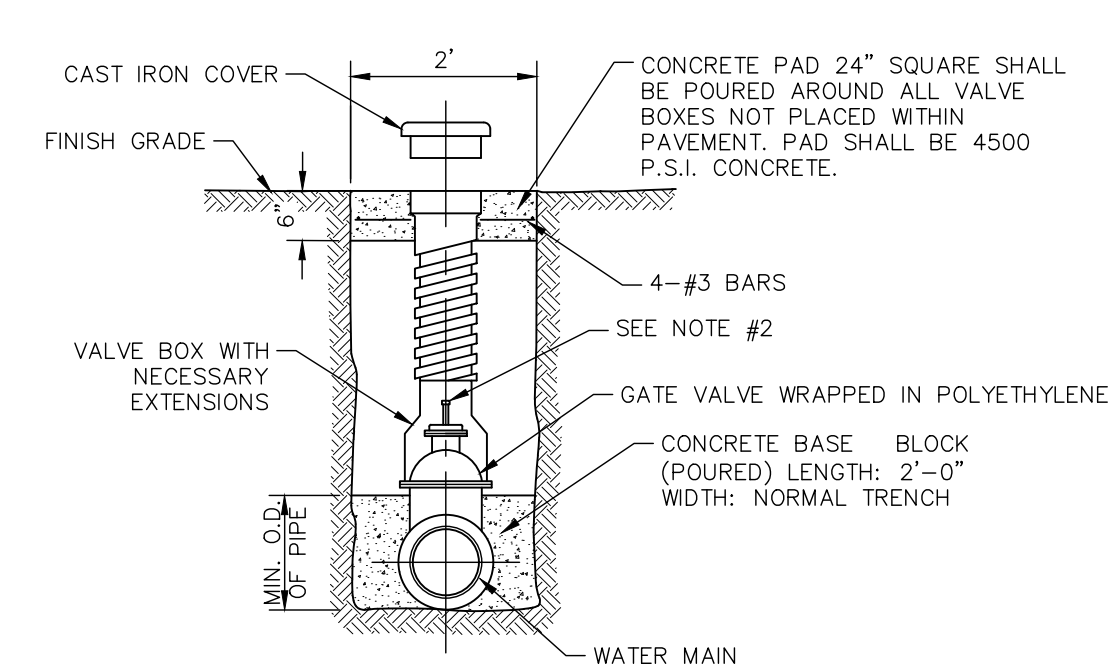

- NOTES:
1. 4"-12" R.S. GATE VALVES SHALL BE IN ACCORDANCE WITH AWWA STANDARD C-509.
 2. A PERMANENTLY ATTACHED VALVE EXTENSION STEM SHALL BE REQUIRED IF THE OPERATING NUT FOR ANY VALVE IS LOCATED IN EXCESS OF 4' BELOW THE TOP OF THE VALVE BOX. THIS EXTENSION SHALL BE SUFFICIENT LENGTH TO ENSURE THAT THE TOP IS WITHIN 4' OF THE VALVE BOX LID.
 3. DUCTILE IRON OR C-900 PVC PIPE SHALL BE USED FOR VALVE STACKS WITH VALVE BOX CASTING.
 4. PLACE A BLUE DOT (3") ON NEAREST CURB FACE TO VALVE.
 5. FOR GATE VALVES < 16" (FOR GATE VALVES ≥ 16" USE HORIZONTAL GATE VALVE)

TYPICAL VALVE SETTING AND BOX
N.T.S.

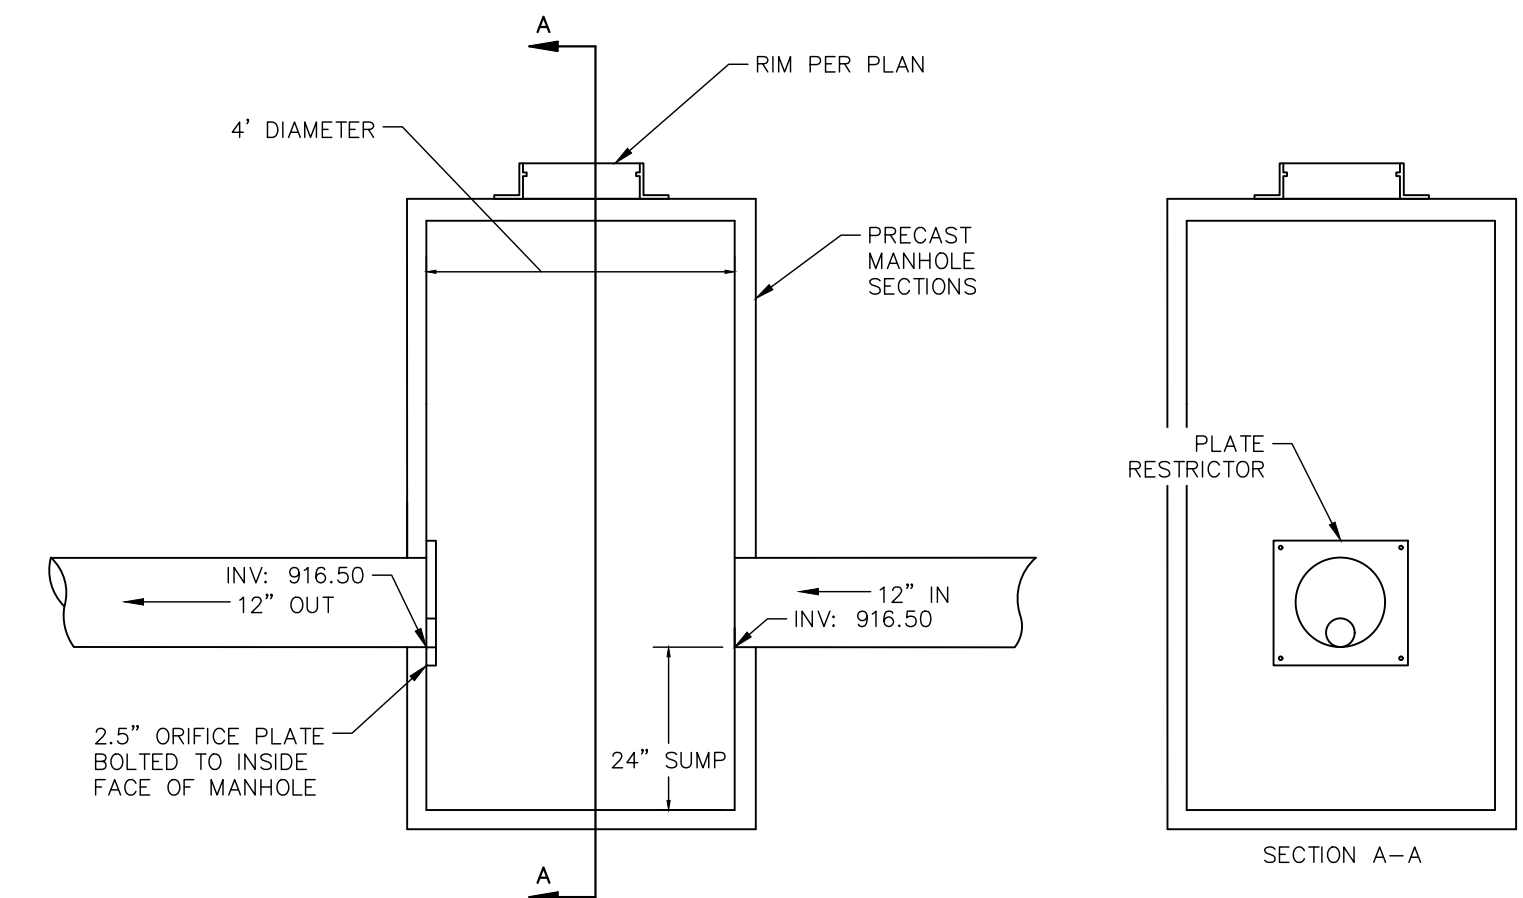

OUTLET CONTROL STRUCTURE (D2)
N.T.S.

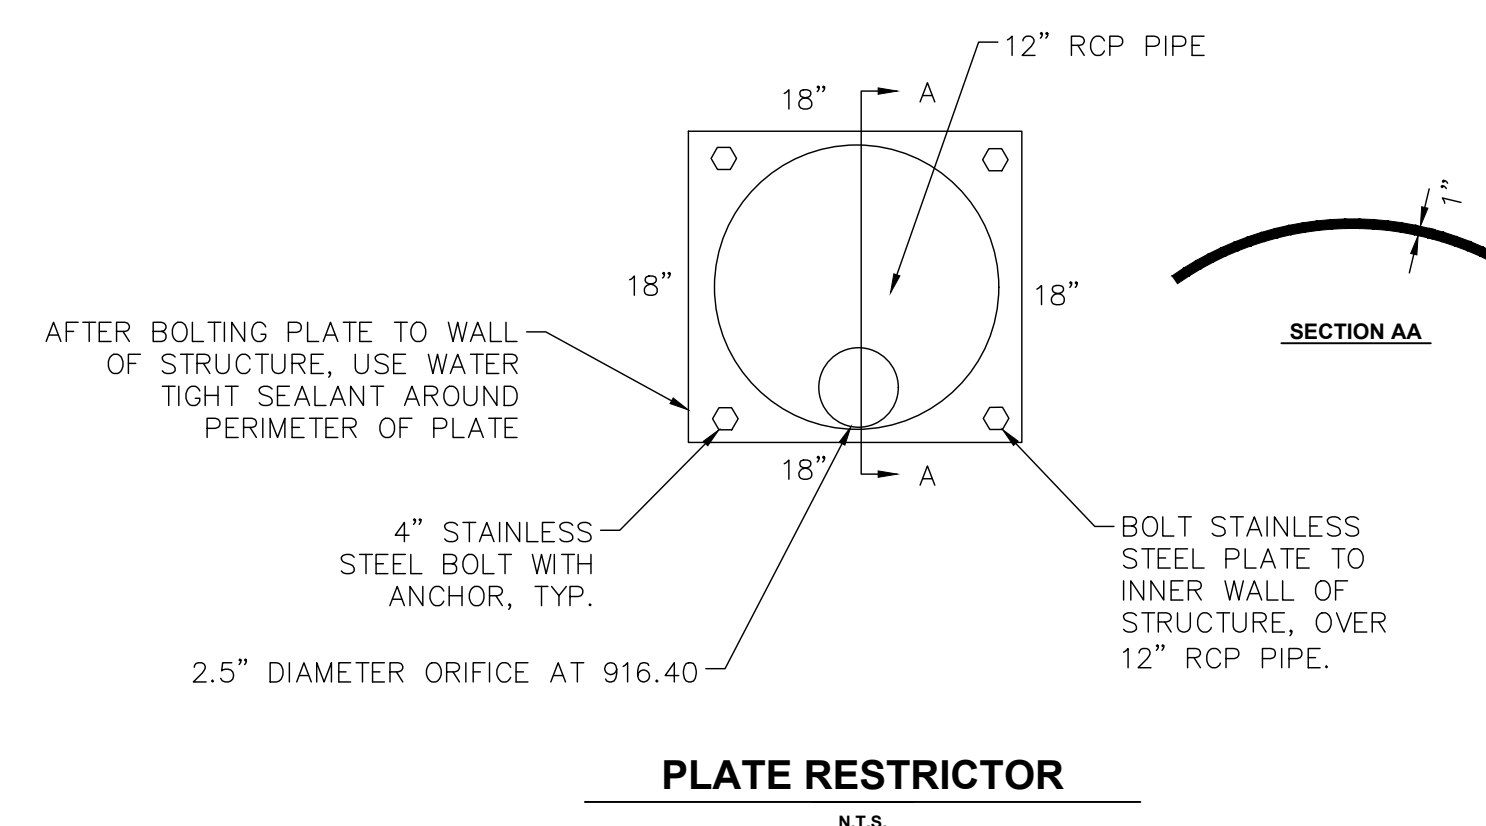


PLATE RESTRICTOR
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SCALE: AS NOTED
DESIGNED BY: JPM
DRAWN BY: JPM
CHECKED BY: JMM

**THE OVERLAND
GROUP**

**DOLLAR GENERAL
CONSTRUCTION
DETAILS**

ORIGINAL ISSUE:
07/29/2020
KHA PROJECT NO.
168708007
SHEET NUMBER

C7.1

Drawing name: K:\GIS\LDS\168708007_DollarGeneral_Eagle_WI\2_Design\CAD\PlanSheets\Final Engineering\L1.0 - LANDSCAPE PLAN.dwg Aug 17, 2020 9:04am by: brethickey
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MESIC LOW-PROFILE PRAIRIE SEED MIX



BOTANICAL NAME	COMMON NAME	LBS / ACRE	% OF TOTAL
GRASSES, SEDGES, & RUSHES			
Avena sativa	Common Oat	20.0	50.0%
Bouteloua curtipendula	Side-Oats Grama	5.0	12.5%
Lolium multiflorum	Annual Rye	10.0	25.0%
Panicum virgatum	Switch Grass	0.5	1.3%
Schizachyrium scoparium	Little Bluestem	4.0	10.0%
Sporobolus heterolepsis	Prairie Dropseed	0.25	0.6%
TOTAL LBS PER ACRE:		39.75	99.4%
FORBS & BROADLEAVES			
Coreopsis palmata	Prairie Coreopsis	0.10	0.3%
Echinacea purpurea	Purple Coneflower	0.15	0.4%
FORBS & BROADLEAVES LBS PER ACRE:		0.25	0.6%
SEED MIX TOTAL LBS PER ACRE:		40.00	

WET-MESIC PRAIRIE PLUG MIX

BOTANICAL NAME	COMMON NAME	QTY / ACRE	% OF TOTAL
Bouteloua curtipendula	Side Oats Grama	750	15%
Echinacea purpurea	Purple Coneflower	500	10%
Elymus canadensis	Canada Wild Rye	1,000	20%
Juncus effusus	Common Rush	750	15%
Panicum virgatum	Switch Grass	1,500	30%
Rudbeckia hirta	Black-Eyed Susan	500	10%
TOTAL PLUGS PER ACRE:		5,000	

PLANT SCHEDULE

TREES		CODE	QTY	BOTANICAL / COMMON NAME	CONT	CAL	SIZE	
	AA2	3	ACER FREEMANII 'AUTUMN BLAZE' / AUTUMN BLAZE MAPLE	B & B	2"	CAL MIN		
	PA	4	PICEA ABIES / NORWAY SPRUCE	B & B		4' HT MIN		
	PF	7	PINUS FLEXILIS 'VANDERWOLF'S PYRAMID' / VANDERWOLF'S PYRAMID PINE	B & B		4' HT MIN		
	TM	2	TILIA AMERICANA 'MCKSENTRY' / SENTRY LINDEN	B & B	2"	CAL MIN		
SHRUBS		CODE	QTY	BOTANICAL / COMMON NAME	CONT	SPACING	SIZE	SPACING
	AI2	20	ARONIA MELANOCARPA 'IROQUOIS BEAUTY' / BLACK CHOKEBERRY	-	SEE PLAN	36" HT MIN	48" o.c.	
	JF2	9	JUNIPERUS CHINENSIS 'FAIRVIEW' / FAIRVIEW JUNIPER	-	SEE PLAN	5' HT MIN	60" o.c.	
	SF	9	SPIRAEA JAPONICA 'NEON FLASH' / NEON FLASH SPIREA	-	SEE PLAN	18" HT MIN	48" o.c.	
	TT	37	TAXUS X MEDIA 'TAUNTONII' / TAUTON YEW	-	SEE PLAN	24" HT MIN	48" o.c.	
SHRUB AREAS		CODE	QTY	BOTANICAL / COMMON NAME	CONT	SPACING		
	JE	358	JUNCUS EFFUSUS / COMMON RUSH	2" PLUG	24" o.c.			
GROUND COVERS				BOTANICAL / COMMON NAME				
			MESIC LOW-PROFILE PRAIRIE SEED MIX					
			TURF SEED					
			WET-MESIC PRAIRIE PLUG MIX					

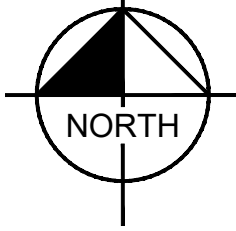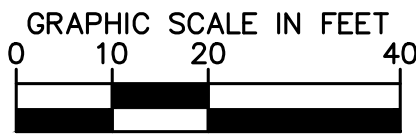

LANDSCAPE CODE		
CODE	REQUIRED	PROVIDED
STREET FRONTAGE		
60 POINTS FOR EVERY 100 LF	350/100=3.5*60=210	2 TALL DECIDUOUS TREES=60 4 EVERGREEN TREES=160 220 POINTS
BUILDING FOUNDATION		
25 POINTS FOR EVERY 100 FEET OF BUILDING FOUNDATION PERIMETER	400/100=4*25=100	1 EVERGREEN TREE=40 12 MEDIUM EVERGREEN SHRUBS=60 100 POINTS
PARKING LOT LANDSCAPE		
120 POINTS FOR EVERY 10,000 SF OF PAVED AREA	16,510.58/10,000=1.65*120=198 POINTS	3 TALL DECIDUOUS TREE=90 15 TALL DECIDUOUS SHRUBS=75 7 MEDIUM EVERGREEN SHRUBS=35 200 POINTS
INTERIOR PARKING LOT LANDSCAPE		
10 POINTS FOR EVERY 1,000 SF OF BUILDING FLOOR AREA	9,100 SF/1,000=9 POINTS	9 LOW DECIDUOUS SHRUBS=9 9 POINTS

*SCREENING OF UTILITIES PROVIDED
ADDITIONAL LANDSCAPE PROVIDED FOR SCREENING (SOUTH AND EAST SIDE)

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07/29/2020
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SHEET NUMBER

DOLLAR GENERAL
NEC HIGHWAY NN & GODFREY LN.
TOWN OF EAGLE, WI 53119

LANDSCAPE
PLAN

THE OVERLAND
GROUP

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1	08/14/20	JPM		

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- SHREDDED HARDWOOD MULCH
- EXCAVATED BACKFILL
- TAMPED BACKFILL
- SUBGRADE




1. APPLY CORRECTIVE PRUNING.
2. SET ROOT BALL OR CONTAINER ON UNEXCAVATED OR TAMPED SOIL. TOP OF ROOTBALL (CONTAINER) SHALL BE ONE INCH ABOVE SURROUNDING GRADE. FOR LARGER SHRUBS, EXCAVATE AND PLANTING BED TO A DEEPER PIT ONLY FOR THOSE SHRUBS.
3. REMOVE BURLAP FROM TOP HALF THE LENGTH OF ROOTBALL, TWINE AND (IF USED) SYNTHETIC MATERIAL SHALL BE REMOVED FROM PLANTING BED. FOR CONTAINER GROWN SHRUBS, REMOVE CONTAINER AND LOOSEN ROOTS PRIOR TO INSTALLATION.
4. REMOVE OR CORRECT GIRDLING ROOTS.
5. FILL BED AND BACKFILL WITH AMENDED SOIL PER LANDSCAPE NOTES. WATER THOROUGHLY WITHIN TWO HOURS.
6. APPLY MULCH IN EVEN LAYER, KEEPING AWAY FROM ROOT FLARE. MULCH LIMITS FOR SHRUBS EXTEND TO ALL LIMITS OF PLANTING BED. SEE PLANS FOR BED LAYOUTS.



NTS

1. THE LANDSCAPE CONTRACTOR SHALL BE RESPONSIBLE FOR INSTALLING MATERIALS AND PLANTS SHOWN ON THE LANDSCAPE PLAN. THE CONTRACTOR IS RESPONSIBLE FOR THE COST TO REPAIR UTILITIES, ADJACENT LANDSCAPE, PUBLIC AND PRIVATE PROPERTY THAT IS DAMAGED BY THE CONTRACTOR OR THEIR SUBCONTRACTOR'S OPERATIONS DURING INSTALLATION OR DURING THE SPECIFIED MAINTENANCE PERIOD. CALL FOR UTILITY LOCATIONS PRIOR TO ANY EXCAVATION.
2. THE CONTRACTOR SHALL REPORT ANY DISCREPANCY IN PLAN VS. FIELD CONDITIONS IMMEDIATELY TO THE LANDSCAPE ARCHITECT, PRIOR TO CONTINUING WITH THAT PORTION OF WORK.
3. THE CONTRACTOR SHALL BE RESPONSIBLE FOR THE REPAIR OF ANY OF THEIR TRENCHES OR EXCAVATIONS THAT SETTLE.
4. ALL NURSERY STOCK SHALL BE WELL BRANCHED, HEALTHY, FULL, PRE-INOCULATED AND FERTILIZED. DECIDUOUS TREES SHALL BE FREE OF FRESH SCARS. TRUNKS WILL BE WRAPPED IF NECESSARY TO PREVENT SUN SCALD AND INSECT DAMAGE. THE LANDSCAPE CONTRACTOR SHALL REMOVE THE WRAP AT THE PROPER TIME AS A PART OF THIS CONTRACT.
5. ALL NURSERY STOCK SHALL BE GUARANTEED, BY THE CONTRACTOR, FOR ONE YEAR FROM DATE OF FINAL INSPECTION.
6. AMENDED SOIL SHALL BE PROVIDED AND GRADED BY THE GENERAL CONTRACTOR UP TO 6 INCHES BELOW FINISHED GRADE IN TURF AREAS AND 18 INCHES IN PLANTING AREAS.
7. PLANTING AREA SOIL SHALL BE AMENDED WITH 25% SPHAGNUM PEATMOSS, 5% HUMUS AND 65% PULVERIZED SOIL FOR ALL SHRUB, ORNAMENTAL GRASS, PERENNIAL AND ANNUAL BEDS. AMENDED TURF AREA SOIL SHALL BE STANDARD TOPSOIL.
8. SEED/SOD LIMIT LINES ARE APPROXIMATE. CONTRACTOR SHALL SEED/SOD ALL AREAS WHICH ARE DISTURBED BY GRADING WITH THE SPECIFIED SEED/SOD MIXES.
9. CONTRACTOR SHALL INSTALL SHREDDED HARDWOOD MULCH AT A 3" DEPTH TO ALL TREES, SHRUB, PERENNIAL, AND GROUND COVER AREAS. TREES PLACED IN AREA COVERED BY TURF SHALL RECEIVE A 4 FT WIDE MAXIMUM TREE RING WITH 3" DEPTH SHREDDED HARDWOOD MULCH. A SPADED BED EDGE SHALL SEPARATE MULCH BEDS FROM TURF OR SEEDED AREAS. A SPADED EDGE IS NOT REQUIRED ALONG CURBED EDGES.
10. INSTALLATION OF TREES WITHIN PARKWAYS SHALL BE COORDINATED IN THE FIELD WITH LOCATIONS OF UNDERGROUND UTILITIES. TREES SHALL NOT BE LOCATED CLOSER THAN 5' FROM UNDERGROUND UTILITY LINES AND NO CLOSER THAN 10' FROM UTILITY STRUCTURES.
11. DO NOT DISTURB THE EXISTING PAVING, LIGHTING, OR LANDSCAPING THAT EXISTS ADJACENT TO THE SITE UNLESS OTHERWISE NOTED ON PLAN.
12. PLANT QUANTITIES SHOWN ARE FOR THE CONVENIENCE OF THE OWNER AND JURISDICTIONAL REVIEW AGENCIES. THE CONTRACTOR IS RESPONSIBLE FOR VERIFYING ALL PLANT QUANTITIES AS DRAWN.
13. THE OWNER'S REPRESENTATIVE MAY REJECT ANY PLANT MATERIALS THAT ARE DISEASED, DEFORMED, OR OTHERWISE NOT EXHIBITING SUPERIOR QUALITY.
14. THE CONTINUED MAINTENANCE OF ALL REQUIRED LANDSCAPING SHALL BE THE RESPONSIBILITY OF THE OWNER OF THE PROPERTY ON WHICH SAID MATERIALS ARE REQUIRED. ALL PLANT MATERIALS REQUIRED BY THIS SECTION SHALL BE MAINTAINED AS LIVING VEGETATION AND SHALL BE PROMPTLY REPLACED IF THE PLANT MATERIAL HAS DIED PRIOR TO FINAL ACCEPTANCE. PLANTING AREAS SHALL BE KEPT FREE OF TRASH, LITTER, AND WEEDS AT ALL TIMES.

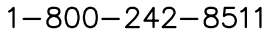

<p>DOLLAR GENERAL</p> <p>ORIGINAL ISSUE: 07/29/2020</p> <p>KHA PROJECT NO. 168708007</p> <p>SHEET NUMBER</p>	<p>LANDSCAPE NOTES AND DETAILS</p>	<p>THE OVERLAND GROUP</p>	<p>Kimley»Horn 3200 WILSON ROAD AND ASSOCIATES, INC. 500 WILSON ROAD, SUITE 400 WARRENVILLE, IL 60055 TEL: 630.381.1100 WWW.KIMLEY-HORN.COM</p>	SCALE:	
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				CHECKED BY: JMM	
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		<p>No.</p>		<p>BY</p>	